

Case File Number: ER12-0007, CMDV13-194 & TPM10164

September 11, 2013

Location:	3001-3039 Broadway (APN's: 009-0705-004-00; - 005-00; -006-00; & -007-00)
Proposal:	Public Hearing on the Draft Environmental Impact Report to obtain comments on the environmental analysis related to the proposed commercial development at the northwest corner of Broadway & 30 th Street. The project would redevelop the existing 1.9 acre parking lot (formerly used as a surface lot for a used auto dealership and currently being used as temporary construction parking for Alta Bates) with the new construction of a one-story approximately 36,000 square foot development that would include a Sprouts Farmers Market grocery store of approximately 26,000 square feet and approximately 10,000 square feet of additional ground floor commercial space. The project would contain auto access off of 30 th Street and provide 162 parking spaces in both ground level parking (18 spaces) and a rooftop parking deck (144 spaces).
Applicant:	Lowney Architects
Contact Person:	Ken Lowney - (510)836-5400
Owner:	30 th & Broadway LLC (Portfolio Development Partners LLC)
Planning Permits Required:	Major Conditional Use permits (New Construction in excess of 10,000 square feet, Alcohol Sales, and a Master Sign Program), Regular Design Review for new construction, Minor Variances for exceeding the maximum front setback of 10 feet for more than 50% of the frontage to create a plaza, for not meeting the minimum conditionally permitted building height of 25 feet, and required loading berths (2 required; 1 proposed), and a Tentative Parcel Map for merging four lots into one.
General Plan:	Community Commercial
Zoning:	CC-2, Community Commercial Zone – 2 (Height Area – 75) D-BR, Broadway Retail Frontage Zone
Environmental Determination:	Draft Environmental Impact Report was published for a 45-day review period from August 16, 2013 to September 30, 2013.
Historic Status:	Vacant Lot
Service Delivery District:	2
City Council District:	3
Action to be Taken:	Receive public and Planning Commission comments on the Draft Environmental Impact Report

SUMMARY

Ken Lowney Architects, on behalf of 30th & Broadway LLC (Portfolio Development Partners LLC), has filed an environmental review application to begin review and consideration of a proposal to develop a commercial project on an existing 1.9 acre parking lot that would include a new 36,000 square foot development that would include a 26,000 square foot Sprouts Farmer's Market grocery store and an additional 10,000 square feet of ground floor commercial. The site is currently a vacant asphalt parking lot that was previously used as part of a used car dealership, but is currently being used as temporary construction parking for Alta Bates. The proposal would

include auto access off of 30th Street with parking located behind the storefronts on the ground floor (18 spaces) and also located on the roof deck of the building (144 stalls) for a total of 162 off-street parking stalls. The loading will occur to the side and rear of the commercial spaces with a loading truck exit onto Broadway, which will only be used by departing trucks.

The City is the Lead Agency pursuant to the California Environmental Quality Act (CEQA) and has the responsibility to prepare the Environmental Impact Report (EIR) for the Project. Staff published a Notice of Preparation (NOP) of an EIR on July 27, 2012. A scoping session was held before the Oakland Planning Commission on August 29, 2012. Also, on June 26, 2013, the project was considered before the Planning Commission's Design Review Committee.

The Notice of Availability for the Draft EIR was prepared and released on August 16, 2013 beginning a 45 day public comment period. The public comment period ends on September 30, 2013.

Comments on the Draft EIR may be made at the September 11, 2013 public hearing or in writing to the Department of Planning & Building, Planning Division, to the attention of Peterson Vollmann. Written comments must be received prior to the comment period deadline (4:00 p.m. on September 30, 2013). After all comments are received, a Final EIR/Response to Comments document will be prepared and the Planning Commission will consider certification of the Final EIR at a later meeting.

The purpose of this hearing is to solicit comments on the adequacy of specific environmentally-related information, issues and analysis contained in the document. This meeting is not intended to take comments on the merits of the Project and no decisions will be made on the EIR or proposed Project at this hearing. Specifically, comments on the Draft EIR should focus on the adequacy of the EIR in discussing possible impacts on the physical environment, ways in which potential adverse effects might be minimized, and alternatives to the Project in light of the EIR's purpose to provide useful and accurate information about such factors.

SITE DESCRIPTION

Existing Site Conditions

The proposed project site is a 1.9 acre (83,143 square feet) lot at 3001 – 3039 Broadway at the northwestern corner of the intersection of Broadway and 30th Street in the Broadway Auto Row area of the City. The site is currently vacant and void of any permanent structures, and only contains asphalt paving and striping for the previous used car dealership that occupied the location and is now being used temporarily as construction parking for Alta Bates.

The western end of the site is a tall concrete retaining wall which is the back side of the adjacent skilled nursing facility for seniors.

The northern boundary of the site adjoins another asphalt parking lot for the northern adjacent Bay City car dealership that operates at the corner of Broadway and Hawthorne Street.

Surrounding Area

The project site is located in the Broadway Auto Row Commercial District in Oakland at the intersection of Broadway and 30th Street. The surrounding area includes a mix of health-related institutional, automotive sales and service, and commercial entertainment and dining uses.

The project site is also located within the northern end of the proposed Broadway Valdez Specific Plan (BVDSP) area, for which the City is preparing a vision and planning framework for the future growth and development of the area along Broadway between I-580 to the north and Grand Avenue to the south.

PROJECT DESCRIPTION

The Project involves the development of a new, one-story development with 36,000 square feet of high volume retail space and associated parking. Specifically, the proposed development would include a 26,000 square-foot retail grocery store anchor tenant, Sprouts Farmers Market, and an additional 10,000 square feet of ground floor commercial space. All retail areas would be oriented along Broadway and would be primarily accessed through a public plaza connected to the sidewalk along Broadway (the development would be located within one single structure though visibly appearing as two separate buildings from the street – the DEIR refers to the project as two separate buildings at times, which will be clarified in the Final EIR/Response to Comment Document). Public-realm amenities proposed include landscaping, a public gathering area with café style seating for customers, as well as a plaza and garden seating for customers on the rooftop level. A total of 162 parking spaces would be provided in both the ground level parking area(18 spaces behind the retail tenant spaces), and on a rooftop parking deck accessed from an internal ramp (144 spaces). All vehicular access to the project site would be from a driveway on 30th Street, and service vehicles/trucks would exit the site and internal loading dock area via a driveway on Broadway.

GENERAL PLAN

The General Plan's Land Use and Transportation Element (LUTE) classifies the project site as being located in a Community Commercial General Plan area. This land use classification is intended to create, maintain, and enhance areas suitable for a wide variety of commercial and institutional operations along the City's major corridors and in shopping districts and centers. The Community Commercial districts may include Neighborhood Center uses and larger scale retail and commercial uses, such as auto related businesses, business and personal services, health services and medical uses, educational facilities, and entertainment uses.

ZONING COMPLIANCE

The subject property is located within a CC-2, Community Commercial Zone-2, and is within a Height/Intensity Area 75. The CC-2 zone is intended to create, maintain, and enhance areas with a wide range of commercial businesses with direct frontage and access along the City's corridors and commercial areas. The 75 Height/Intensity Area allows a Floor Area Ratio (FAR) of 4.0 and a building height of 75 feet, and requires a minimum of 35 feet, which may be reduced to 25 feet upon the granting of a conditional use permit. The current proposal has an FAR of less than 1.0 and is well within the maximum allowed.

The property is also located within the D-BR, Broadway Retail Frontage Combining Zone, which is intended to create, preserve, and enhance ground level retail opportunities within the Broadway/Valdez Retail District area north of the Central Business District. These interim regulations anticipate the adoption of more comprehensive and detailed regulations and a plan to attract retail opportunities within the Broadway/Valdez Retail District area which is currently under development with the Broadway Valdez District Specific Plan process that is ongoing.

Conditional Use Permits

The proposed project would require approval of a number of Conditional Use permits, including without limitation the following:

- New development in excess of 10,000 square feet (*Planning Code 17.101C.100*)
- Alcohol Beverage Sales (*Planning Code 17.35.030*)
- Master Sign Program (*Planning Code 17.104.070*)

Minor Variances

The proposed project would require approval of a number of Minor Variances, including without limitation the following:

Building Height – Section 17.35.050C of the Oakland Planning Code requires that new construction fronting on a right of way 100' or greater in width shall have a minimum building height of 35 feet, or reduced to 25 feet with a Conditional Use permit. The proposed roof height of the building would be less than 25 feet and thus would require the granting of a Minor Variance for approval.

Front Setback – Section 17.35.050A of the Oakland Planning Code requires that new construction not contain a setback of greater than 10 feet for 75% of the property frontage, and this may be reduced to 50% upon the granting of a Conditional Use permit. Similarly, Section 17.101C.090 of the Oakland Planning Code requires that any building fronting on Broadway shall not contain a setback more than five feet from the sidewalk except for plazas and only 50% of the frontage may qualify for the plaza exception. The proposed project would be setback more

than ten feet (and more than five feet from the sidewalk) for more than 50% of the frontage, and thus would require the granting of a Minor Variance.

Loading – Section 17.116.140 of the Oakland Planning Code requires that two off-street loading berths be provided for developments between 25,000 – 49,999 square feet. The proposed project is including one loading berths and hence a Minor Variance for one loading berth would be required.

SUBDIVISION ORDINANCE

The proposed development requires a Tentative Parcel Map to merge four parcels into one.

ENVIRONMENTAL REVIEW PROCESS

Scope

The City is the Lead Agency pursuant to CEQA and has the responsibility to prepare the EIR for the Project. Staff published the NOP on July 27, 2012. A scoping session was held before the Oakland Planning Commission on August 29, 2012. The following environmental topics are addressed in detail in the Draft EIR, and other topics (Agriculture and Forestry Resources, Mineral Resources, Population, Housing and Employment, Public Services, and Recreation) were also addressed in the Draft EIR (see Draft EIR page 4.14-1):

- A. Aesthetics, Shadow and Wind
- B. Air Quality
- C. Biological Resources
- D. Cultural Resources
- E. Geology, Soils and Geohazards
- F. Greenhouse Gases and Climate Change
- G. Hazards and Hazardous Materials
- H. Hydrology and Water Quality
- I. Land Use, Plans and Policies
- J. Noise
- K. Transportation and Circulation
- L. Utilities and Service Systems

Potentially Significant Impacts Identified in the Draft EIR

All impacts, City Standard Conditions of Approval and mitigation measures identified in the Draft EIR are summarized in Table 2-1 (see Attachment B) at the end of Chapter 2 (Summary) of the Draft EIR. Table 2-1 also identifies the level of significance of the impact after City Standard Conditions of Approval and recommended mitigation measures are implemented. Other than the impacts discussed below, all of the environmental effects of the Project can be reduced to less

than significant levels through implementation of Standard Conditions of Approval or recommended mitigation measures.

The Draft EIR identifies the following **Significant and Unavoidable** environmental impacts related to Transportation and Circulation and Greenhouse Gases:

Transportation & Circulation

The proposed Project would result in one significant and unavoidable traffic impact at one intersection under "Cumulative 2035 plus Project". While the DEIR identifies recommended mitigation measures at this intersection, the measure would not reduce the impact to less than significant.

- * **Impact TRANS-3:** The proposed project would increase the V/C ratio for a critical movement by 0.05 or more during the weekday PM peak hour and increase the total intersection V/C ratio by 0.03 or more and increase the V/C ratio for a critical movement by 0.05 or more during the Saturday peak hour at the 27th Street/ 24th Street/ Bay Place/ Harrison Street intersection (Intersection #11), which would operate at LOS F under 2035 conditions.

Greenhouse Gases

The proposed project would result in one significant and unavoidable impact related to greenhouse gases. A reduction of 411 MT CO2e per year is required to reduce the Project's GHG emissions to below the significance threshold of 1,100 MT.

The proposal also exceeds the 4.6 MT CO2e per service population annually, which for this project would only include the employees of the project. A particular shortcoming of the efficiency threshold in accurately capturing the potentially net positive GHG effect of this Project is that it fails to factor in the context of the project site. The Project is infill in an existing mixed use area of established residential neighborhoods in the surrounding area and notable employment hubs (Pill Hill two blocks west/northwest and Kaiser Permanente campus three to four blocks north). Theoretically, if the existing nearby residential and employment population was factored as service population, especially those located within a walkable radius of the store (approximately 4-5 blocks or one-quarter mile), the Project's GHG emissions would not likely exceed the 4.6 MT CO2e per service population threshold. The development is also located within a priority development area with respect to the Sustainable Communities plan developed for the Bay Area pursuant to SB 375 which has been implemented to reduce greenhouse gas emissions through the planning process.

However, because the immediately surrounding residential or employment population cannot be included as service population and it cannot be confirmed with quantification guaranteeing that GHG SCA-1 would achieve emissions reduction below significance thresholds, the impact is conservatively considered significant and unavoidable because no feasible reduction measures from the City's Greenhouse Reduction Plan Standard Condition of Approval (GHG SCA-1) were identified to address this level of reduction with this project other than the applicant's purchasing

of carbon credits pursuant to GHG SCA-1, which may not be feasible in the future, as discussed below.

- **Impact GHG-1:** The Project would produce greenhouse gas emissions that exceed 1,100 metric tons of CO₂e per year and that would exceed 4.6 metric tons of CO₂e per service population annually.

Foreseeing the future market for and cost of purchasing carbon credits over 40 years, or even in the nearer term, is not possible at this time with any level of certainty. The potential exists for the cost to become prohibitive in the future and render the Project financially infeasible. However, at this time GHG SCA 1, including namely the purchase of carbon credits, will be fully applicable since all other measures that could achieve substantive reductions are considered infeasible or the emissions reduction that would be gained would not be substantial.

However, at some point in the future, the project sponsor could establish that the continued purchase of carbon credits would no longer be financially feasible, making the Project financially infeasible. Also at some point in the future, the project sponsor could provide actual operating data from the Project (after a certain duration of operation determined by the City) that shows the Project's GHG emissions are lower than estimated in this EIR and less than the significance threshold. Moreover, if the City revises its SCA related to GHG reduction or adopts new or amended policies or standards for assessing and mitigating GHG emissions impacts, the project sponsor would obtain any benefit of those changes and have the ability to request that the City consider a modification to the Project's conditions of approval to maintain consistent with the current City GHG reduction policies and requirements at that time.

Project Alternatives

Chapter 5 of the Draft EIR includes the analysis of five alternatives to the Proposed Project that meet the requirements of CEQA, which include a reasonable range of alternatives to the Project that would feasibly attain most of the Project's basic objectives, and avoid or substantially lessen many of the Project's significant environmental effects. The five CEQA alternatives analyzed in Chapter 5 include:

- *Alternative 1 - Mixed Use Alternatives A & B with Grocery* – This alternative includes two variants. Alternative 1A considers 150 multifamily units built above a 28,000 square-foot grocery store and two local-serving retail spaces on the ground/first level. Overall, the tallest portions of the building would be six levels and up to 75 feet tall above grade (compared to one-story with an upper-level parking deck and 40 feet tall with the Project), with one lower level underground. Specifically, on the north portion of the project site, residences would be built in five levels above the ground/first level retail and a lower parking level. The south portion of the project site would be two levels above the ground/first level retail. Alternative 1B considers 225 multifamily units built above a 26,000 square-foot grocery store and three local-serving retail spaces on the ground/first

PUBLICATION AND DISTRIBUTION OF THE DRAFT EIR

The Draft EIR was made available for public review on August 16, 2013. The Notice of Availability for the Draft EIR was mailed to property owners within 300 feet of the Project area, distributed to State and local agencies, posted on the Project site, and mailed to Interested Parties. The Notice of Availability is attached to this report (see Attachment C). Copies of the Draft EIR were also previously distributed to City officials, including the Planning Commission, and is available at the Department of Planning & Building, Planning Division (250 Frank H. Ogawa Plaza, Suite 3315), and the City's website at:

<http://www2.oaklandnet.com/Government/o/PBN/OurServices/Application/DOWD009157>


CONCLUSION

All comments received on the Draft EIR will be considered by the City prior to finalizing the EIR and making a decision on the Project. Comments on the Draft EIR should focus on the adequacy of the EIR in discussing possible impacts on the physical environment, ways in which potential adverse effects might be minimized, and alternatives to the Project in light of the EIR's purpose to provide useful and accurate information about such factors. The public hearing on September 11, 2013 is not intended for public comments on the Project merits or the Project's detailed design. Comments on the Draft EIR may be made at the September 11, 2013 public hearing or in writing to the Department of Planning & Building, Planning Division, to the attention of Peterson Vollmann. Written comments must be received prior to the comment period deadline (4:00 p.m. on September 30, 2013). After all comments are received, the City will prepare a Final EIR/Response to Comments document will be prepared and the Planning Commission will consider certification of the Final EIR at a future meeting date. Staff will return to the full Planning Commission for action on the development entitlements.

RECOMMENDATION

- 1) Receive public and Planning Commission comments on the Draft EIR.
- 2) Close the public hearing with respect to receipt of oral comments; written comments will be accepted until 4:00 pm on Monday, September 30, 2013.

Prepared by:

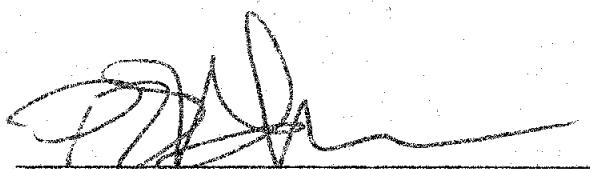


Peterson Z. Vollmann
Planner III

Approved by:



Scott Miller
Zoning Manager
Planning and Zoning Division

Approved for forwarding to the Planning Commission:

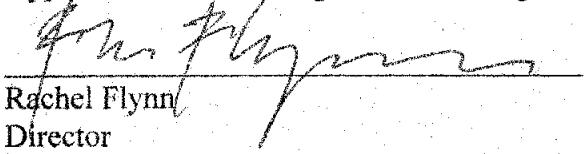

Rachel Flynn
Director
Department of Planning & Building


Attachments:

- A. Project Plans
- B. Summary Table (DEIR Table 2-1)
- C. Notice of Availability (NOA)
- D. Summary of Alternatives (DEIR Tables 5-1 & 2)

Note:

The Draft EIR was provided under separate cover for review and consideration by the Planning Commission, and is available to the public at the Planning Division office at 250 Frank H. Ogawa Plaza, Suite 3315, Oakland, CA 94612 and on the City's website at:

<http://www2.oaklandnet.com/Government/o/PBN/OurServices/Application/DOWD009157>

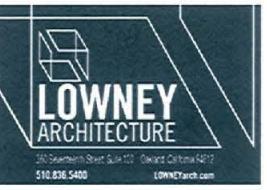

PROJECT NAME

THE SHOPS ON BROADWAY

3001-3039 BROADWAY
OAKLAND, CA

NOT FOR
CONSTRUCTION

CONSULTANT

CONSULTANT STAMP

NO.	DATE	ISSUES & REVISIONS	BY
1.	6/26/13	DRC	DB
2.	9/11/13	PLANNING COMMISSION	DB

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PROJECT NUMBER: 13009
SHEET TITLE: COVER

SHEET NUMBER A0.0

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ATTACHMENT A

THE SHOPS ON BROADWAY

3001-3039 BROADWAY OAKLAND, CA



PROJECT NAME

THE SHOPS ON BROADWAY



01 - 2915 BROADWAY



02 - 2939 BROADWAY




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06 - 3093 BROADWAY



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09 - 3074 BROADWAY



10 - 3068 BROADWAY

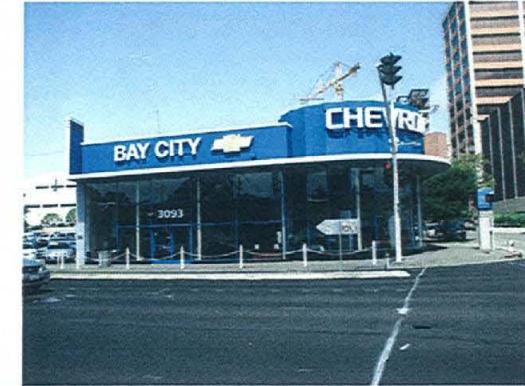

11 - 3060 BROADWAY




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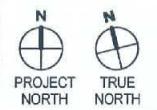
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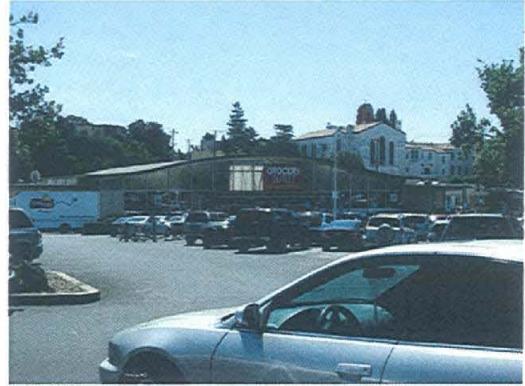
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04 - 3000
BROADWAY



05 - 2964
BROADWAY



06 - 2900
BROADWAY

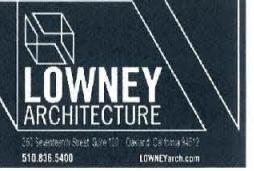

07 - 2900
BROADWAY



08 - 250 30TH
STREET



09 - 3000
BROADWAY



10 - 3030 WEBSTER
STREET



11 - 3005 WEBSTER
STREET



12 - 2964 BROADWAY



SITE KEY
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PROJECT NAME

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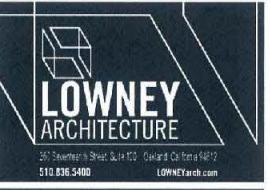
02 - 371 30TH STREET



03 - 3120 WEBSTER STREET



04 - 3030 WEBSTER STREET



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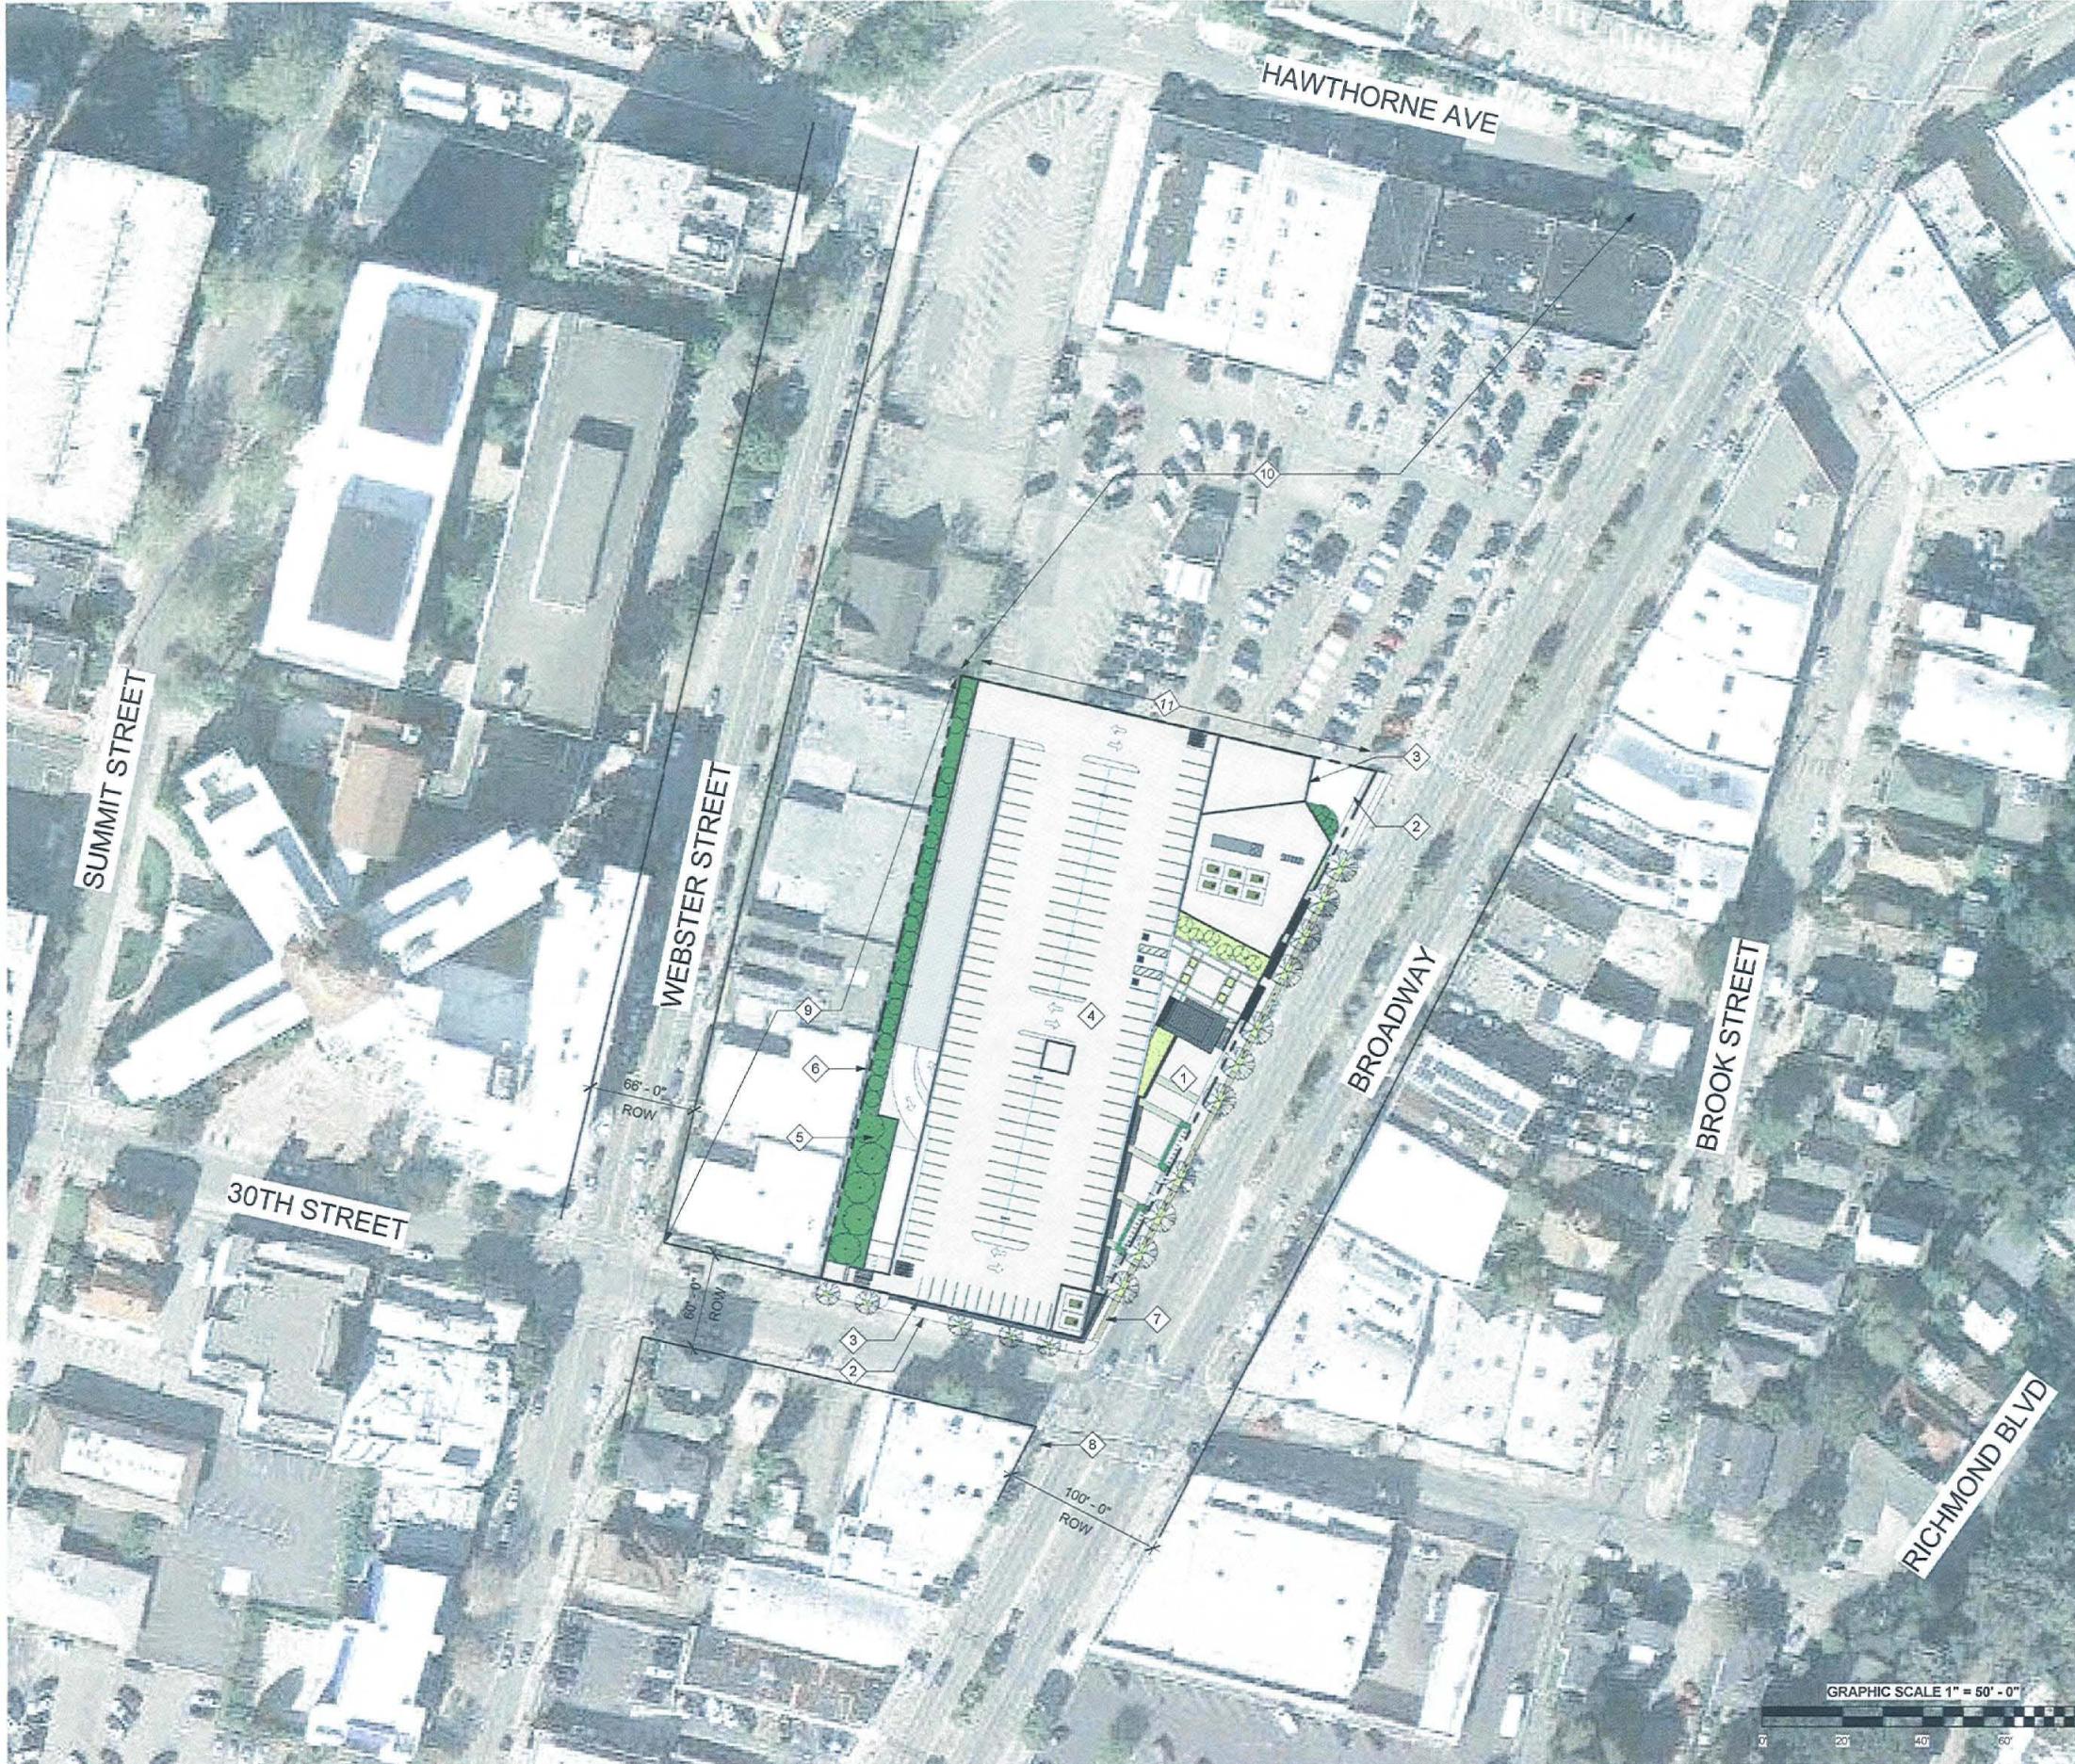
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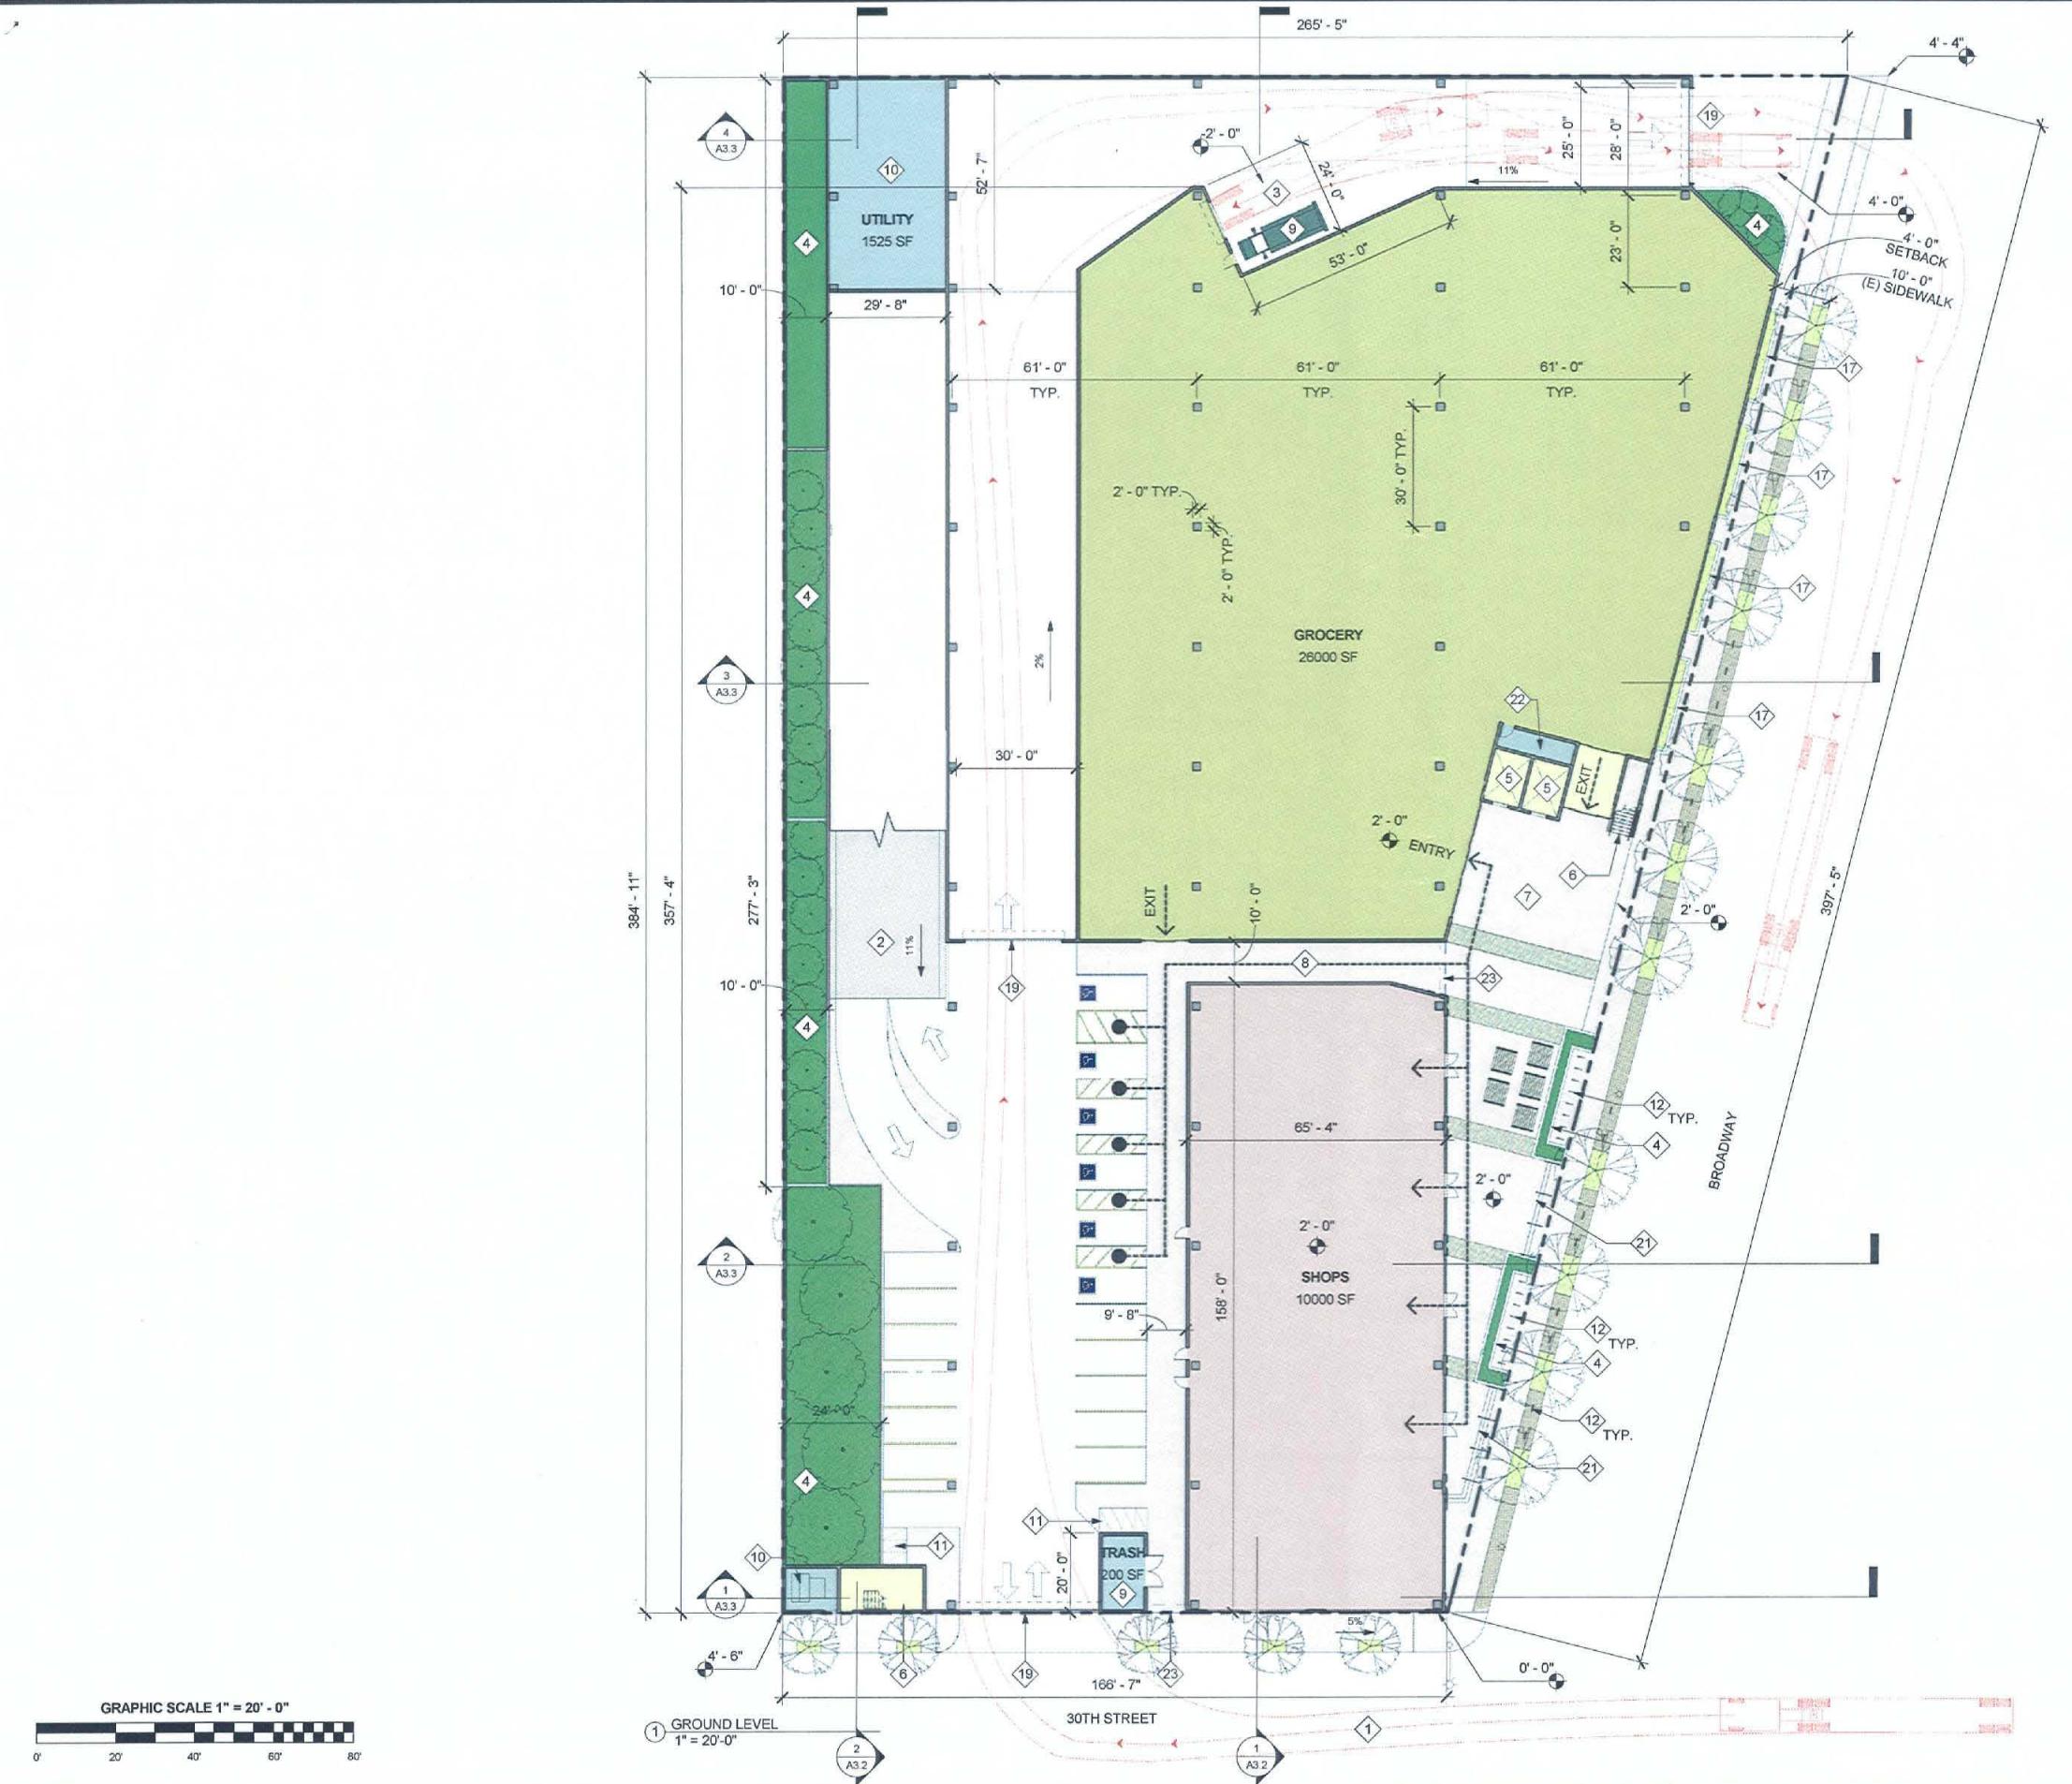
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NOTES

1. CODE REQUIRES 4% OF IMPERVIOUS SURFACE AREA TO BE USED AS A LANDSCAPED STORMWATER TREATMENT AREA, SEE CIVIL DRAWING C.3 FOR C.3 STORMWATER MANAGEMENT PLAN
 2. STRUCTURAL DIMENSIONS AND SPACING IS APPROXIMATE UNTIL FINAL ENGINEERING IS COMPLETED
 3. SLOPE OF ROOFTOP PARKING DECK WILL NOT EXCEED 2%



PROJECT NAME

THE SHOPS ON BROADWAY

3001-3039 BROADWAY
OAKLAND, CA

KEYNOTES

- 1 TRUCK PATH
 - 2 AUTO RAMP UP TO ROOFTOP PARKING
 - 3 LOADING DOCK
 - 4 LANDSCAPING
 - 5 ELEVATOR
 - 6 STAIR
 - 7 RETAIL ENTRY PLAZA
 - 8 PEDESTRIAN PASSAGEWAY
 - 9 TRASH ROOM
 - 0 UTILITY / TRANSFORMER ROOM
 - 1 LONG TERM BIKE RACKS
 - 2 SHORT TERM BIKE RACKS
 - 3 ROOFTOP PARKING OVER RETAIL
 - 4 ROOFTOP PLAZA / GARDEN
 - 5 ROOFTOP MECHANICAL UNITS
 - 6 CART CORRAL
 - 7 PLANTER
 - 8 OPEN TO BELOW
 - 9 GARAGE DOOR
 - 0 AWNING
 - 1 STEPS FROM SIDEWALK TO PLAZA
 - 2 ELEVATOR MACHINE ROOM
 - 3 ROLL DOWN SECURITY GRILLE
 - 4 LIGHT POLE

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PLAN LEGEND

- The legend consists of six entries, each with a colored square followed by a symbol or text:

 - Light green square: RETAIL ANCHOR
 - Pale yellow square: RETAIL TENANT
 - Yellow square: CIRCULATION / LOBBY
 - Dark green square: LANDSCAPE
 - Light blue square: UTILITIES / TRASH / SERVICES
 - Black arrow pointing left: ENTRANCE / EXIT
 - Dashed black line: PROPERTY LINE
 - Dashed black line: ACCESSIBLE PATH OF TRAVEL

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FLOOR PLAN

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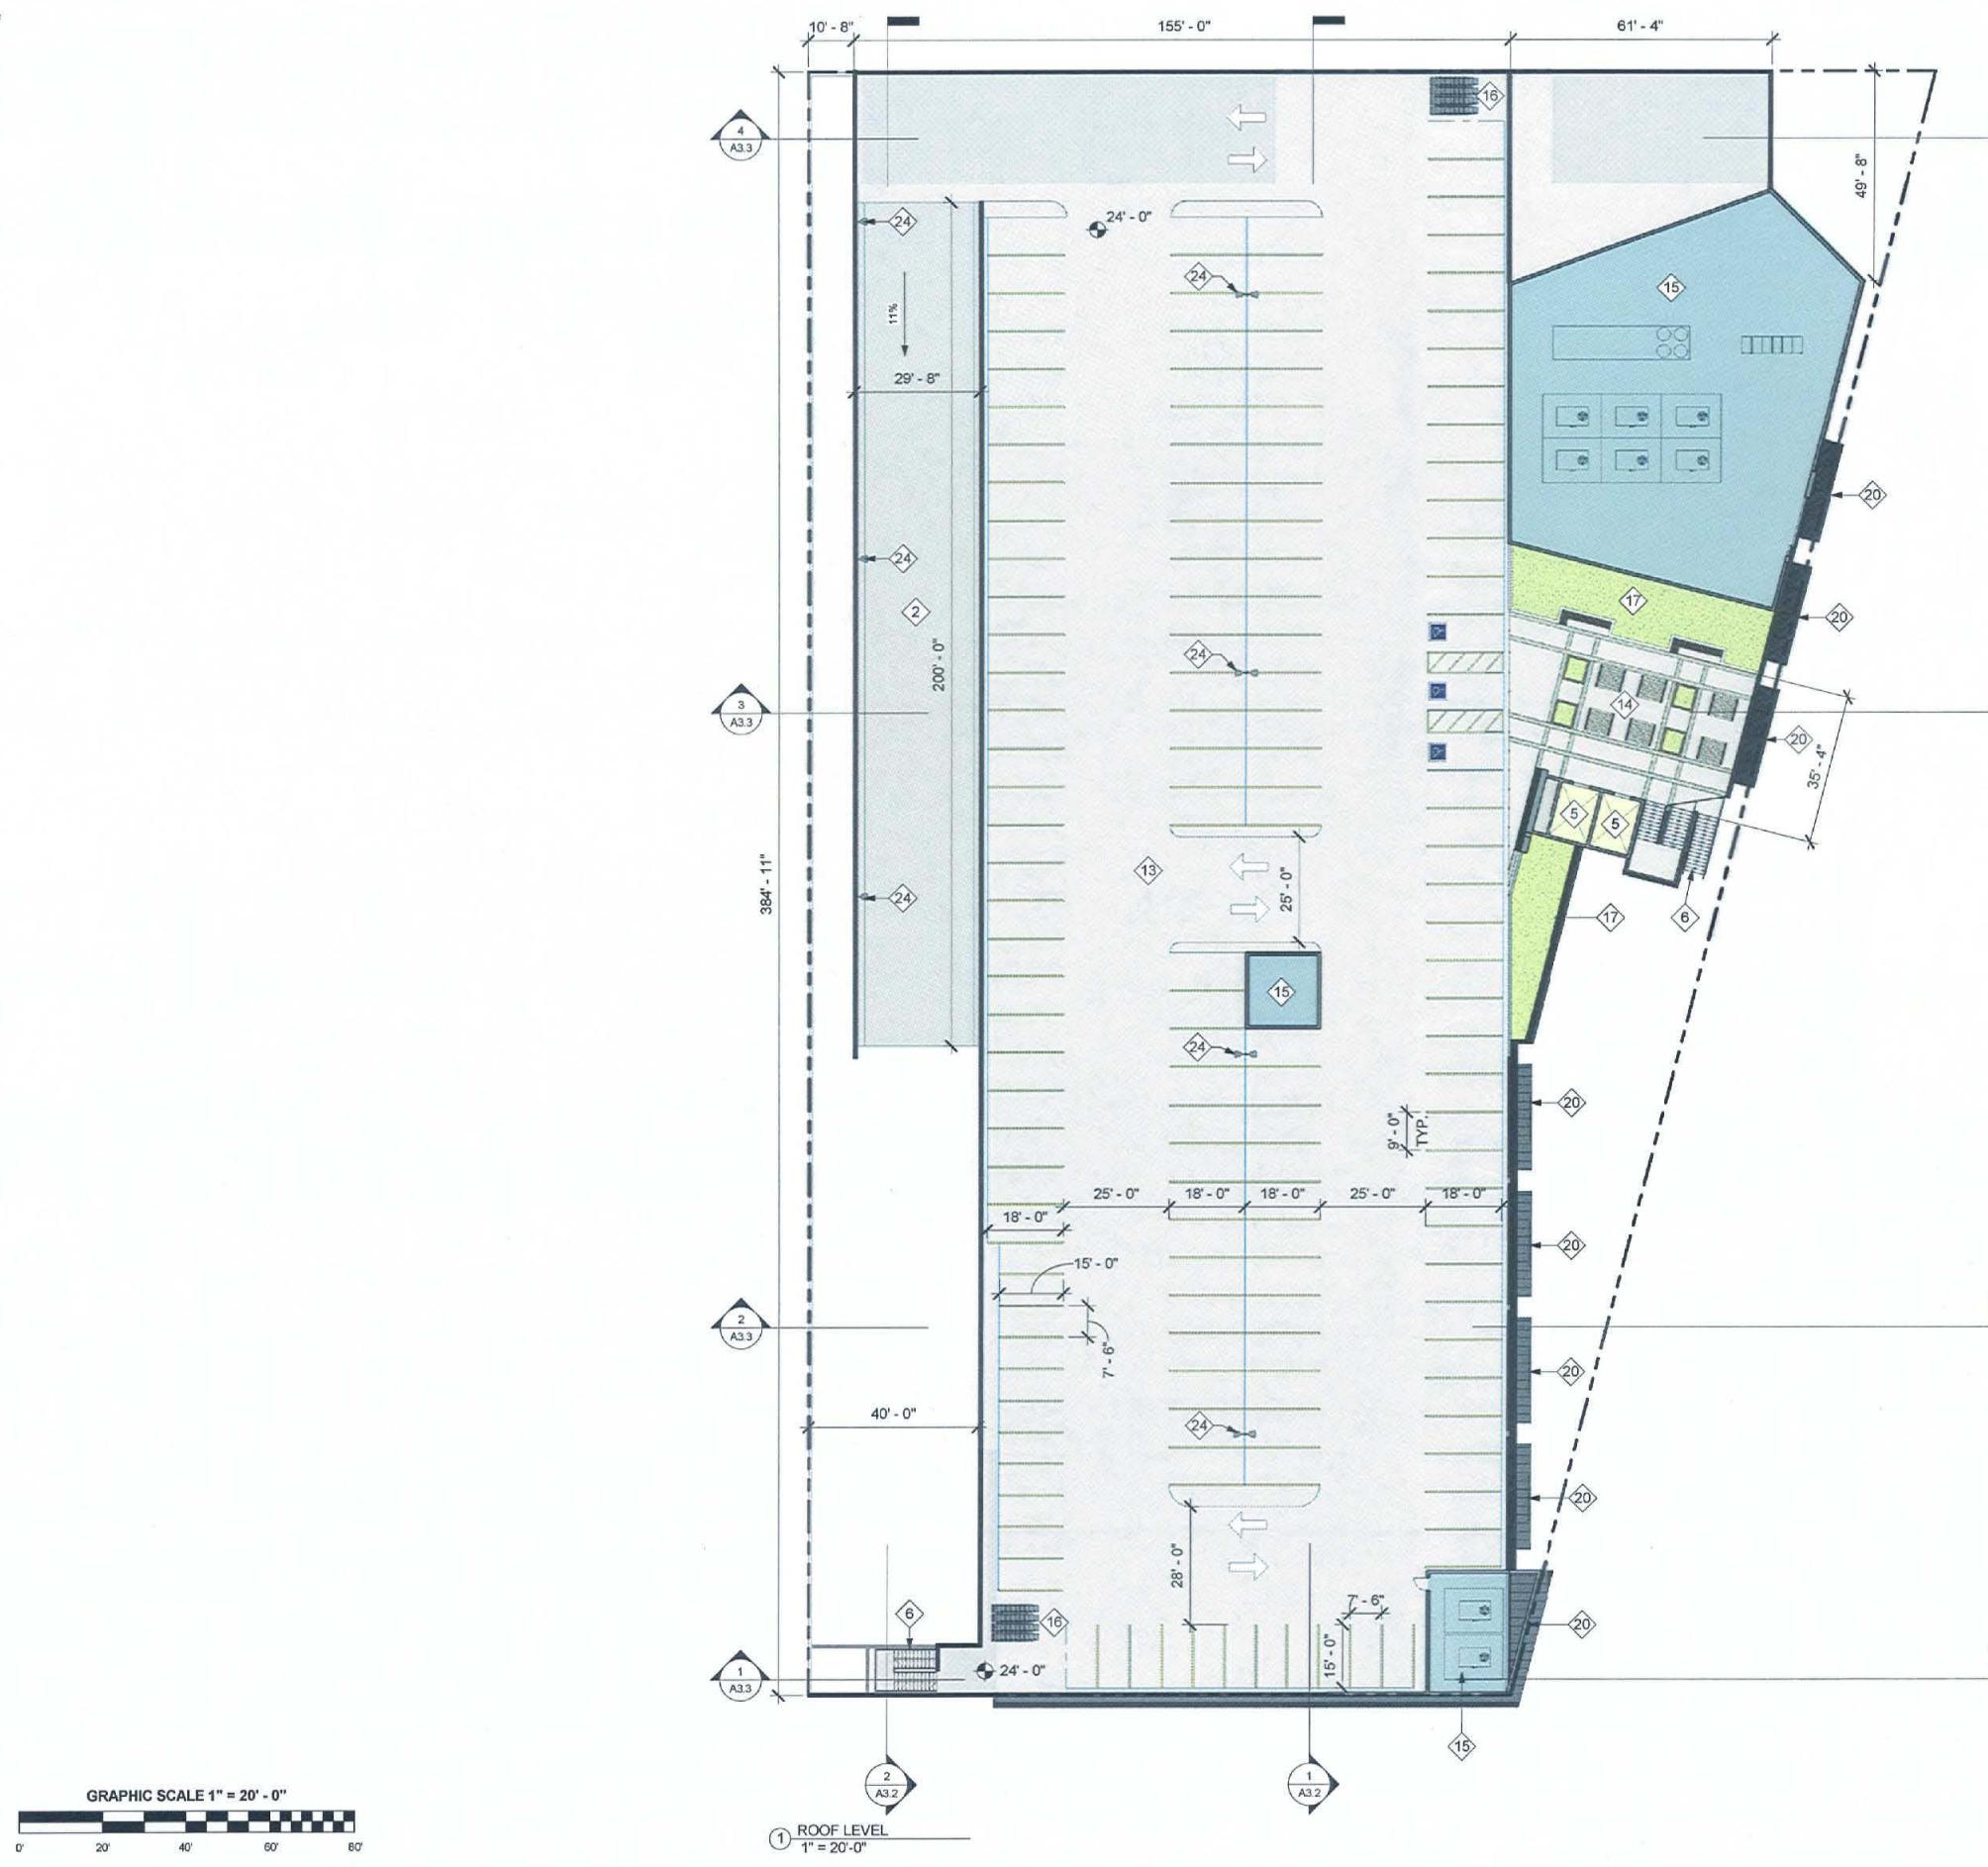
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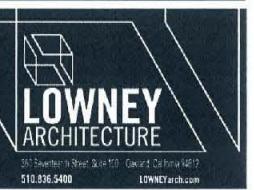
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NOTES

- CODE REQUIRES 4% OF IMPERVIOUS SURFACE AREA TO BE USED AS A LANDSCAPED STORMWATER TREATMENT AREA, SEE CIVIL DRAWING C3.1 FOR C.3 STORMWATER MANAGEMENT PLAN
- STRUCTURAL DIMENSIONS AND SPACING IS APPROXIMATE UNTIL FINAL ENGINEERING IS COMPLETED
- SLOPE OF ROOFTOP PARKING DECK WILL NOT EXCEED 2%



PROJECT NAME
THE SHOPS ON BROADWAY

3001-3039 BROADWAY
OAKLAND, CA

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CONSULTANT

CONSULTANT STAMP


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KEYNOTES


- ① TRUCK PATH
- ② AUTO RAMP UP TO ROOFTOP PARKING
- ③ LOADING DOCK
- ④ LANDSCAPING
- ⑤ ELEVATOR
- ⑥ STAIR
- ⑦ RETAIL ENTRY PLAZA
- ⑧ PEDESTRIAN PASSAGEWAY
- ⑨ TRASH ROOM
- ⑩ UTILITY / TRANSFORMER ROOM
- ⑪ LONG TERM BIKE RACKS
- ⑫ SHORT TERM BIKE RACKS
- ⑬ ROOFTOP PARKING OVER RETAIL
- ⑭ ROOFTOP PLAZA / GARDEN
- ⑮ ROOFTOP MECHANICAL UNITS
- ⑯ CART CORRAL
- ⑰ PLANTER
- ⑱ OPEN TO BELOW
- ⑲ GARAGE DOOR
- ⑳ AWNING
- ㉑ STEPS FROM SIDEWALK TO PLAZA
- ㉒ ELEVATOR MACHINE ROOM
- ㉓ ROLL DOWN SECURITY GRILLE
- ㉔ LIGHT POLE

PLAN LEGEND

- PROJECT NORTH
- TRUE NORTH
- DRAWN BY: DB
- PROJECT NUMBER: 13009
- SHEET TITLE: ROOF PLAN
- SHEET NUMBER: A2.2
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NOTES

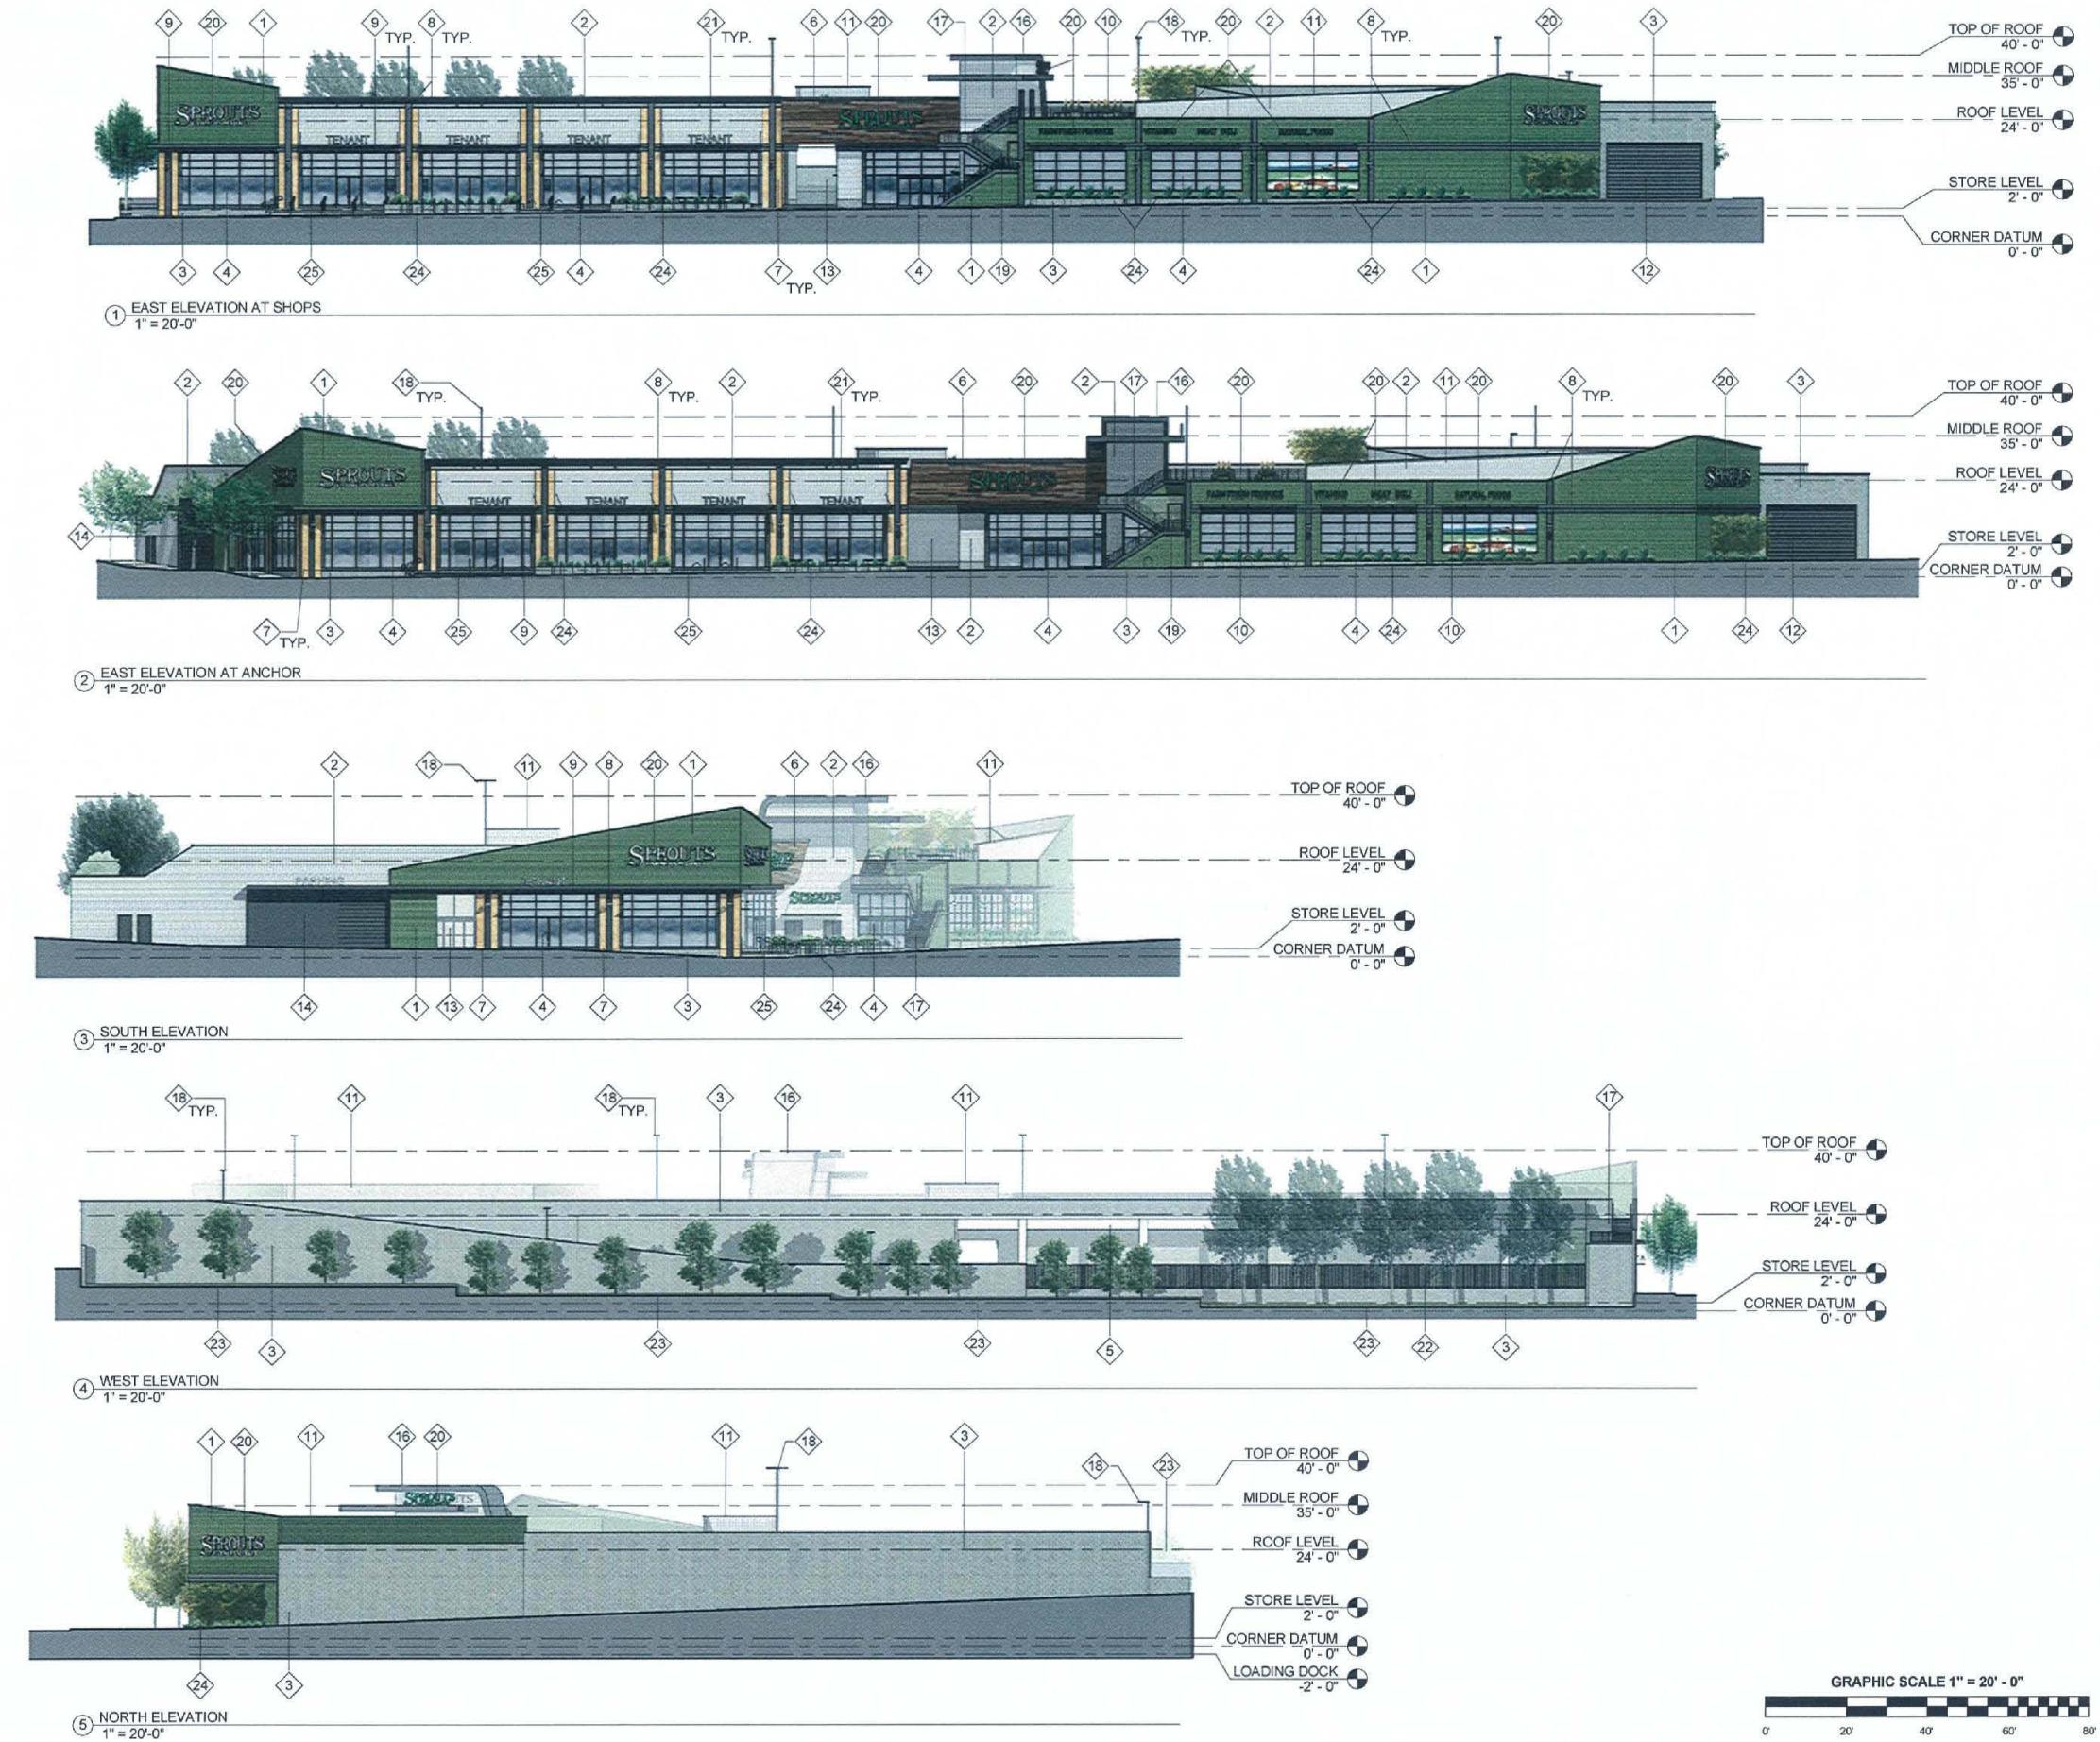

PROJECT NAME
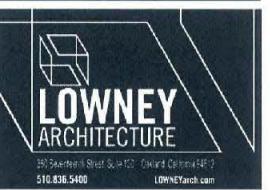
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3001-3039 BROADWAY
OAKLAND, CA

KEYNOTES

- ① GREEN CORRUGATED METAL
- ② GRAY CORRUGATED METAL
- ③ CONCRETE MASONRY BLOCK
- ④ STOREFRONT GLAZING SYSTEM
TYPICAL DARK ANODIZED OR BLACK
- ⑤ CONCRETE STRUCTURE
POURED IN PLACE AND PRE-CAST
- ⑥ RECLAIMED WOOD SIDING
- ⑦ TERRA COTTA CLADDING
- ⑧ ARCHITECTURAL METAL DETAILS
PAINTED DARK GRAY
- ⑨ ARCHITECTURAL METAL LAWNING
WITH RECLAIMED WOOD UNDERSIDE
- ⑩ ARCHITECTURAL METAL TRELLIS
DARK ANODIZED OR BLACK
- ⑪ SCREENED ROOFTOP MECHANICAL
EQUIPMENT (TBD)
- ⑫ TRUCK EXIT FROM COVERED
TRASH AND LOADING
- ⑬ PEDESTRIAN BREEZEWAY CONNECTING
COVERED PARKING TO SHOPS
- ⑭ COVERED STREET LEVEL
PARKING AREA
- ⑮ ROOF PLAZA AT UPPER
PARKING DECK
- ⑯ CUSTOMER ELEVATORS
- ⑰ CUSTOMER STAIRWAY
- ⑱ SHIELDED PARKING LIGHTING
- ⑲ EXIT STAIRWAY ENCLOSURE
- ⑳ SPROUTS SIGNAGE
- ㉑ TENANT RETAIL SIGNAGE (TBD)
- ㉒ METAL FENCE
- ㉓ PLANTED BIO-FILTRATION
WATER TREATMENT AREA
- ㉔ RAISED PLANTER
- ㉕ STEPS UP TO PUBLIC PLAZA

CONSULTANT

CONSULTANT STAMP

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LEGEND


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SHEET TITLE:

ELEVATIONS

SHEET NUMBER

A3.1

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NOTES

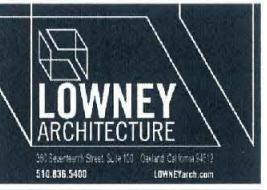- ELEVATIONS SHOWN ARE RELATIVE. PROJECT ELEVATION 0'-0" IS EQUAL TO 46'-9" ABOVE SEA LEVEL. REFER TO CIVIL SURVEY FOR MORE DETAILED INFORMATION
- ELEVATIONS OF ADJACENT PROPERTIES ARE APPROXIMATE AND FOR REFERENCE ONLY.

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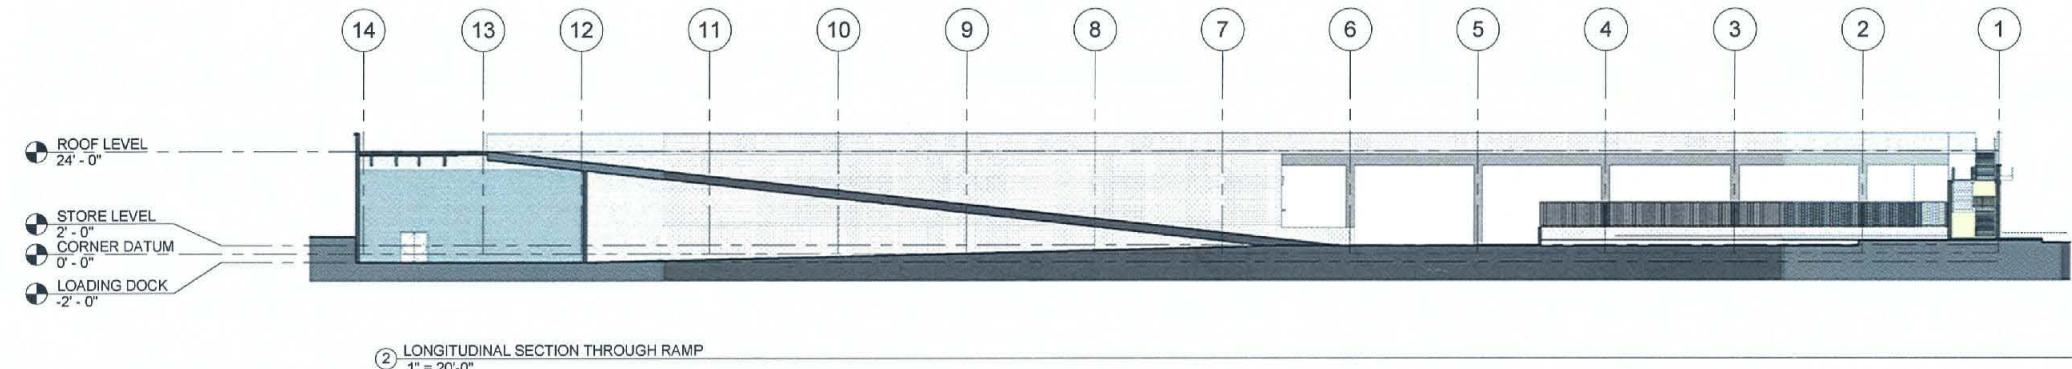
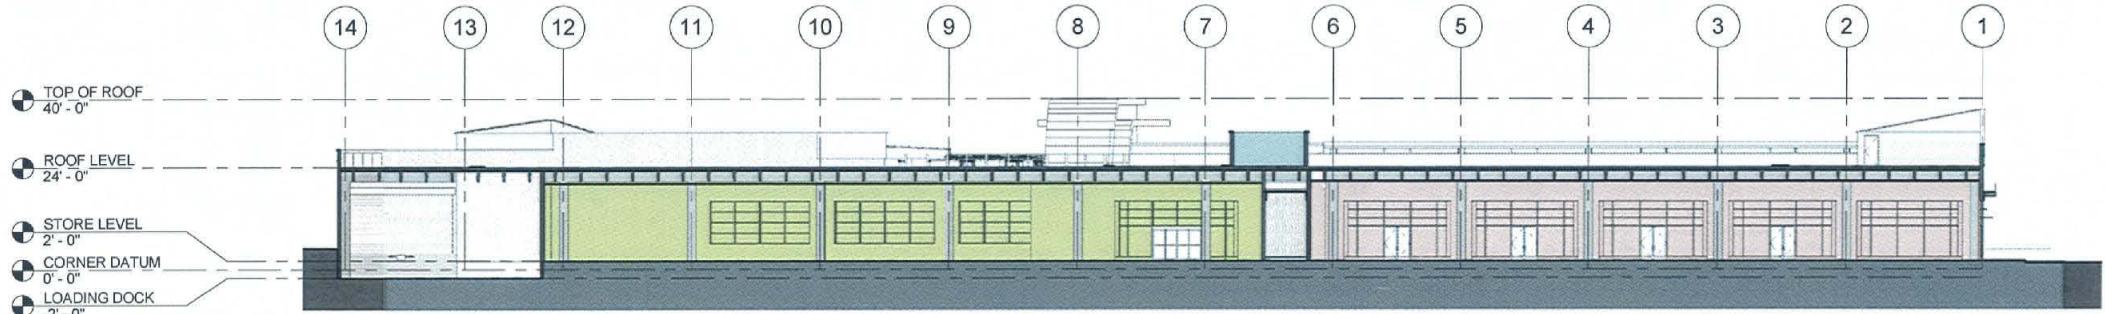
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PROJECT NUMBER: 13009
SHEET TITLE: SECTIONS

SHEET NUMBER

A3.2

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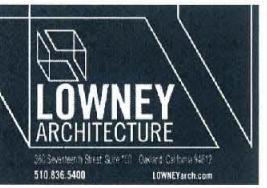
KEYNOTES

- ① CUSTOMER ELEVATOR
- ② CUSTOMER STAIR
- ③ MECHANICAL ENCLOSURE
- ④ AUTO RAMP
- ⑤ TRUCK RAMP
- ⑥ PUBLIC PLAZA
- ⑦ PLANTER
- ⑧ BIOFILTRATION AREA
- ⑨ ADJACENT HOUSING

LEGEND

- RETAIL ANCHOR
- RETAIL TENANT
- CIRCULATION / LOBBY
- LANDSCAPE
- SERVICES





NOTES





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KEYNOTES

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- ② CUSTOMER STAIR
- ③ MECHANICAL ENCLOSURE
- ④ AUTO RAMP
- ⑤ TRUCK RAMP
- ⑥ PUBLIC PLAZA
- ⑦ PLANTER
- ⑧ BIOFILTRATION AREA
- ⑨ ADJACENT HOUSING

CONSULTANT

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LEGEND

- RETAIL ANCHOR
- RETAIL TENANT
- CIRCULATION / LOBBY
- LANDSCAPE
- SERVICES
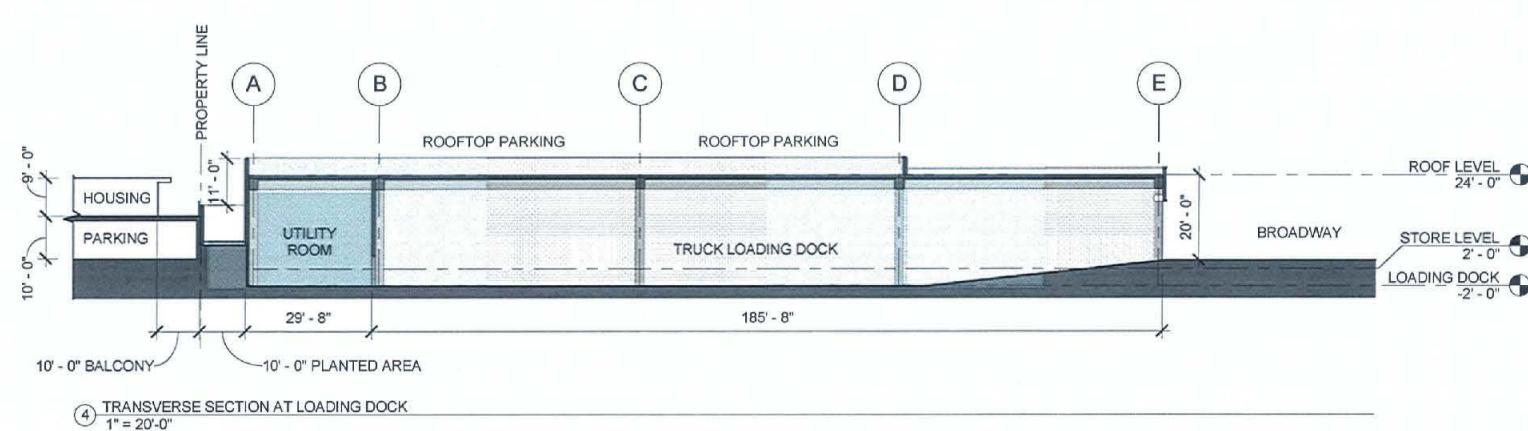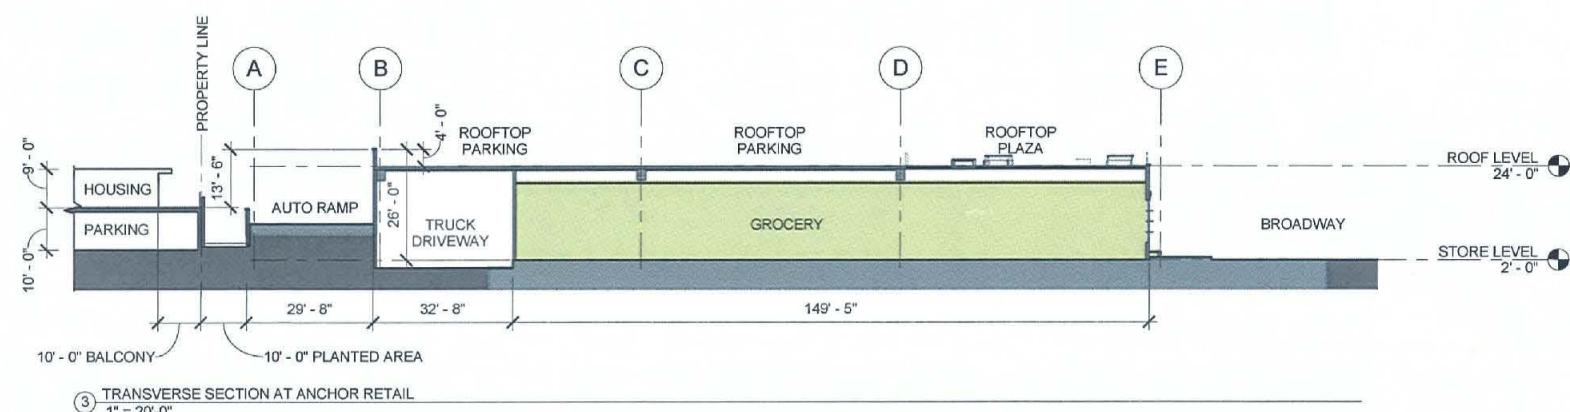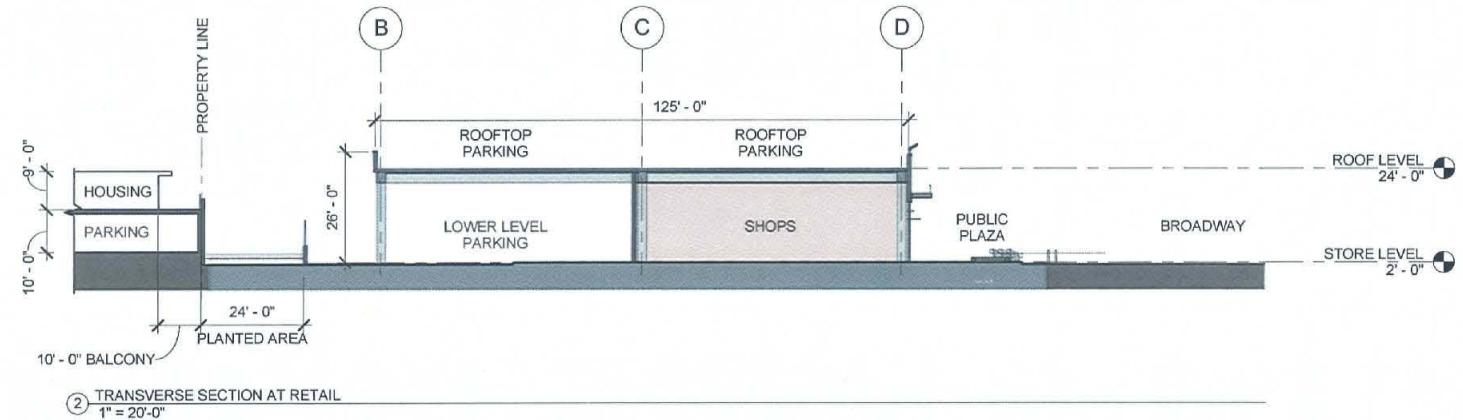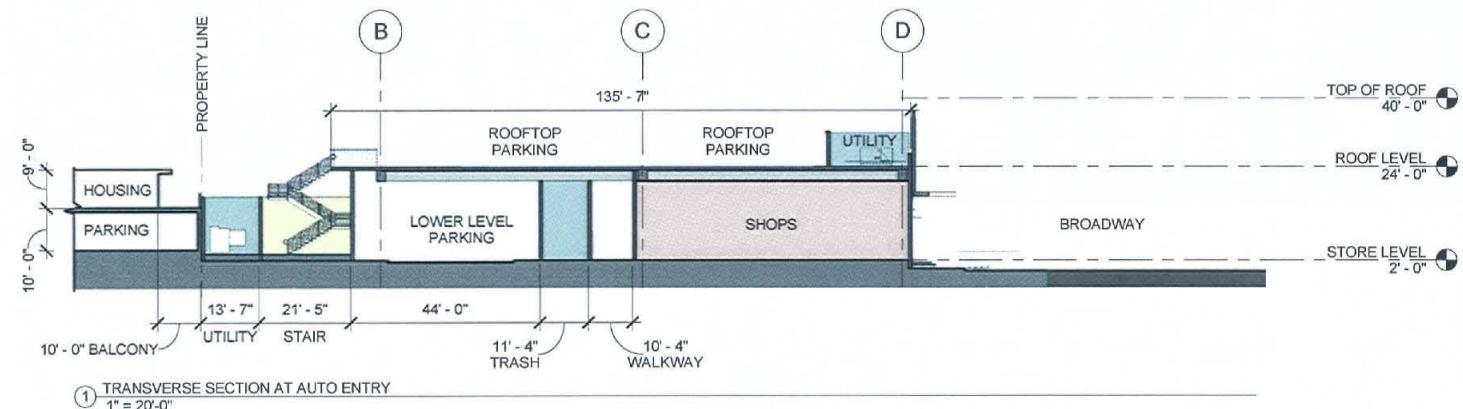
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SECTIONS

SHEET NUMBER

A3.3

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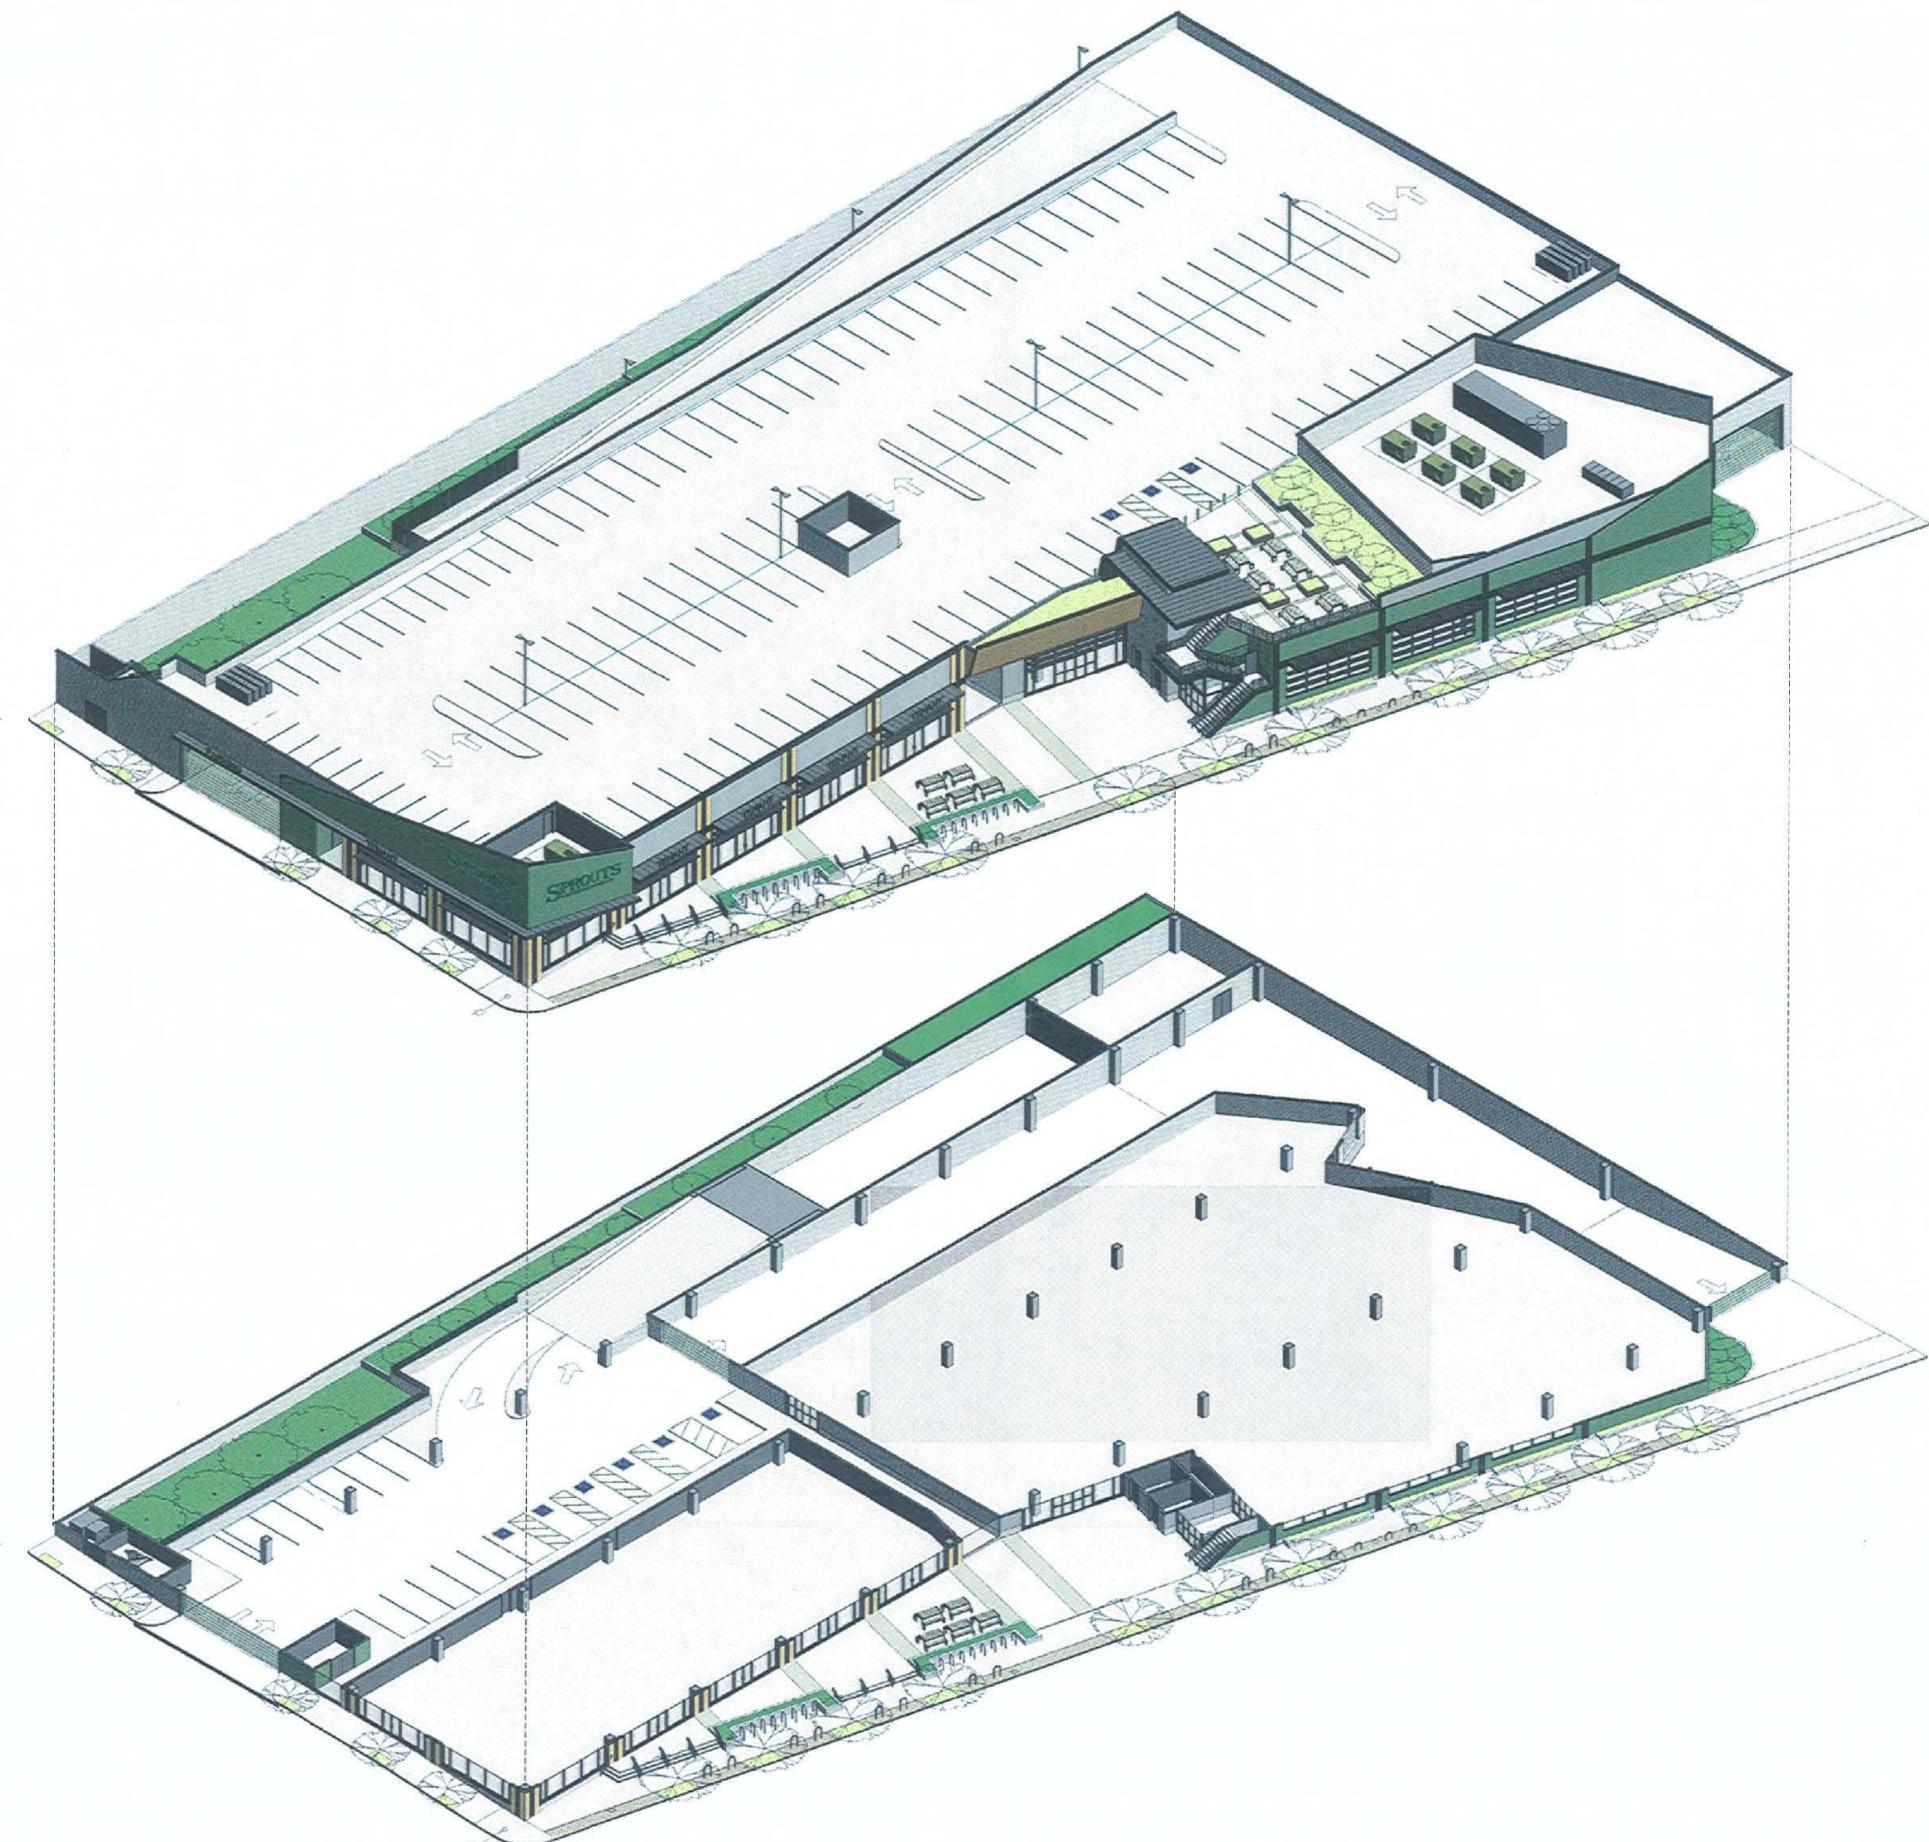
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PROJECT NUMBER: 13009
SHEET TITLE:

AXONOMETRIC VIEWS

SHEET NUMBER

A4.1

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SHEET TITLE:

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13009

3D VIEWS

SHEET NUMBER

A4.2

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① 30TH AND BROADWAY CORNER



② PUBLIC PLAZA



④ PLAZA FACING SHOPS



③ BIRD'S EYE VIEW

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3D VIEWS

SHEET NUMBER

A4.3

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① NORTH CORNER OF SPROUTS



② SPROUTS ELEVATION








④ PARKING LOT ENTRY



③ ROOFTOP PLAZA

SPROUTS SIGNAGE STANDARDS

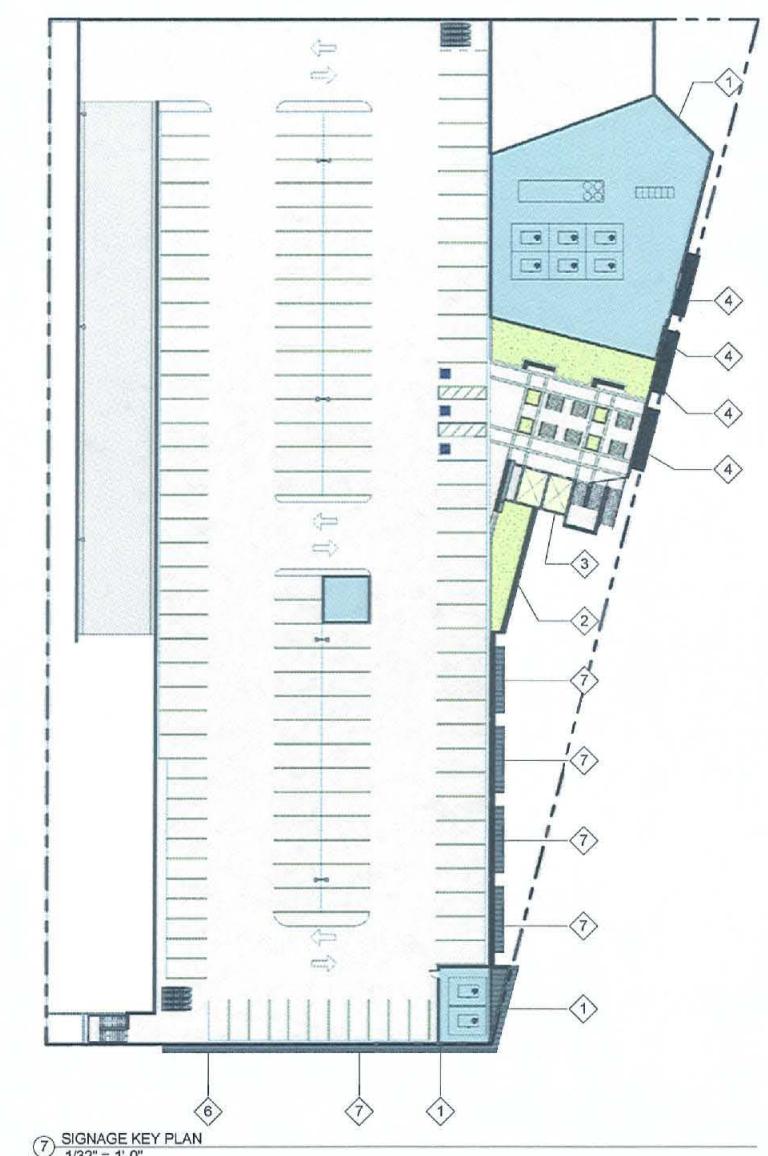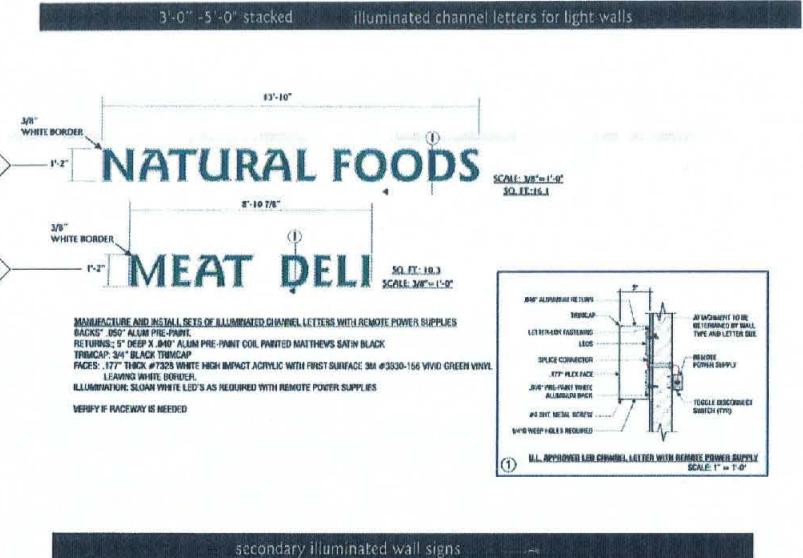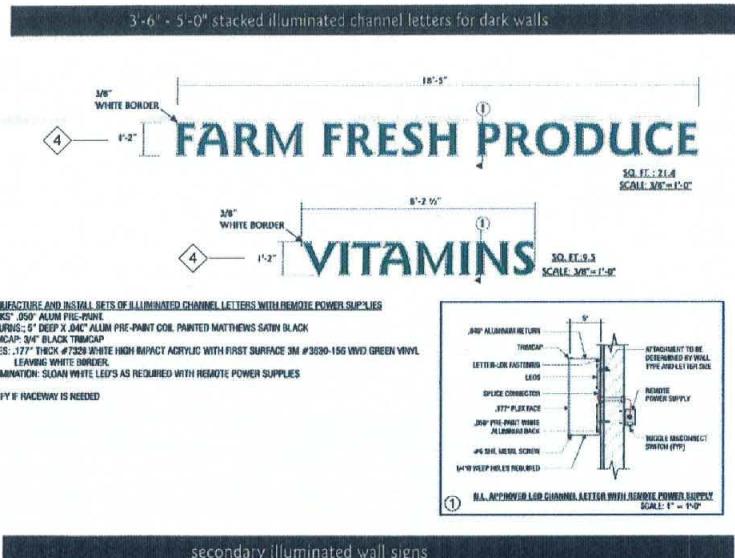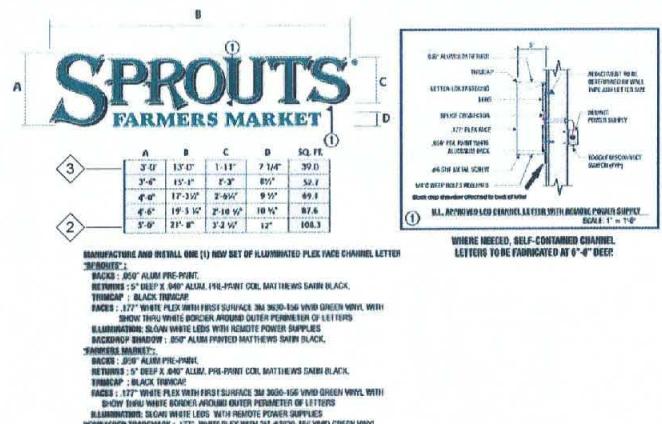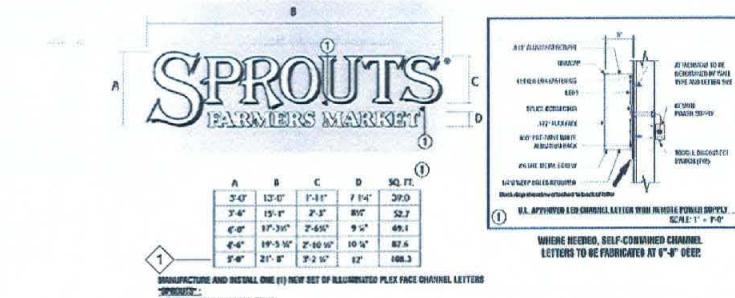

⑦ SIGNAGE KEY PLAN
1/32" = 1'-0"

SHEET NOTES

SIGNAGE LEGEND

- ① SPROUTS SIGNAGE, SURFACE MOUNTED 5 FOOT STACKED ILLUMINATED CHANNEL LETTERS FOR DARK WALLS
- ② SPROUTS SIGNAGE, SURFACE MOUNTED 5 FOOT STACKED ILLUMINATED CHANNEL LETTERS FOR LIGHT WALLS
- ③ SPROUTS SIGNAGE, SURFACE MOUNTED 3 FOOT STACKED ILLUMINATED CHANNEL LETTERS FOR LIGHT WALLS
- ④ SPROUTS SIGNAGE, SURFACE MOUNTED SECONDARY ILLUMINATED WALL SIGNS
- ⑤ NOT USED
- ⑥ PARKING LOT ENTRY SIGNAGE, TO BE DETERMINED METAL LETTERING MOUNTED ON AWNING
- ⑦ TENANT SIGNAGE, TO BE DETERMINED METAL LETTERING MOUNTED ON AWNING



THE SHOPS ON BROADWAY


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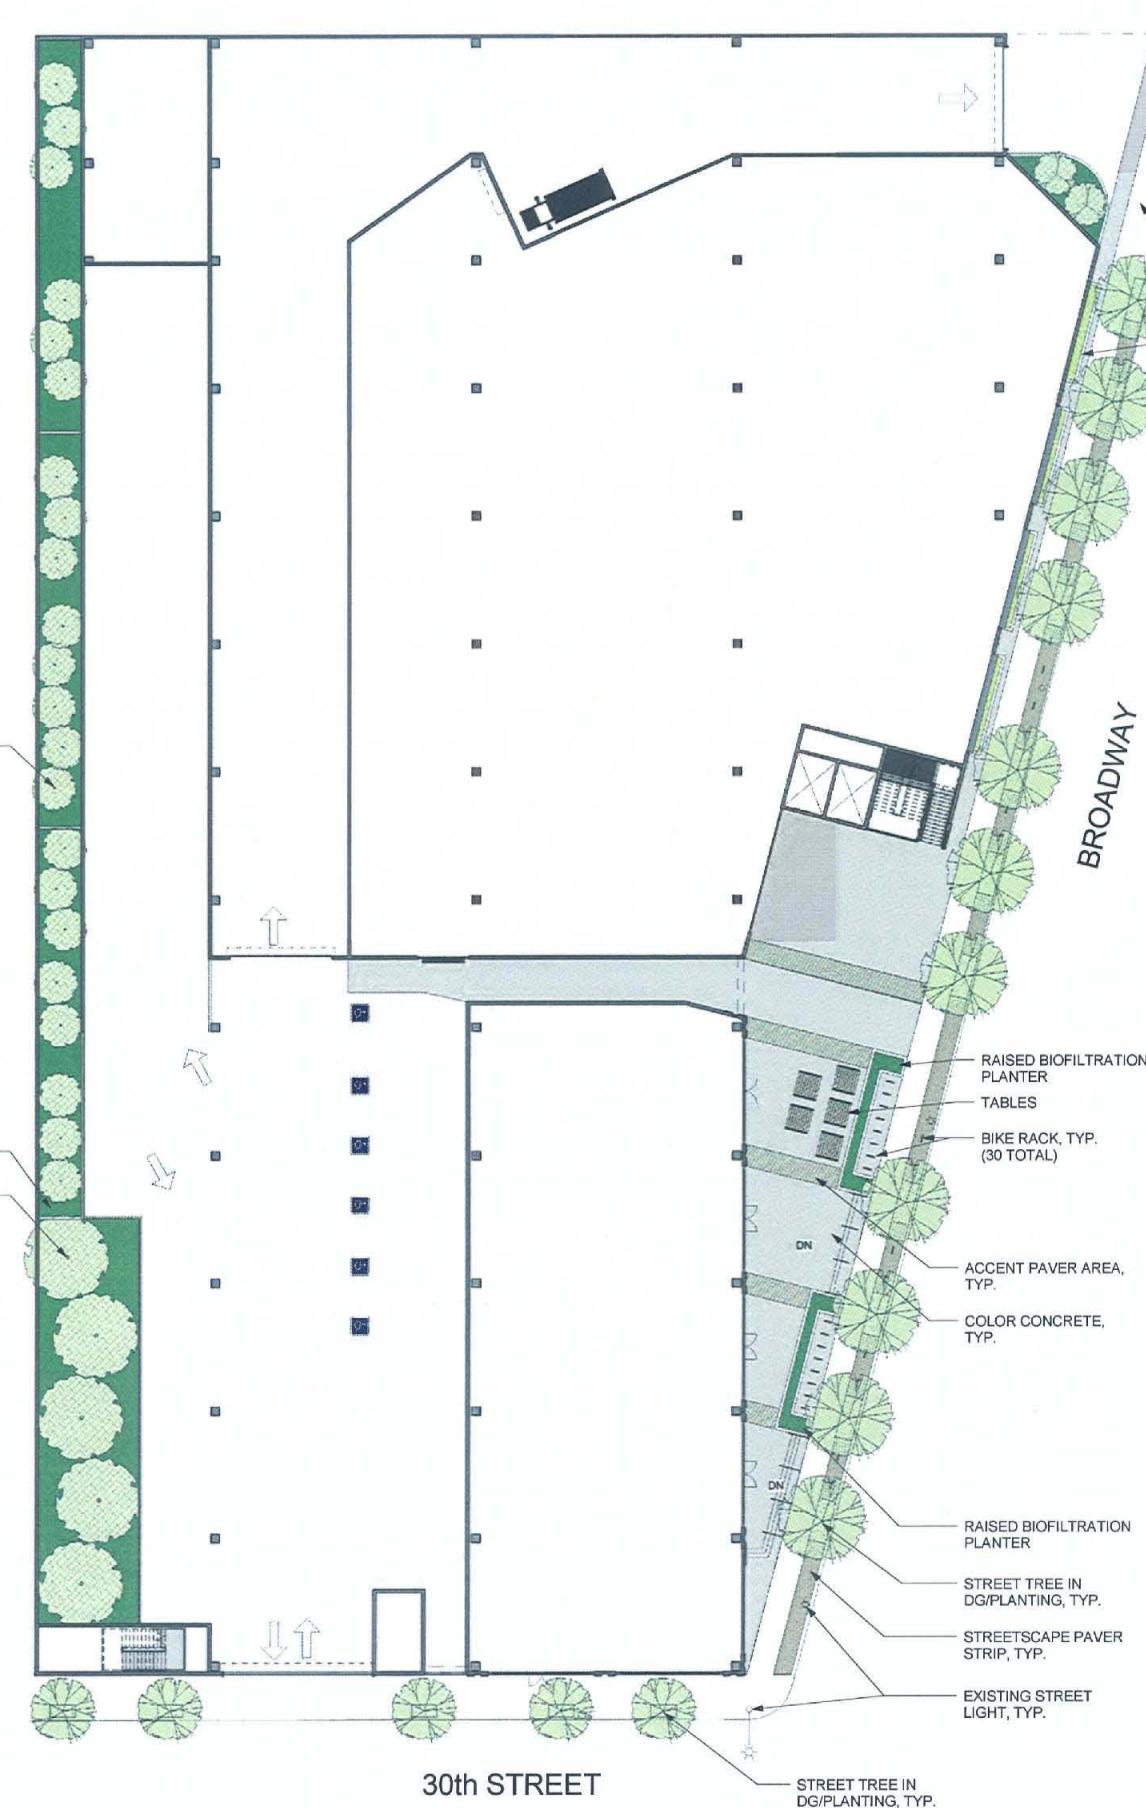
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SIGNAGE PLAN

SHEET NUMBER

A6.1

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CITY OF OAKLAND STANDARD CONCRETE, TYP.
RAISED PLANTER, TYP.

BROADWAY

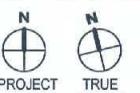30th STREET

STREET TREE IN DG/PLANTING, TYP.

RAISED BIOFILTRATION
PLANTER

TABLES

BIKE RACK, TYP.

(30 TOTAL)

ACCENT PAVER AREA,

TYP.

COLOR CONCRETE,

TYP.

RAISED BIOFILTRATION

PLANTER

STREET TREE IN

DG/PLANTING,

TYP.

STREETSCAPE PAVER

STRIP, TYP.

EXISTING STREET

LIGHT, TYP.

BROADWAY STREET TREE - ACER
RUBRUM 'OCTOBER GLORY'
3/4" = 1'-0"



① SCREEN TREE - POPULUS FREMONTII
3/4" = 1'-0"



② 30th STREET TREE - TRISTANIA LAURINA
'ELEGANT'
3/4" = 1'-0"



③ BROADWAY STREET TREE - ACER
RUBRUM 'OCTOBER GLORY'
3/4" = 1'-0"

LANDSCAPE MATERIAL LEGEND

- COLOR CONCRETE
- ACCENT PAVERS
- STREETSCAPE PAVERS
- CITY OF OAKLAND STANDARD CONCRETE
- PLANTING AREA, SEE PLANT LIST FOR SPECIES
- BIOFILTRATION PLANTING AREA, SEE PLANT LIST FOR SPECIES
- STREET TREE
- SCREEN TREE/LARGE SHRUB IN BIOFILTRATION AREA
- ACCENT TREE
- TABLE
- BIKE RACK

*FOR PLANT LIST SEE SHEET L1.1



PROJECT NAME

THE SHOPS ON
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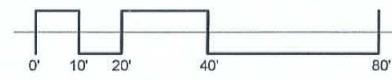
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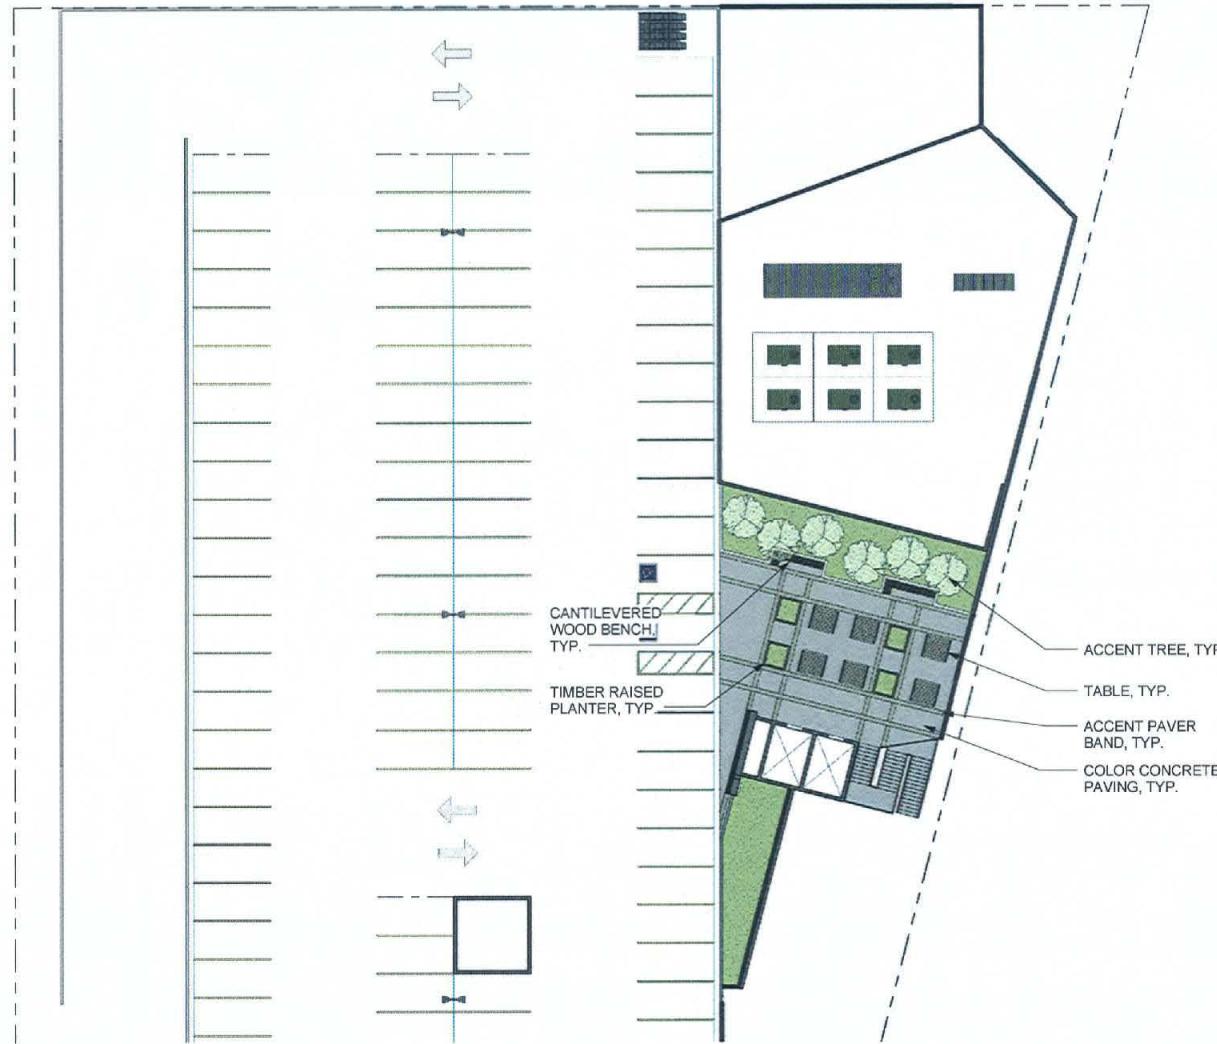
GROUND FLOOR LANDSCAPE PLAN

SHEET NUMBER

L1.0

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CERCIS OCCIDENTALIS - WESTERN REDBUD



ARBUTUS UNEDO 'COMPACTA' - COMPACT STRAWBERRY TREE

① ACCENT TREE
3/4" = 1'-0"

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PLANT LIST				
BOTANICAL NAME	COMMON NAME	CONTAINER SIZE	SPACING (ON CENTER)	BIOFILTRATION PLANT
TREE				
ACER CIRCINATUM	VINE MAPLE	24" BOX	6'	Yes
ACER RUBRUM 'OCTOBER GLORY'	OCTOBER GLORY RED MAPLE	24" BOX	25'	No
ARBUTUS UNEDO 'COMPACTA'	COMPACT STRAWBERRY TREE	24" BOX	6'	No
CERCIS OCCIDENTALIS	WESTERN REDBUD	24" BOX	10'	No
POPULUS FREMONTII	FREMONT POPLAR	24" BOX	20'	Yes
TRISTANIA LAURINA 'Elegant'	WATER GUM	24" BOX	20'	No
SHRUB				
DIETES BICOLOR	FORTNIGHT LILY	5 GAL	3'-0"	Yes
PHILOMIS LANATA	JERUSALEM SAGE	5 GAL	5' O.C.	No
PHORMIUM 'JACK SPRATT'	NEW ZEALAND FLAX	5 GAL	1'-6"	No
PHORMIUM 'SURFER'	NEW ZEALAND FLAX	5 GAL	2'-0"	No
RIBES SANGUINEUM 'CLAREMONT'	FLOWERING CURRENT	5 GAL		Yes
SALVIA MICROPHYLLA 'FREE SPEECH'	FREE SPEECH SAGE	5 GAL	4'-0"	No
GROUNDCOVER				
ACHILLEA MILLEFOLIUM	YARROW	1 GAL	2'-0"	Yes
CHONDROPetalum TECTORUM	CAPE RUSH	5 GAL	4'-0"	Yes
CROCOSMIA 'LUCIFER'	CROCOSMIA	5 GAL	2'-0"	Yes
ERIGERON 'WAYNE RODERICK'	WAYNE RODERICK DAISY	5 GAL	2'	No
GREVILLEA LANIGERA 'COASTAL GEM'	COASTAL GEM GREVILLEA	5 GAL	4'-0"	No
STIPA ARUNDINACEA	NEW ZEALAND WIND GRASS	5 GAL	2'-0"	No
GRASS				
CALAMAGROSTIS X ACUTIFLORA 'KARL FOERSTER'	FEATHER REED GRASS	5 GAL	2'-0"	No
CAREX DIVULSA	BERKELEY SEDGE	1 GAL	1'-6"	Yes
CAREX PANSA	PACIFIC DUNE SEDGE	5 GAL	1'-6"	Yes
LIRIOPE MUSCARIA 'BIG BLUE'	LILY TURF	5 GAL	1'-0"	No
SISYRINCHIUM BELLUM	BLUE-EYED GRASS	1 GAL	1'-6"	Yes
FERN				
POLYSTICHUM MUNITUM	WESTERN SWORD FERN	5 GAL	3'-0"	No

THE IRRIGATION SYSTEM WILL INCLUDE STATE-OF-THE-ART, COMMERCIAL, GRADE EQUIPMENT. ALL SPECIFIED EQUIPMENT AND METHODS WILL COMPLY WITH CALIFORNIA'S WATER EFFICIENT LANDSCAPE ORDINANCE (WELO) AND EBMUD'S SECTION 31 GUIDELINES. THE SYSTEM WILL UTILIZE A "SMART" CONTROLLER TO MANAGE IRRIGATION SCHEDULING, ALLOWING FOR DAILY, AUTOMATIC ADJUSTMENT OF THE IRRIGATION SCHEDULES BASED ON REAL-TIME WEATHER DATA. ALL SPECIFIED EQUIPMENT, AS WELL AS THE DESIGN ITSELF, WILL REFLECT THE NEED FOR DURABILITY AND MINIMAL MAINTENANCE COSTS OVER THE LIFE OF THE PROJECT.



PROJECT NAME THE SHOPS ON BROADWAY

3001-3039 BROADWAY OAKLAND, CA

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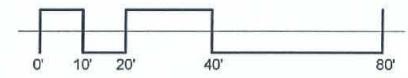


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PROJECT NUMBER:
SHEET TITLE:


ROOF DECK LANDSCAPE PLAN

SHEET NUMBER

L1.1



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PROJECT NAME
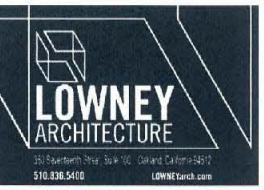
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2930 WOA
EQUIPARC EP 2930 PICNIC TABLE

① TABLES
1" = 1'-0"



2930 WOA




Photo © Adrien Williams

MADRAX 'SQUARE U' BIKE RACK

② BIKE RACK
1" = 1'-0"



③ TIMBER RAISED PLANTER
1" = 1'-0"

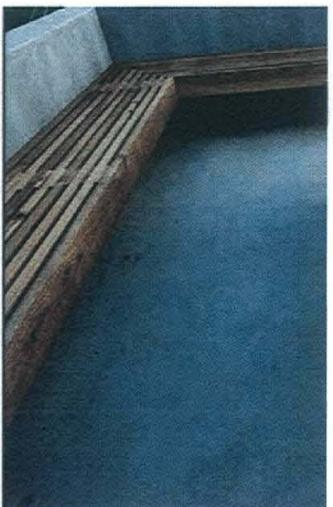

④ CANTILEVERED WOOD BENCH
1" = 1'-0"



⑤ PAVING
1" = 1'-0"
STREETSCAPE PAVERS



ACCENT PAVERS

CONSULTANT



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SITE MATERIALS

SHEET NUMBER

L1.2

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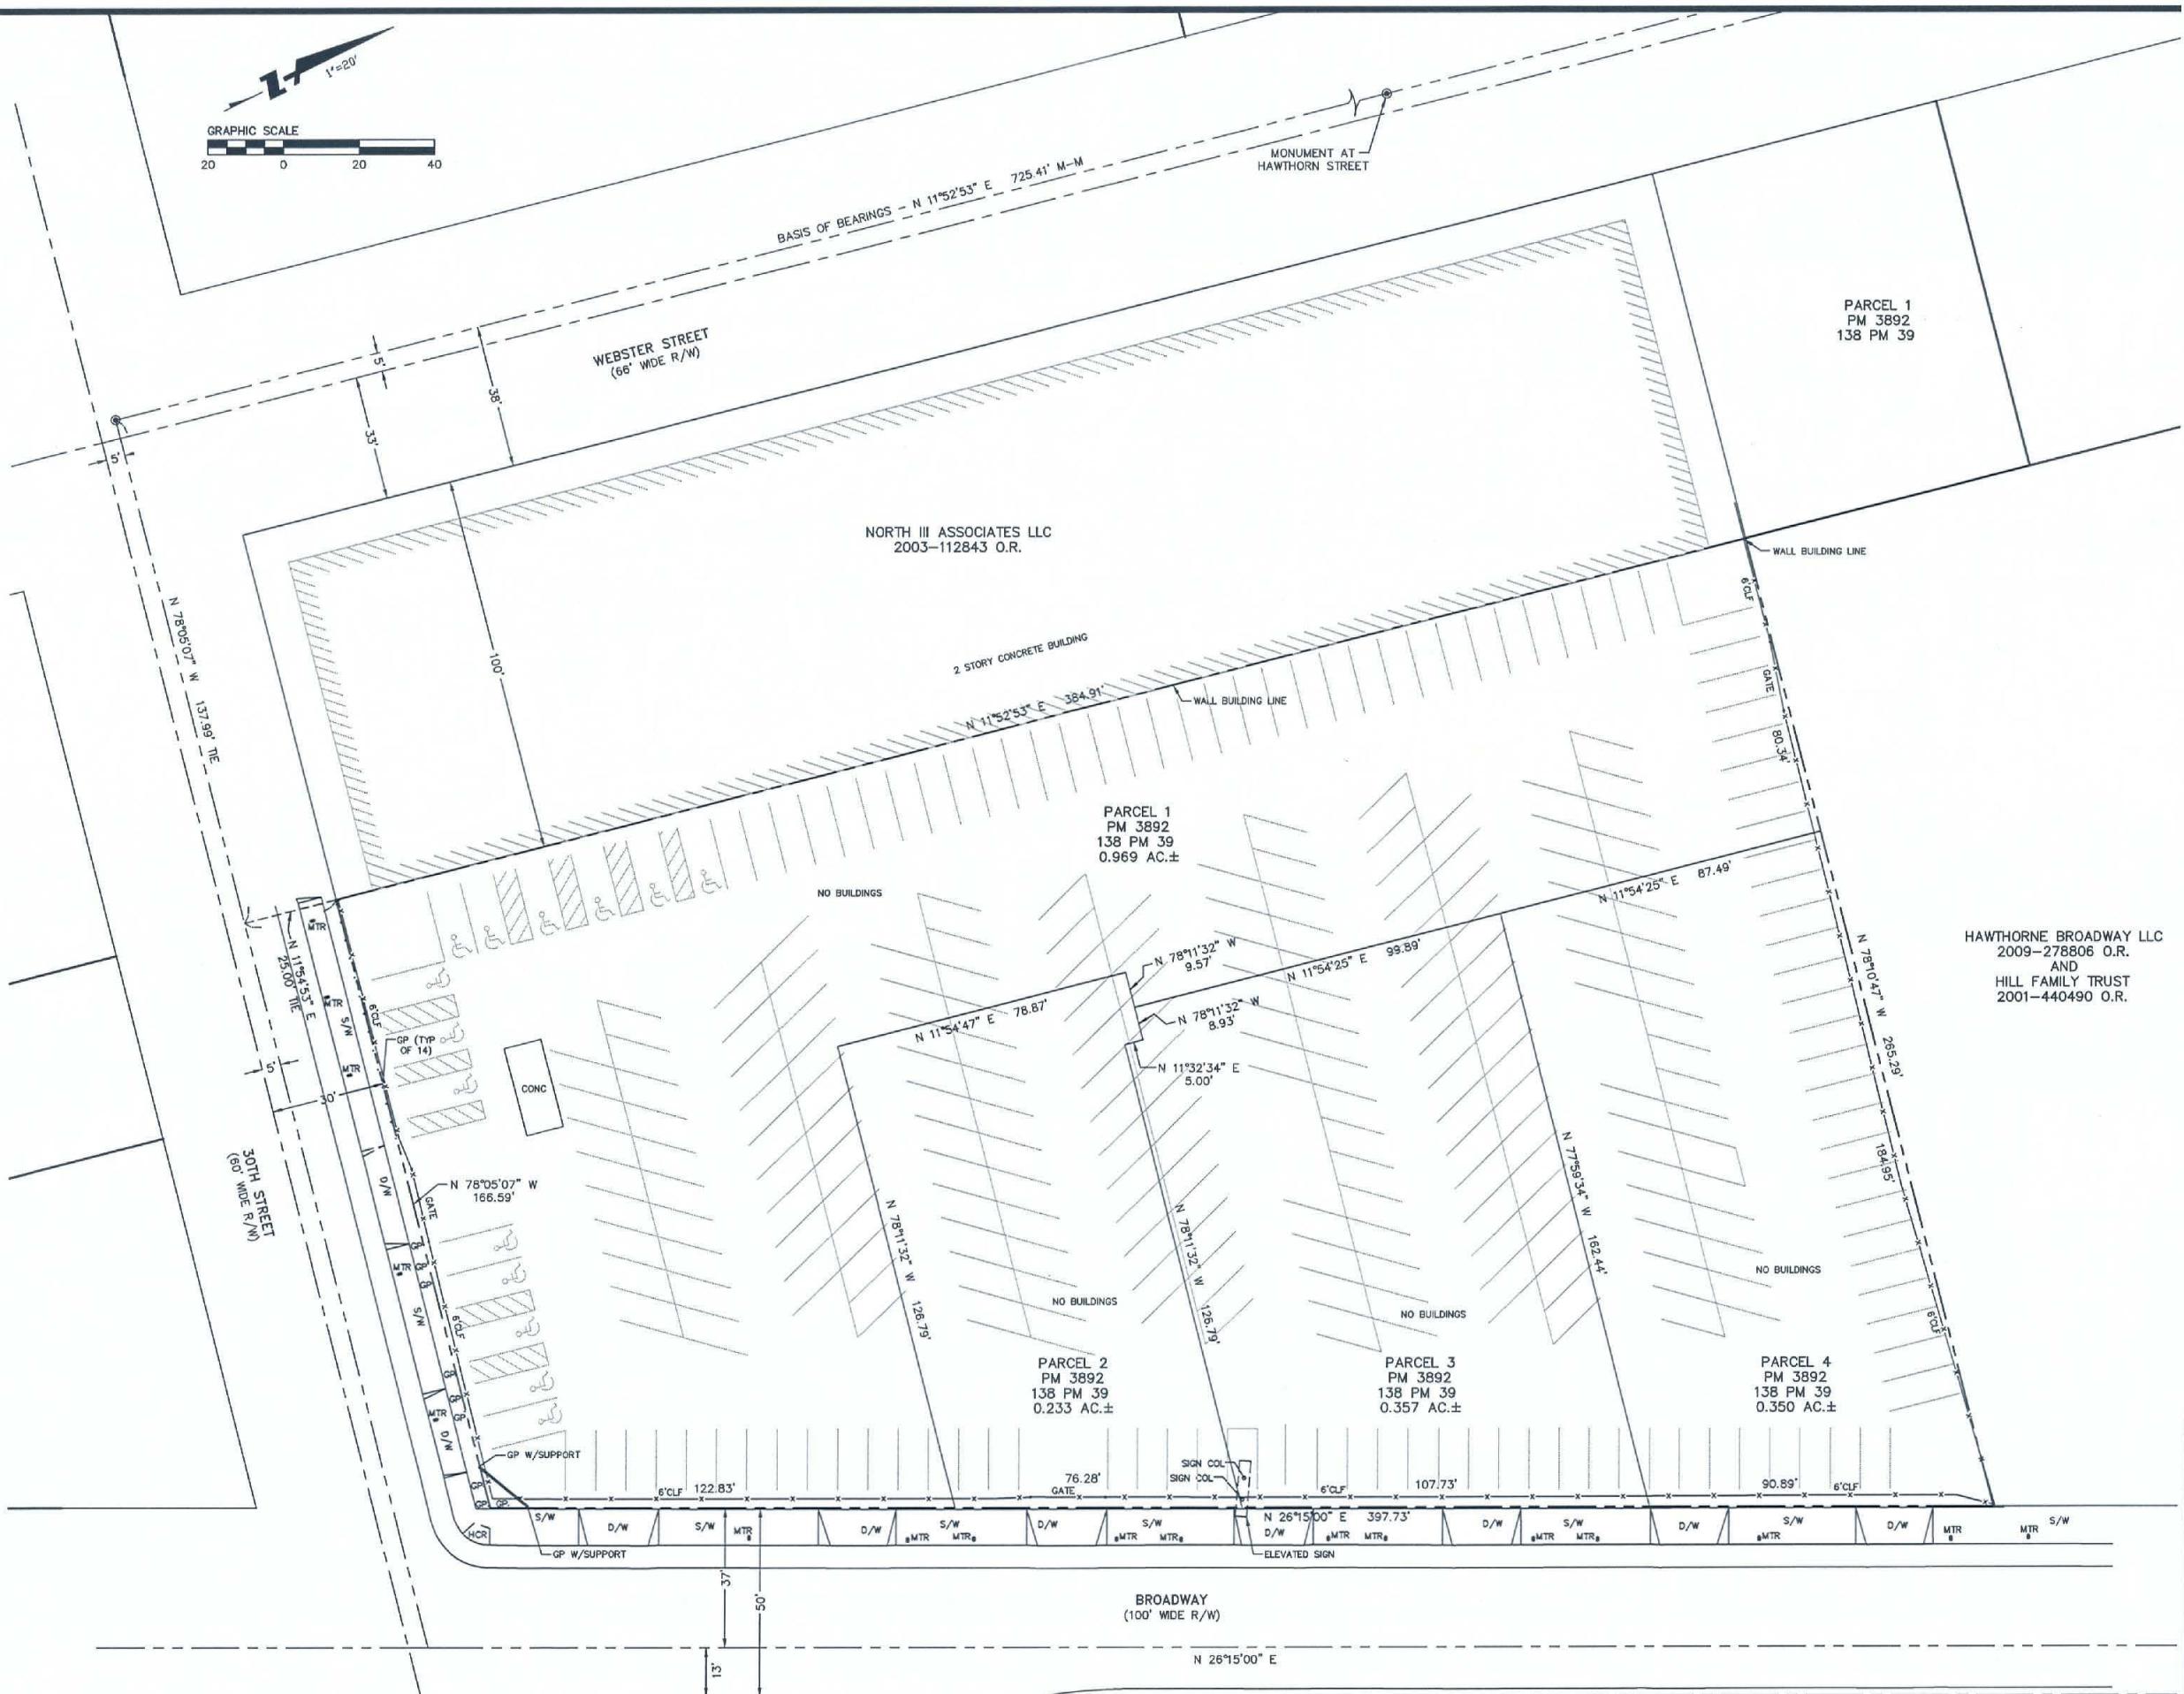
DRAWN BY: JCJ
 PROJECT NUMBER: 127065
 SHEET TITLE:

**EXISTING
CONDITIONS/
SURVEY**

SHEET NUMBER

C1.1

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PROJECT NAME

THE SHOPS ON BROADWAY

3001-3039 BROADWAY
OAKLAND, CA


NOT FOR CONSTRUCTION

CONSULTANT



CONSULTANT STAMP

NO. DATE ISSUES & REVISIONS BY
1 6/26/13 PLANNING SUBMITTAL

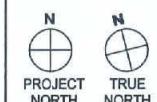

DRAWN BY: JCJ
PROJECT NUMBER: 127065
SHEET TITLE:


EXISTING CONDITIONS/ SURVEY NOTES

SHEET NUMBER

C1.2

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LEGEND:	
X	SUBJECT PROPERTY LINE
X	CENTER LINE
X	MONUMENT LINE
X	FENCE LINE
X	OVERHEAD LINES
OH	FOUND STANDARD CITY MONUMENT
BLDG	ELECTROLIER WITH TRAFFIC SIGNAL
GUY WIRE	FIRE HYDRANT
BLDG	TRAFFIC SIGNAL
BW	BUILDING
CATV	BACK OF WALL
CLF	CABLE TELEVISION BOX
COL	CHAINLINK FENCE
CONC	COLUMN
CONC	CONCRETE
D/W	DRIVEWAY ENTRANCE
EE	ELECTRIC BOX
ELEC	ELECTRIC
EL'	EASTERLY
FE	FENCE
GP	4' HIGH GUARD POST
HCR	HANDICAP RAMP
IN	INSIDE SUBJECT PROPERTY
JP	JOINT POLE
M-M	MONUMENT TO MONUMENT
MTR	PARKING METER
N'LY	NORTHERLY
NW'LY	NORTHWESTERLY
PM	PARCEL MAP
PP	POWER POLE
O.R.	OFFICIAL RECORDS
OUT	OUTSIDE SUBJECT PROPERTY
R/W	RIGHT OF WAY
S'LY	SOUTHERLY
SE'LY	SOUTHEASTERLY
SSCO	SANITARY SEWER CLEANOUT
S/W	SIDEWALK
TEMP	TEMPORARY
W/	WITH
WM	WATER METER

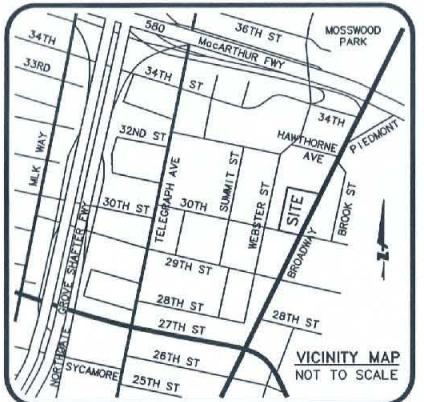

SURVEY REFERENCE NOTES:

TITLE COMPANY: FIRST AMERICAN TITLE COMPANY
THREE LAGOON DRIVE, SUITE 270
REDWOOD CITY, CA 94065
PHONE: (650) 226-2238

TITLE ORDER NO.: 4101-3922389 UPDATED

ESCROW OFFICER: RHONDA WATTS

TITLE REPORT DATE: NOVEMBER 7, 2012

NATURE OF TITLE: A FEE

TITLE VESTED IN: 3840 ASSOCIATES, A CALIFORNIA LIMITED PARTNERSHIP, AS TO AN UNDIVIDED 56% INTEREST, BW30 ASSOCIATES, LP, A CALIFORNIA LIMITED PARTNERSHIP, AS TO AN UNDIVIDED 28% INTEREST, TED W. DANG AND SANDRA WONG DANG, AS TRUSTEES OF THE TD/SW FAMILY TRUST AS DATED JANUARY 25, 1996, AS TO AN UNDIVIDED 16% INTEREST

ZONING: CC-2/D-BR (COMMUNITY COMMERCIAL)/(OVERLAY BROADWAY DISTRICT)

SETBACKS: MINIMUM FRONT: 0'; MAXIMUM FRONT: 10';
MINIMUM INTERIOR SIDE: 0'; MINIMUM STREET SIDE: 0';
REAR (RESIDENTIAL FACILITIES): 10'/15';
REAR (NONRESIDENTIAL FACILITIES): 0'/10'/15'

BUILDING HEIGHT: 75' MAXIMUM

PROPERTY ADDRESS: 3001, 3015, 3025 & 3039 BROADWAY
OAKLAND, CA

ASSESSOR'S PARCEL NO.: 009-0705-004 (PARCEL 1, PM 3892)
009-0705-005 (PARCEL 2, PM 3892)
009-0705-006 (PARCEL 3, PM 3892)
009-0705-007 (PARCEL 4, PM 3892)

AREA: 83,154 SQUARE FEET OR 1.909 ACRES, MORE OR LESS

FLOOD ZONE RATING: FLOOD ZONE "X", AREAS DETERMINED TO BE OUTSIDE THE 0.2% ANNUAL CHANCE FLOODPLAIN PER FEMA FLOOD INSURANCE RATE MAP NUMBER 06001C0059G, EFFECTIVE DATE: AUGUST 3, 2009

PROPERTY DESCRIPTION: (ORDER NO. 4101-3922389)

REAL PROPERTY IN THE CITY OF OAKLAND, COUNTY OF ALAMEDA, STATE OF CALIFORNIA,
DESCRIBED AS FOLLOWS:
PARCELS 1, 2, 3 AND 4, PARCEL MAP 3892, FILED MAY 20, 1983, BOOK 138 OF MAPS,
PAGE 39, ALAMEDA COUNTY RECORDS.

EXCEPTIONS TO FIRST AMERICAN TITLE COMPANY ORDER NO. 4101-3922389

- GENERAL AND SPECIAL TAXES AND ASSESSMENTS. NOT PLOTTABLE.
- GENERAL AND SPECIAL TAXES AND ASSESSMENTS. NOT PLOTTABLE.
- GENERAL AND SPECIAL TAXES AND ASSESSMENTS. NOT PLOTTABLE.
- GENERAL AND SPECIAL TAXES AND ASSESSMENTS. NOT PLOTTABLE.
- LIEN OF SUPPLEMENTAL TAXES, IF ANY. NOT PLOTTABLE.
- DEED OF TRUST. NOT PLOTTABLE.
- MEMORANDUM OF CO-TENANCY AGREEMENT, RECORDED AUGUST 24, 2004, INSTRUMENT NO. 2004384686, OFFICIAL RECORDS. NOT PLOTTABLE.
- THE FACT THAT THE LAND LIES WITHIN THE BOUNDARIES OF THE BROADWAY/MACARTHUR/SAN PABLO REDEVELOPMENT PROJECT AREA, AS DISCLOSED BY THE DOCUMENT RECORDED DECEMBER 3, 2007, INSTRUMENT NO. 2007409575, OFFICIAL RECORDS. NOT PLOTTABLE.
- RIGHTS OF PARTIES IN POSSESSION. NOT PLOTTABLE.
- FINANCING STATEMENT. NOT PLOTTABLE.
- TITLE COMPANY REQUIREMENTS. NOT PLOTTABLE.
- TITLE COMPANY REQUIREMENTS. NOT PLOTTABLE.
- TITLE COMPANY REQUIREMENTS. NOT PLOTTABLE.

NOTES:

- THE BOLD TYPE FOR THE NOTES REGARDING TITLE EXCEPTIONS ARE COMMENTS MADE BY THE PROFESSIONAL SURVEYOR PREPARING THIS ALTA/ACSM LAND TITLE SURVEY AND FOR CLARITY AND EMPHASIS OF THEIR EFFECT.
- ALL DISTANCES AND DIMENSIONS ARE IN FEET AND DECIMALS THEREOF.
- DATE OF FIELD SURVEY: DECEMBER 11, 2012.
- REFER TO RECORD DOCUMENTS AND MAPS FOR FULL REFERENCE OF TITLE EXCEPTIONS WHICH MAY HAVE BEEN OMITTED IN THE INTEREST OF CLARITY AND WHICH ARE BEING MADE A PART OF THIS ALTA/ACSM LAND TITLE SURVEY BY REFERENCE THERETO.
- ENCROACHMENTS SHOWN ON THIS SURVEY ARE MARKED TO THE NEAREST ONE-TENTH (0.1) OF A FOOT AND LABELED IN OR OUT, INDICATING THE ENCROACHMENT LIMIT INSIDE OR OUTSIDE OF SUBJECT BOUNDARY.
- THERE IS NO OBSERVED EVIDENCE OF CURRENT EARTH MOVING, BUILDING CONSTRUCTION OR BUILDING ADDITIONS.
- THERE IS NO OBSERVED EVIDENCE OF RECENT STREET OR SIDEWALK CONSTRUCTION OR REPAIRS.
- THERE IS NO OBSERVED EVIDENCE OF SITE USE AS A SOLID WASTE DUMP, SUMP OR SANITARY LANDFILL.
- ZONING, SETBACKS, AND BUILDING HEIGHT OBTAINED FROM THE CITY OF OAKLAND PLANNING DEPARTMENT.

BASIS OF BEARINGS:

THE BEARING "NORTH 11°52'53" EAST" OF THE MONUMENT LINE OF WEBSTER STREET AS SHOWN ON THAT CERTAIN MAP ENTITLED "PARCEL MAP NO. 3892", FILED MAY 25, 1983, IN BOOK 138 OF PARCEL MAPS AT PAGE 39, IN THE OFFICE OF THE RECORDER OF ALAMEDA COUNTY, WAS USED AS THE BASIS OF BEARINGS FOR THIS SURVEY.

SURVEYOR'S CERTIFICATION:

TO: PORTFOLIO DEVELOPMENT PARTNERS; WELLS FARGO BANK, NATIONAL ASSOCIATION, IT SUCCESSORS AND ASSIGNS; AND FIRST AMERICAN TITLE COMPANY

THIS IS TO CERTIFY THAT THIS MAP OR PLAT AND THE SURVEY ON WHICH IT IS BASED WERE MADE IN ACCORDANCE WITH 2011 MINIMUM STANDARD DETAIL REQUIREMENTS FOR ALTA/ACSM LAND TITLE SURVEYS, JOINTLY ESTABLISHED AND ADOPTED BY ALTA AND NSPS, AND INCLUDES ITEMS 2, 3, 4, 6(b), 7(a), 7(b)(1), 8, 9, 10, 11(a) (SURFACE ONLY), 13, 16, 17, 18, AND 21 OF TABLE A THEREOF. THE FIELD WORK WAS COMPLETED ON DECEMBER 11, 2012.

FOR BKF ENGINEERS:



BARRY T. WILLIAMS, P.L.S. NO. 6711
LICENSE EXPIRES: 06/30/14

DATE: _____



PARKING:

REGULAR SPACES: 228
HANDICAP SPACES: 14
TOTAL SPACES: 242

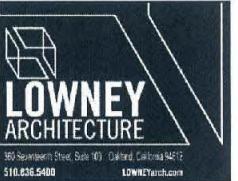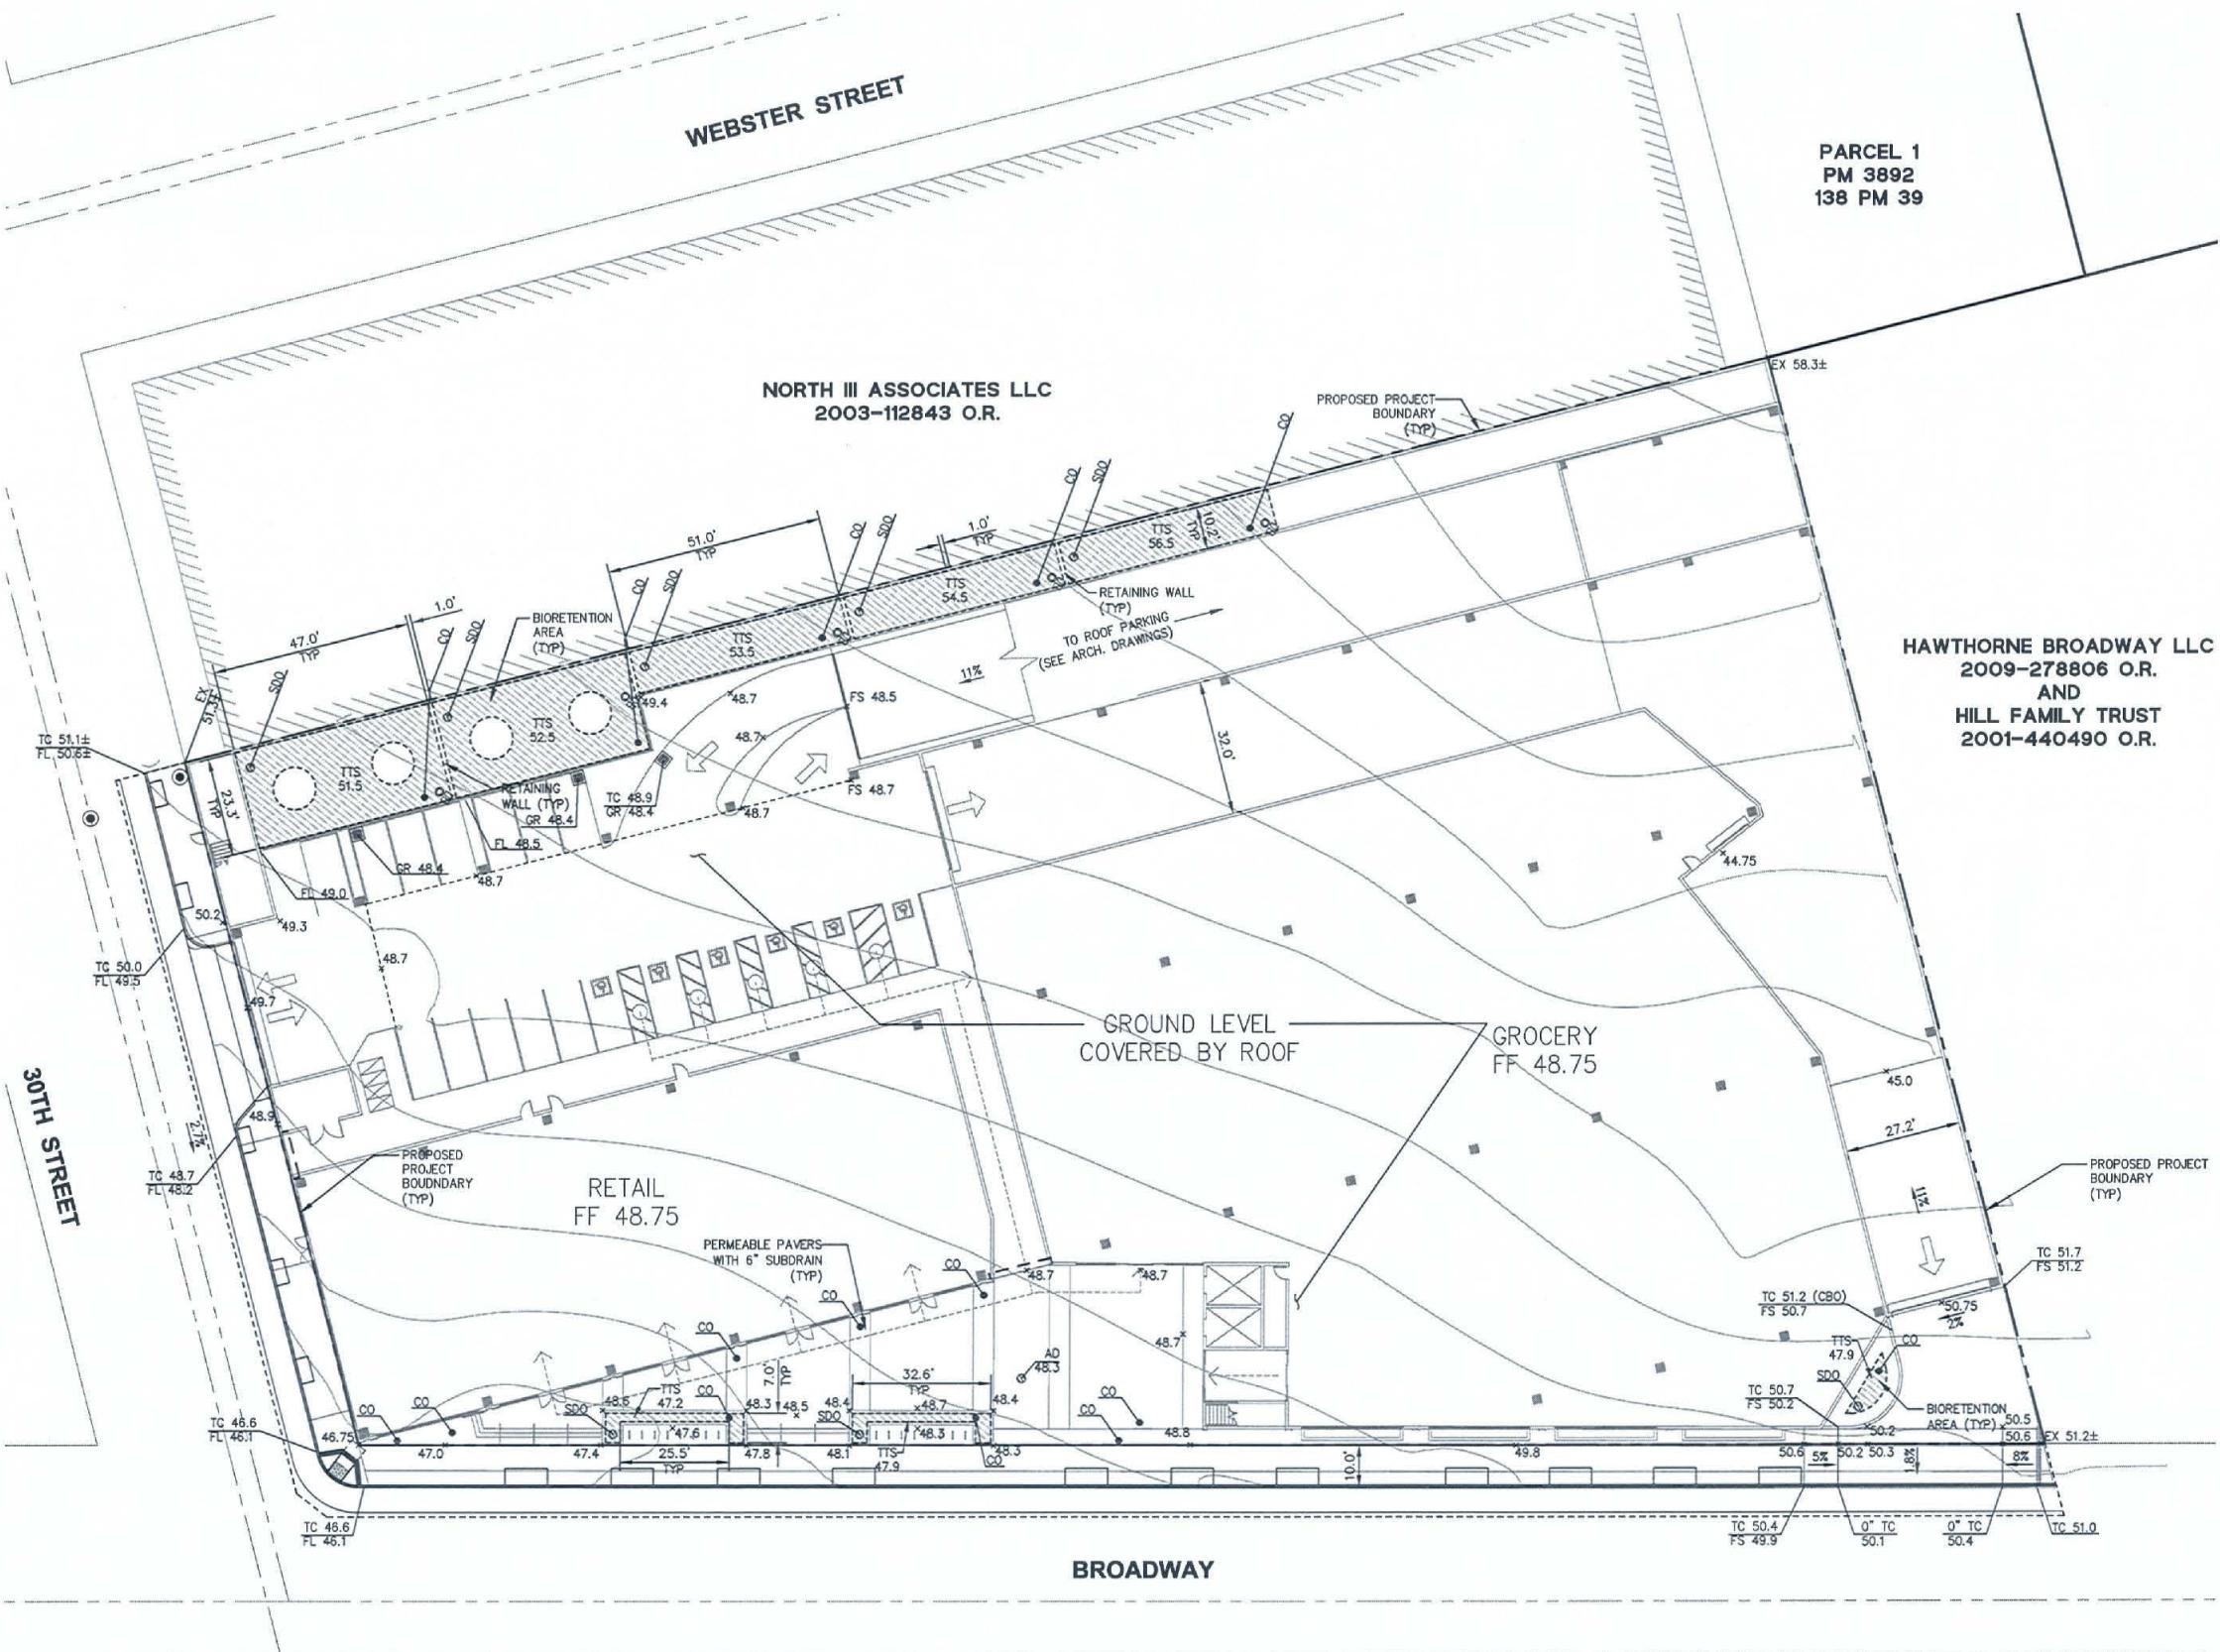

PROJECT NAME

THE SHOPS ON BROADWAY

3001-3039 BROADWAY
OAKLAND, CA

**NOT FOR
CONSTRUCTION**

CONSULTANT



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NO.	DATE	ISSUES & REVISIONS	BY
1	6/26/13	PLANNING SUBMITTAL	

DRAWN BY: JCJ
PROJECT NUMBER: 127065

GRADING AND DRAINAGE PLAN

SHEET NUMBER

C2.1


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PROJECT NAME

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3001-3039 BROADWAY
OAKLAND, CA

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STORMWATER TREATMENT LEGEND:

	DRAINAGE AREA BOUNDARY
	TREATMENT AREA DESIGNATION
	DRAINAGE AREA DESIGNATION
	BIORETENTION AREA
	PROPOSED PROJECT BOUNDARY

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1 6/26/13 PLANNING SUBMITTAL

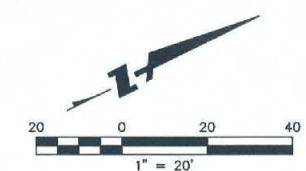

DRAWN BY: JCJ

PROJECT NUMBER: 127065


sheet title:

STORMWATER TREATMENT PLAN

SHEET NUMBER

C3.1


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BROADWAY

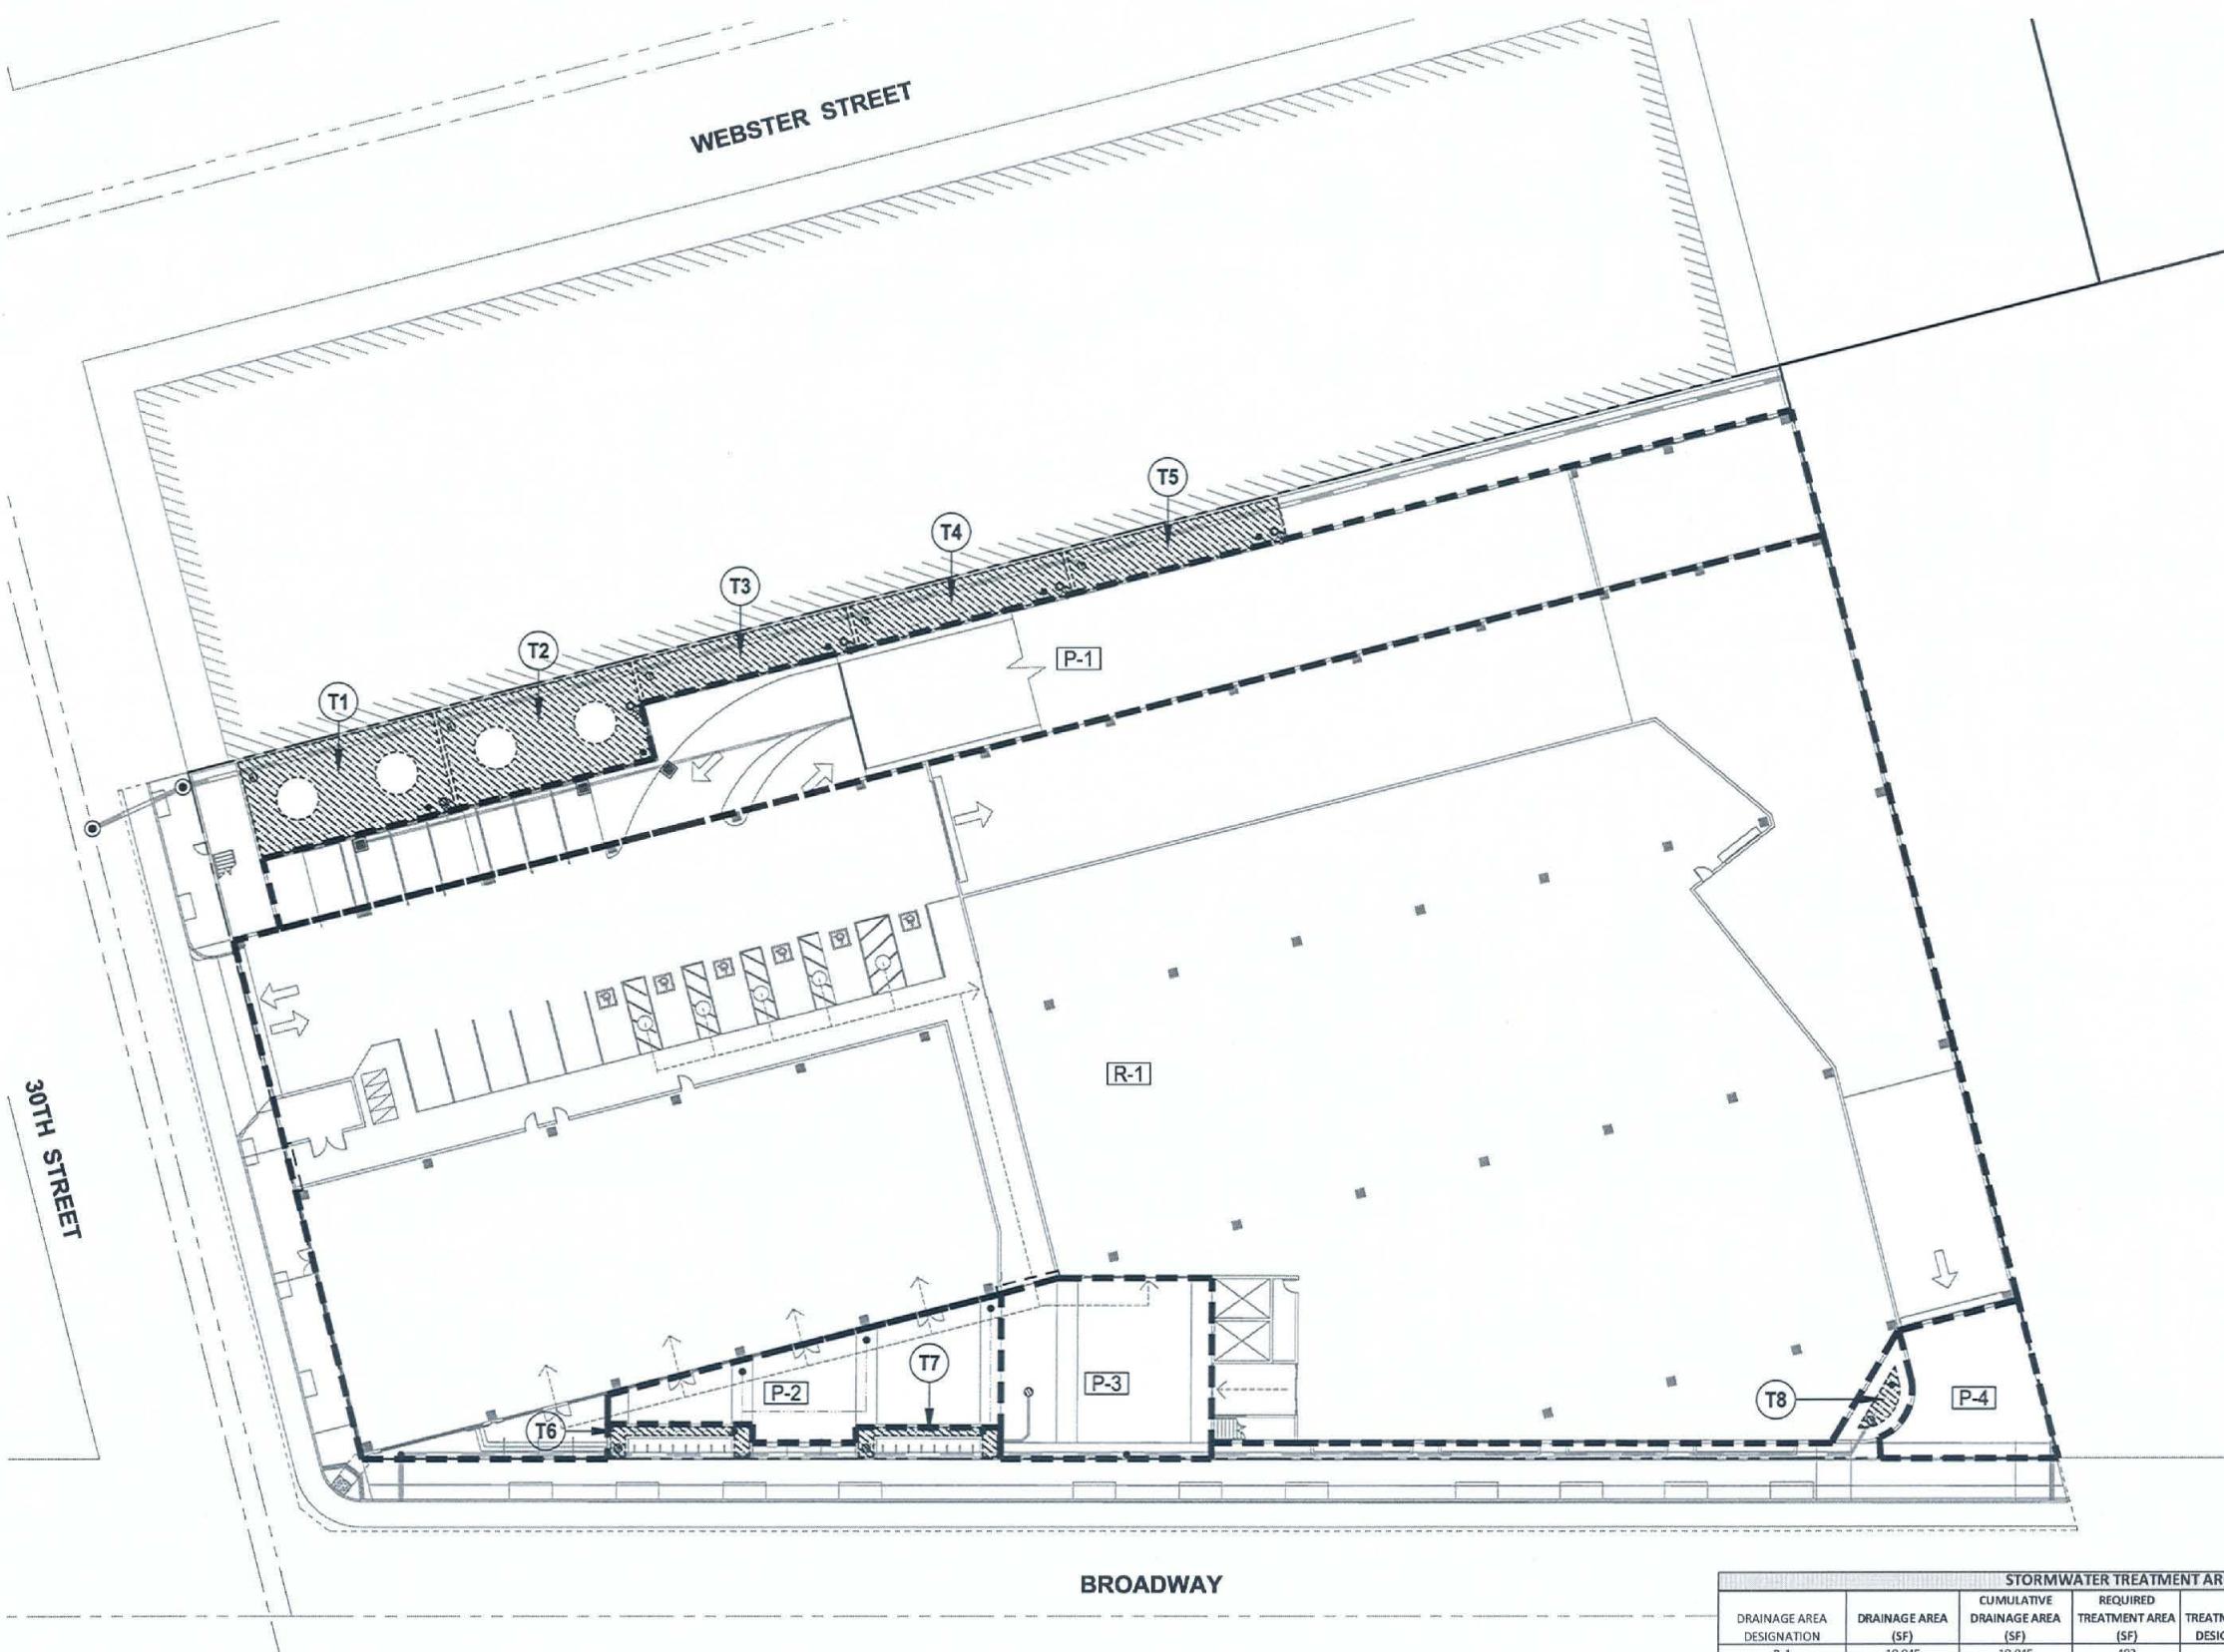STORMWATER TREATMENT AREA SIZING TABLE

DRAINAGE AREA DESIGNATION	DRAINAGE AREA (SF)	CUMULATIVE DRAINAGE AREA (SF)	REQUIRED TREATMENT AREA (SF)	TREATMENT AREA DESIGNATION	PROVIDED TREATMENT AREA (SF)	CUMMULATIVE DRAINAGE AREA (SF)	EXCESS TREATMENT AREA (SF)
P-1	10,045	10,045	2,432	T1	940	2,494	62
				T2	940		
				T3	518		
				T4	518		
				T5	518		
P-2	1,863	1,863	75	T6	100	100	25
P-4	2,073	2,073		T7	100		
P-6	1,106	1,106	44	T8	102	58	14



EROSION CONTROL NOTES:

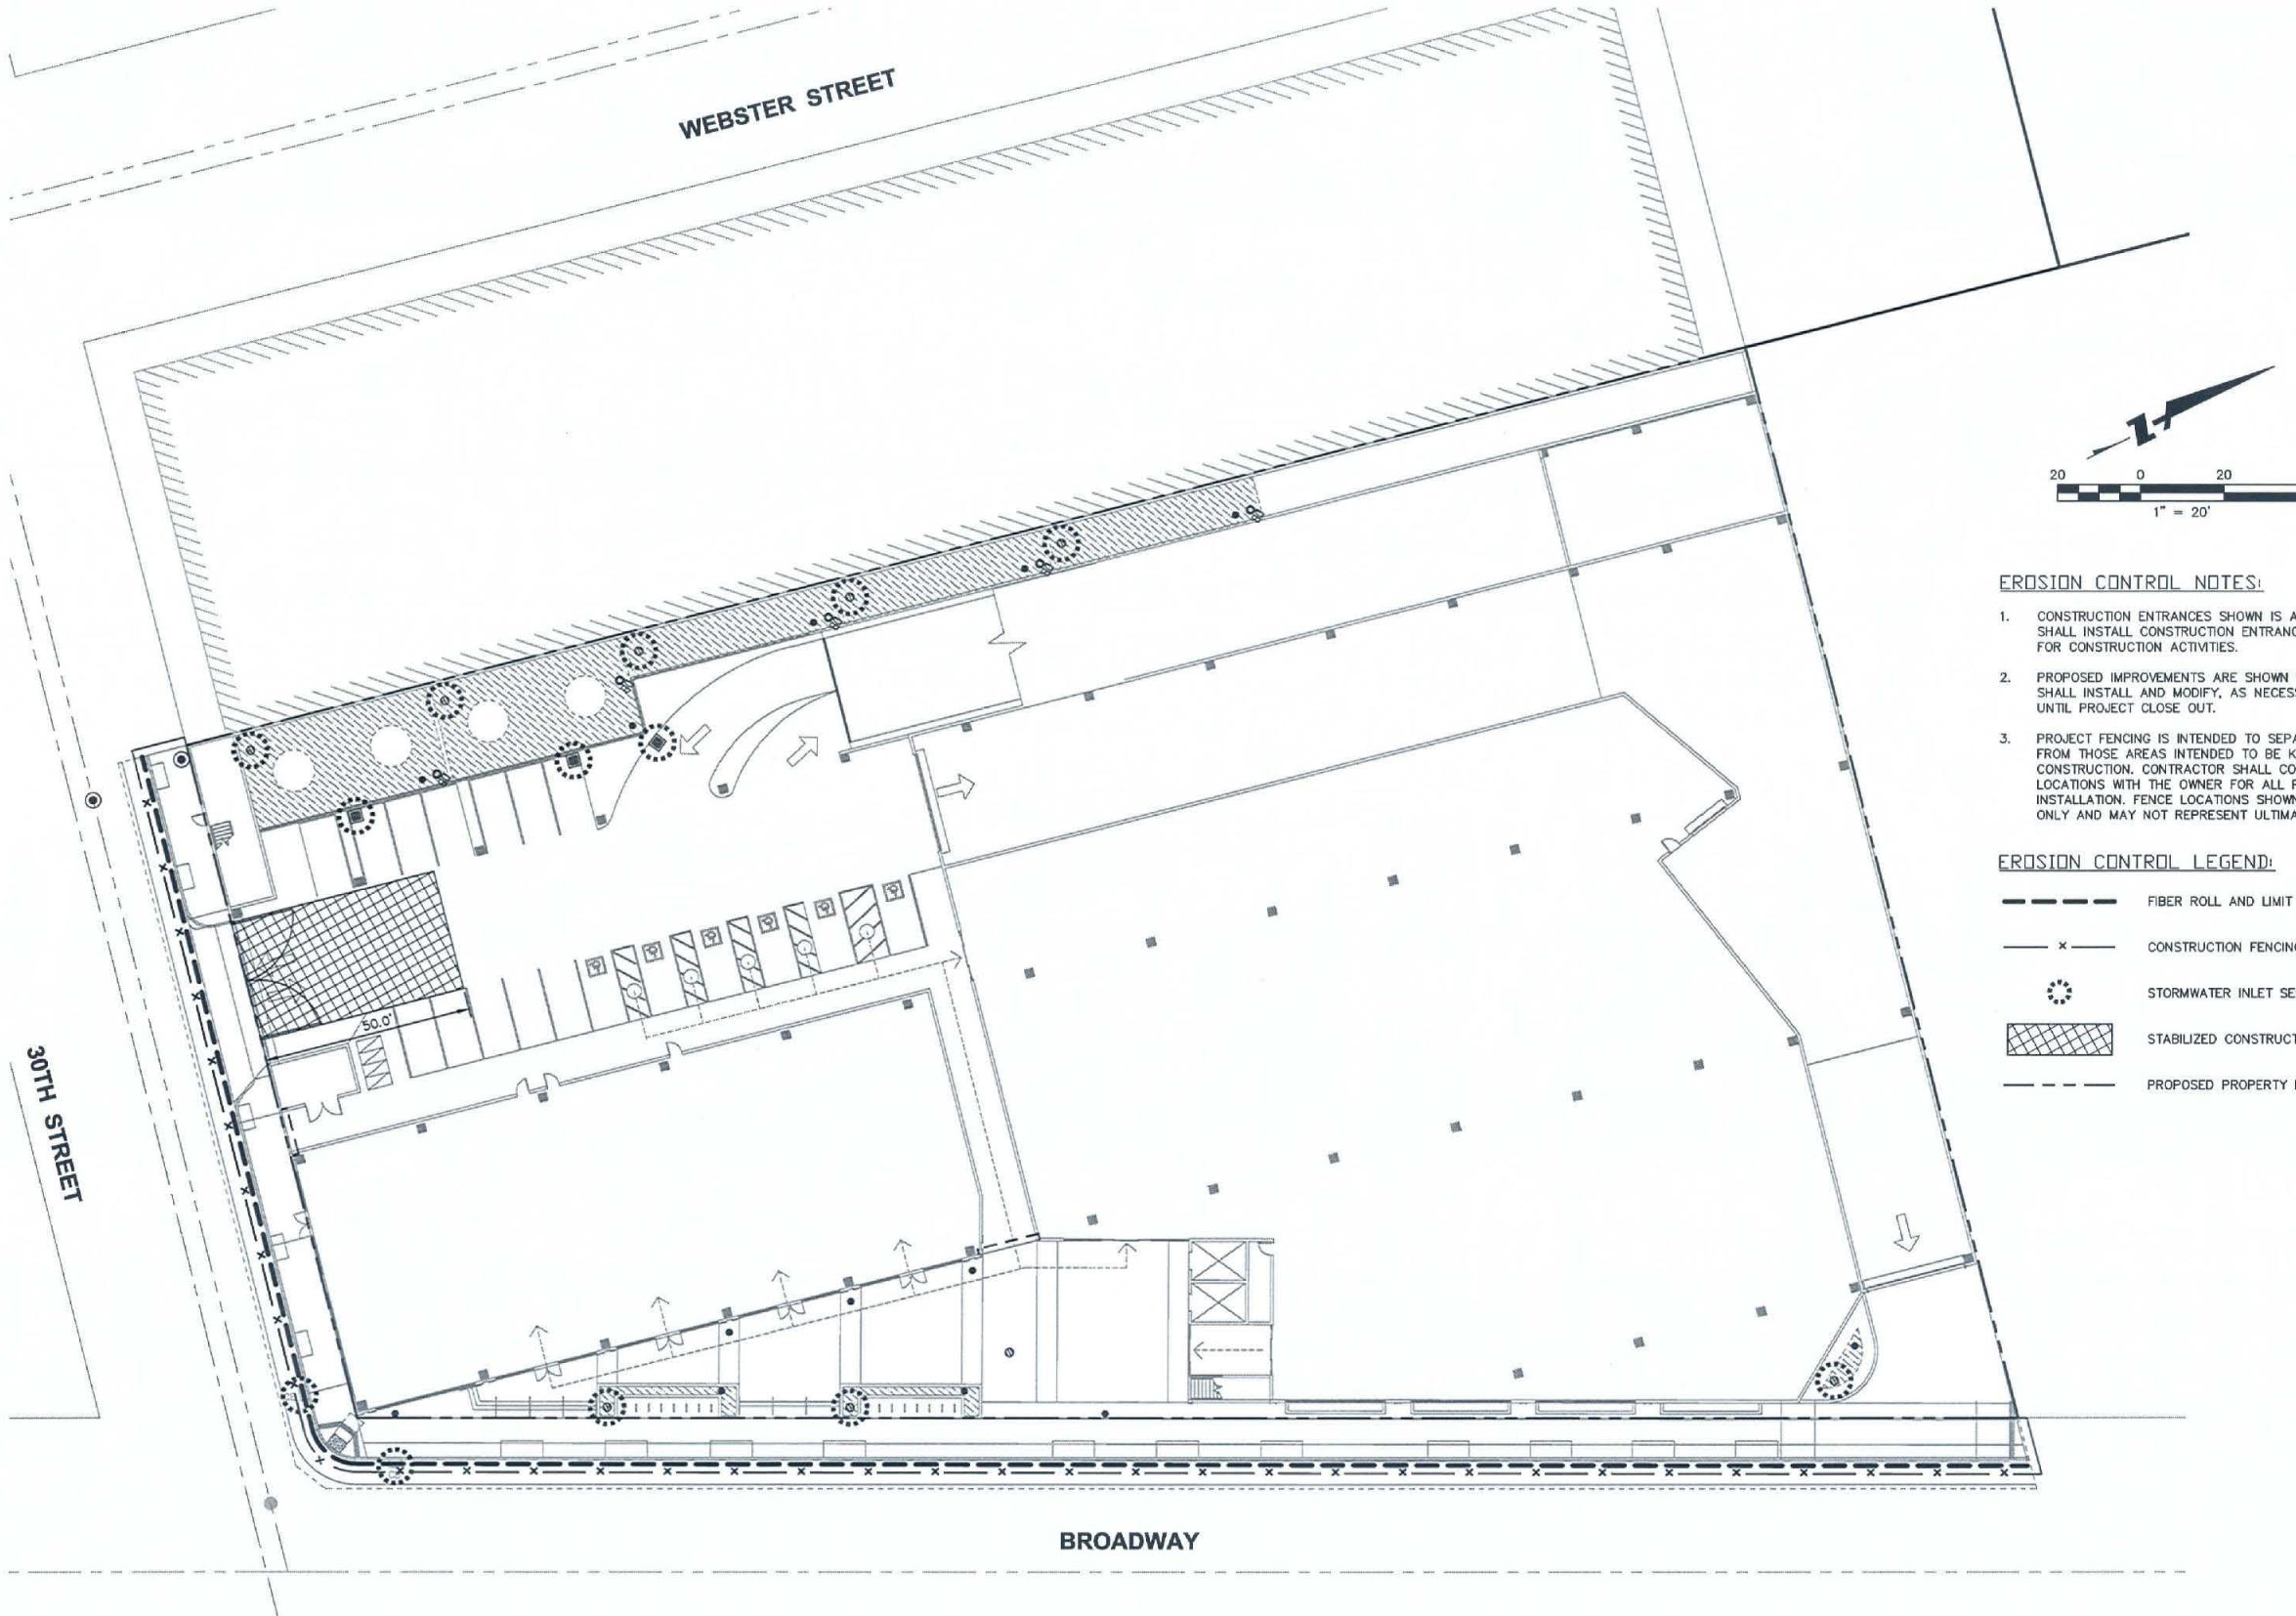
- CONSTRUCTION ENTRANCES SHOWN IS A RECOMMENDATION ONLY. CONTRACTOR SHALL INSTALL CONSTRUCTION ENTRANCES AND PROTECT FENCING AS NEEDED FOR CONSTRUCTION ACTIVITIES.
- PROPOSED IMPROVEMENTS ARE SHOWN WITHIN THE LIMIT OF WORK. CONTRACTOR SHALL INSTALL AND MODIFY, AS NECESSARY, EROSION CONTROL MEASURES UNTIL PROJECT CLOSE OUT.
- PROJECT FENCING IS INTENDED TO SEPARATE THE AREAS OF CONSTRUCTION FROM THOSE AREAS INTENDED TO BE KEPT OPEN AND ACCESSIBLE DURING CONSTRUCTION. CONTRACTOR SHALL COORDINATE ALL PROPOSED FENCING LOCATIONS WITH THE OWNER FOR ALL PHASES OF CONSTRUCTION PRIOR TO INSTALLATION. FENCE LOCATIONS SHOWN ON THIS PLAN ARE DIAGRAMMATIC ONLY AND MAY NOT REPRESENT ULTIMATE FENCING LOCATIONS.

EROSION CONTROL LEGEND:

- Fiber Roll and Limit of Work
- x — Construction Fencing
- Stormwater Inlet Sediment Barrier
- Stabilized Construction Entrance
- - - Proposed Property Boundary

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1 6/26/13 PLANNING SUBMITTAL

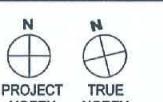


DRAWN BY: JCJ
PROJECT NUMBER: 127065
SHEET TITLE: EROSION CONTROL PLAN

SHEET NUMBER

C4.1

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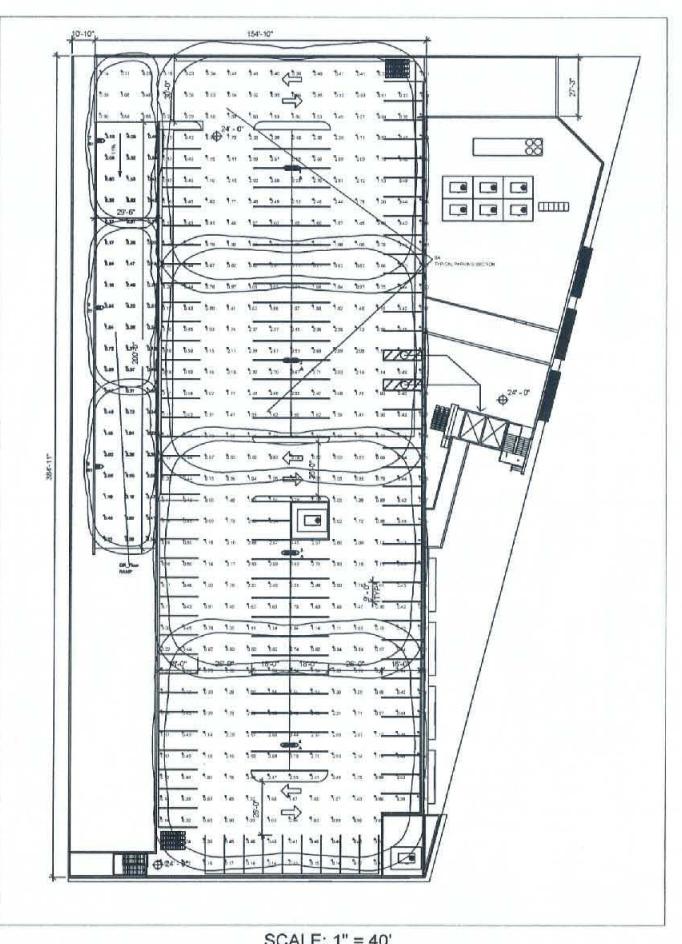
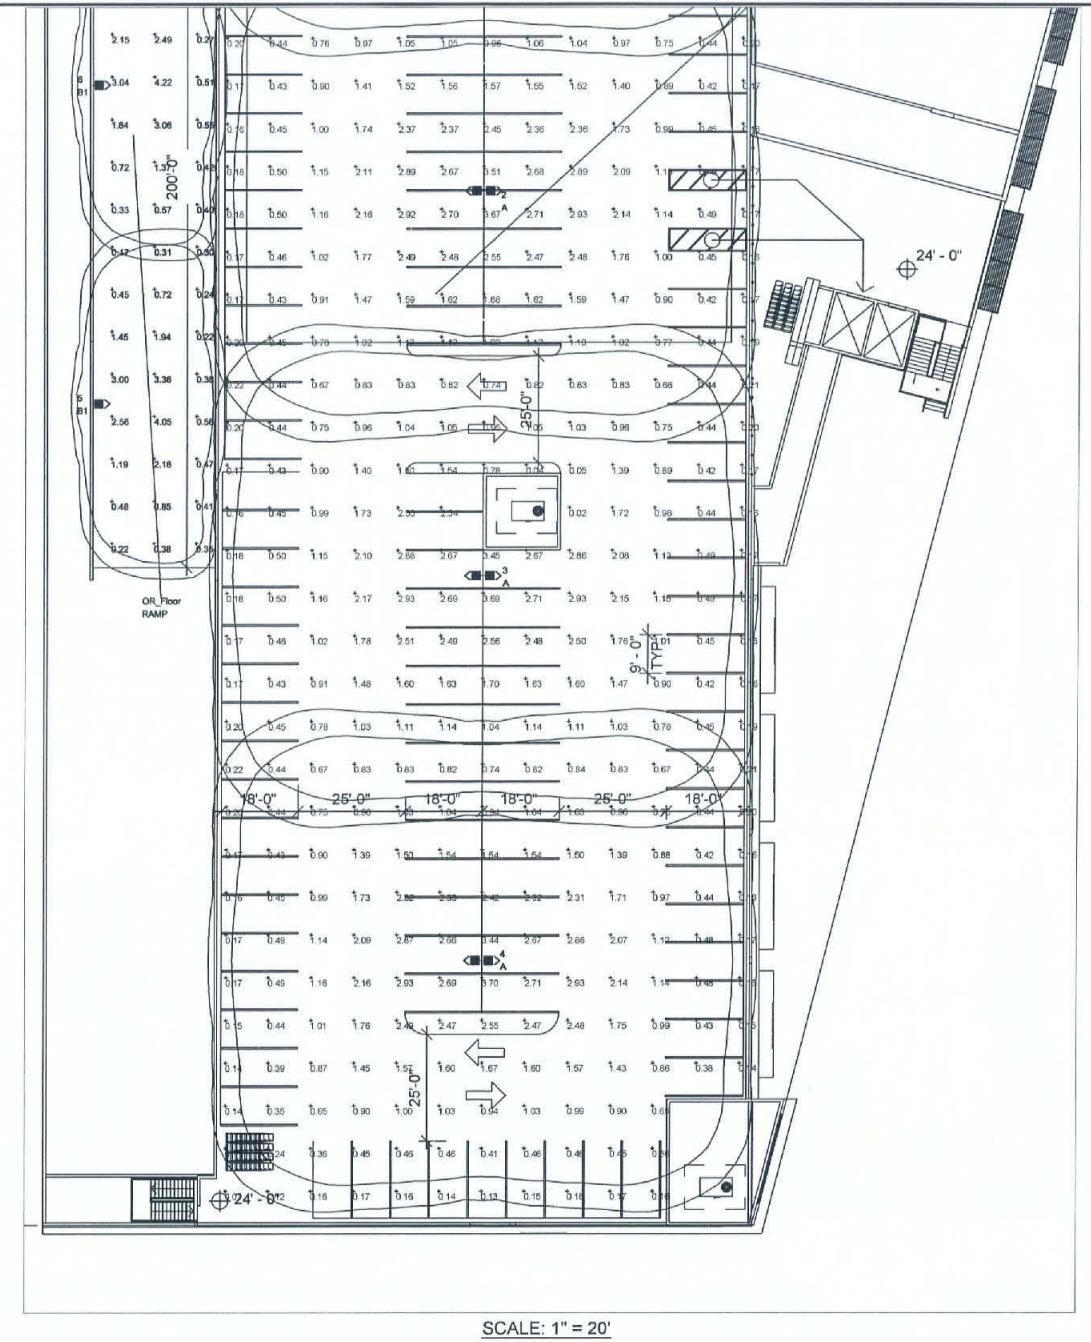
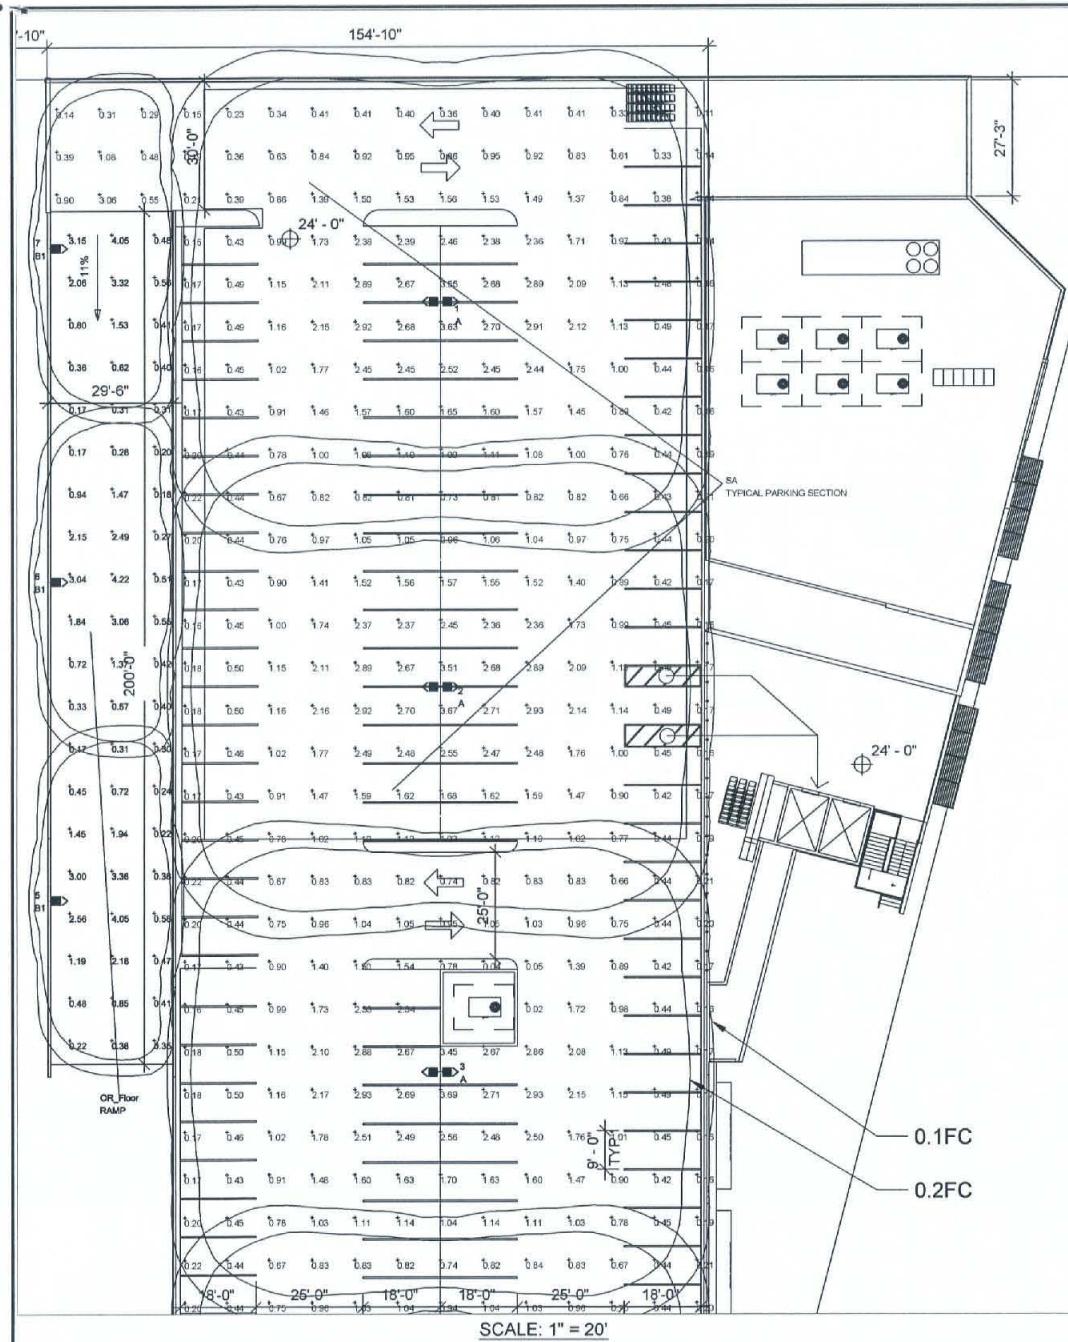


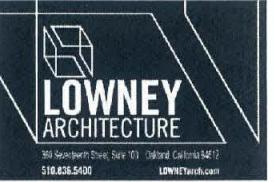PROJECT NAME

THE SHOPS ON
BROADWAY

3001-3039 BROADWAY
OAKLAND, CA

**NOT FOR
CONSTRUCTION**



SCALE: 1" = 40'

Luminaire Schedule											
Project: 30TH & BROADWAY - ROOF PARKING											
Symbol	Qty	Label	Arrangement	Lum. Lumens	Arr. Lum. Lumens	LLF	LLD	LLD	BF	Description	Filename
<---->	4	A	BACK-BACK	8152	16304	0.850	0.900	0.944	1.000	GARDO P21-A1-24-105LA-NW-VOLT - 20' POLE	P21-4-105LA-NWIES
---->	3	B	SINGLE	3552	3552	0.850	0.900	0.944	1.000	GARDO P21-A1-2-80LA-NW-EHHS-VOLT - 8' POLE + 4' BASE	P21-2-80LA-NW-EHHSIES

Calculation Summary										
Project: 30TH & BROADWAY - ROOF PARKING										
Label	CalcType	Units	Avg	Max	Min	Avg/Min	Max/Min	# Pts	Description	
OR_Floor	Illuminance	Fc	1.17	4.22	0.17	6.88	24.82	60	RAMP	
SA	Illuminance	Fc	1.34	3.67	0.22	6.09	16.66	198	TYPICAL PARKING SECTION	

Luminaire Location Summary										
Project: 30TH & BROADWAY - ROOF PARKING										
LumNo	Label	X	Y	Z	Orient	Tilt	Switched			
1	A	104.156	-401.651	19.75	0	0	On			
2	A	104.156	-491.906	19.75	0	0	On			
3	A	104.156	-582.235	19.75	0	0	On			
4	A	104.156	-672.319	19.75	0	0	On			
5	B1	12.433	-541.915	-5.779	0	0	On			
6	B1	12.433	-467.252	2.43	0	0	On			
7	B1	12.433	-388.012	11.066	0	0	On			

Total Quantity: 7

LIGHTING LAYOUT VERIFICATION

ALL VALUES SHOWN ARE MAINTAINED HORIZONTAL FOOTCANDLES AT GRADE

***** PHOTOMETRIC DATA USED AS INPUT FOR THESE CALCULATIONS IS BASED ON ESTABLISHED IES PROCEDURES AND PUBLISHED LAMP, RATINGS, FIELD PERFORMANCE WILL DEPEND ON ACTUAL LAMP, BALLAST, ELECTRICAL AND SITE CHARACTERISTICS.

Calculations have been performed according to IES standards and good practice. Some differences between measured values and calculated results may occur due to tolerances in calculation methods, testing procedures, sensor performance, measurement techniques and field conditions such as voltage and temperature and temperature variations. Input data used to generate the attached calculations such as room dimensions, reflectances, furniture and architectural elements significantly affect the lighting calculations. If the real environment conditions do not match the input data, differences will occur between measured values and calculated values.

Associated Lighting Representatives, Inc.

ASSOCIATED LIGHTING REPRESENTATIVES, INC.
7777 PARTEE LANE
P.O. BOX 2265
OAKLAND, CA 94621
PHONE: (510) 638-0156 - FAX (510) 638-2908

REPORT FOR: LOWNEY ARCHITECTURE; DANIEL BACKMAN
BY: APPLICATIONS ENGINEERING: GILBERTO J. RODRIGUEZ
SALES REPRESENTATIVE: ALR, TIM HALEY

AGI32

AGI32 VERSION 2.36
11041HAL-E ROOF.DWG / .AGI
AGI (C) 1998-2012 LIGHTING ANALYSIS, INC.
104440 BRADFORD ROAD - UNIT A
LITTLETON, CO 80127

PROJECT DESCRIPTION

30TH & BROADWAY - ROOF PARKING
OAKLAND, CA

DRAWING NO./INPUT FILE
11041HAL-E ROOF.DWG / .AGI

SCALE	AS NOTED	SHEET 1 OF 1	DATE 06.06.2013	REV 3
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**TABLE 2-1
SUMMARY OF IMPACTS, MITIGATION MEASURES, STANDARD CONDITIONS OF APPROVAL AND RESIDUAL EFFECTS**

Environmental Impact	Mitigation Measures and Recommendations	Standard Condition of Approval	Level of Significance after application of Mitigation and SCA
Aesthetics	None required		Less than Significant
Impact AES-1: The Project would not adversely affect scenic public vistas or views of scenic resources (Criterion 1 and 2). (Less than Significant)	None required		Less than Significant
Impact AES-2: The Project would not substantially degrade the existing visual character or quality of the site and its surroundings (Criterion 3). (Less than Significant)	None required		Less than Significant
Impact AES-3: The Project would result in new sources of light or glare which would not substantially and adversely affect day or nighttime views in the area. (Criterion 4). (Less than Significant)	None required	AES SCA 1: Lighting Plan	Less than Significant
Impact AES-4: The Project, in combination with other past, present, and reasonably foreseeable future projects within and around the project vicinity, would result in less-than-significant cumulative aesthetics effects. (Less than Significant)	None required		Less than Significant
Air Quality		AQ SCA 1: Construction-Related Air Pollution Controls (Dust and Equipment Emissions)	Less than Significant
Impact AIR-1: Construction of the Project would not result in average daily emissions of more than 54 pounds per day of ROG, NO _x , or PM _{2.5} or 82 pounds per day of PM ₁₀ . (Criterion 1) (Less than Significant)	None required		Less than Significant
Impact AIR-2: The Project would not result in operational average daily emissions of more than 54 pounds per day of ROG, NO _x , or PM _{2.5} or 82 pounds per day of PM ₁₀ , or result in maximum annual emissions of 10 tons per year of ROG, NO _x , or PM _{2.5} or 15 tons per year of PM ₁₀ . (Criterion 2) (Less than Significant)	None required		Less than Significant
Impact AIR-3: The Project would not contribute to carbon monoxide (CO) concentrations exceeding the California Ambient Air Quality Standards (CAAQS) of nine parts per million (ppm) averaged over eight hours and 20 ppm for one hour. (Criterion 3) (Less than Significant)	None required		Less than Significant

TABLE 2-1 (Continued)
SUMMARY OF IMPACTS, MITIGATION MEASURES, STANDARD CONDITIONS OF APPROVAL AND RESIDUAL EFFECTS

Environmental Impact	Mitigation Measures and Recommendations	Standard Condition of Approval	Level of Significance after application of Mitigation and SCA
Air Quality (continued)			Less than Significant
Impact AIR-4: The Project would not expose persons to substantial levels of Toxic Air Contaminants (TACs) resulting in (a) a cancer risk level greater than 10 in one million, (b) a non-cancer risk (chronic or acute) hazard index greater than 1.0, or (c) an increase of annual average $PM_{2.5}$ of greater than 0.3 micrograms per cubic meter by siting a new source or a new sensitive receptor. (Criterion 4) (Less than Significant)	None required		
Impact AIR-5: The Project would not frequently and for a substantial duration, create or expose sensitive receptors to substantial objectionable odors affecting a substantial number of people. (Criterion 5) (Less than Significant)	None required		Less than Significant
Impact AIR-6: The Project would not expose persons, by siting a new source or a new sensitive receptor, to substantial levels of TACs resulting in (a) a cumulative cancer risk level greater than 100 in a million, (b) a cumulative non-cancer risk (chronic or acute) hazard index greater than 10.0, or (c) annual average $PM_{2.5}$ of greater than 0.8 micrograms per cubic meter. (Criterion 6) (Less than Significant)	None required	AQ SCA 1: Construction-Related Air Pollution Controls (Dust and Equipment Emissions)	Less than Significant
Biological Resources		BIO SCA 3: Tree Replacement Plantings	Less than Significant
Impact BIO-1: The Project could fundamentally conflict with the City of Oakland Tree Protection Ordinance (Oakland Municipal Code Chapter 12.36) by removal of protected trees under certain circumstances (Criterion 6). (Less than Significant)	None required		
Impact BIO-2: Construction activity and operations of the Project, in combination with past, present, existing, approved, pending, and reasonably foreseeable future projects in the project vicinity, would not result in impacts on special-status species, sensitive habitats, wildlife movement corridors, wetlands, and other waters of the U.S. (Less than Significant)		BIO SCA 1: Tree Removal During Breeding Season; BIO SCA 2: Tree Removal Permit; BIO SCA 3: Tree Replacement Plantings	Less than Significant

TABLE 2-4 (Continued)
SUMMARY OF IMPACTS, MITIGATION MEASURES, STANDARD CONDITIONS OF APPROVAL AND RESIDUAL EFFECTS

Environmental Impact	Mitigation Measures, and Recommendations	Standard Condition of Approval		Level of Significance after application of Mitigation and SCA
		CUL SCA 4: Vibrations to Adjacent Historic Structures	CUL SCA 1: Archaeological Resources	
Cultural and Paleontological Resources				Less than Significant
Impact CUL-1: The Project would not result in the physical demolition, destruction, relocation, or alteration of historical resources that are listed in, or may be eligible for listing in the federal, state, or local registers of historical resources (Criterion 1). (Less than Significant)	None required	CUL SCA 4: Vibrations to Adjacent Historic Structures	CUL SCA 1: Archaeological Resources	Less than Significant
Impact CUL-2: The Project could result in significant impacts to unknown archaeological resources (Criterion 2). (Less than Significant)	None required	CUL SCA 1: Archaeological Resources	CUL SCA 3: Paleontological Resources	Less than Significant
Impact CUL-3: The Project could directly or indirectly destroy a unique paleontological resource or site or unique geologic feature (Criterion 3). (Less than Significant)	None required	CUL SCA 3: Paleontological Resources	CUL SCA 2: Human Remains, and CUL SCA 3: Paleontological Resources	Less than Significant
Impact CUL-4: The Project could disturb human remains, including those interred outside of formal cemeteries (Criterion 4). (Less than Significant)	None required	CUL SCA 2: Human Remains, and CUL SCA 3: Paleontological Resources	CUL SCA 1: Archaeological Resources; CUL SCA 2: Human Remains; CUL SCA 3: Paleontological Resources; and CUL SCA 4: Vibrations Adjacent to Historic Structures	Less than Significant
Geology, Soils, and Seismicity			GEO SCA 3: Geotechnical Report	Less than Significant
Impact GEO-1: The Project could expose people or structures to seismic hazards such as ground shaking and seismic-related ground failure such as liquefaction, differential settlement, collapse, or lateral spread (Criteria 1 through 4). (Less than Significant)	None required	GEO SCA 3: Geotechnical Report	GEO SCA 2: Soils Report; and GEO SCA 3: Geotechnical Report	Less than Significant
Impact GEO-2: The Project could be subjected to geologic hazards, including expansive soils, subsidence, seismically-induced settlement and differential settlement (Criterion 7). (Less than Significant)	None required	GEO SCA 2: Soils Report; and GEO SCA 3: Geotechnical Report		

TABLE 2-1 (Continued)
SUMMARY OF IMPACTS, MITIGATION MEASURES, STANDARD CONDITIONS OF APPROVAL AND RESIDUAL EFFECTS

Environmental Impact	Mitigation Measures and Recommendations	Standard Condition of Approval	Level of Significance after application of Mitigation and SCA
Geology, Soils, and Seismicity (cont.)			
Impact GEO-3: The Project, when combined with other past, present, existing, approved, pending and reasonably foreseeable development in the vicinity, would not result in significant cumulative impacts with respect to geology, soils or seismicity. (Less than Significant)	None required	GEO SCA 1; Erosion and Sedimentation Control Plan; GEO SCA 2; Soils Report; and GEO SCA 3; Geotechnical Report	Less than Significant
Greenhouse Gases and Climate Change			
Impact GHG-1: The Project would produce greenhouse gas emissions that exceed 1,100 metric tons of CO ₂ e per year, and that would exceed 4.6 metric tons of CO ₂ e per service population annually (Criterion 1). (Significant and Unavoidable)	None feasible	GHG SCA 1: GHG Reduction Plan; GHG SCA 2: Green Building for Residential Structures and Non-residential Structures; GHG SCA 3: Green Building for Building and Landscape Projects; TRANS SCA 1: Parking and Transportation Demand Management; UTIL SCA 1: Waste Reduction and Recycling; AES SCA 1: Lighting Plan; BIO SCA 3: Tree Replacement Planting; GEO SCA 1: Erosion and Sedimentation Control Plan; and HYD SCA 1: Stormwater Pollution Prevention Plan (SWPPP)	Conservatively Significant and Unavoidable
Impact GHG-2: The Project would not conflict with an applicable plant, policy or regulation of an appropriate regulatory agency adopted for the purpose of reducing greenhouse gas emissions (Criterion 2). (Less than Significant)	None required	GHG SCA 1: GHG Reduction Plan; AQ SCA 1: Construction-Related Air Pollution Controls (Dust and Equipment Emissions); HAZ SCA 2: Asbestos Removal in Structures; GEO SCA 1: Erosion and Sedimentation Control Plan; HYD SCA 1: Stormwater Pollution Prevention Plan (SWPPP); AES SCA 1: Lighting Plan; BIO SCA 2: Tree Removal Permit; and UTIL SCA 1: Waste Reduction and Recycling	Less than Significant
Hazards and Hazardous Materials			
Impact HAZ-1: The Project would result in an increase in the routine transportation, use, and storage of hazardous chemicals, however, no significant public hazard would result (Criteria 1 and 3). (Less than Significant)	None required	HAZ SCA 1: Hazards Best Management Practices	Less than Significant

SUMMARY OF IMPACTS, MITIGATION MEASURES, STANDARD CONDITIONS OF APPROVAL AND RESIDUAL EFFECTS

TABLE 2-1 (Continued)

Environmental Impact	Mitigation Measures and Recommendations	Standard Condition of Approval	Level of Significance after application of Mitigation and SCA
Risks and Hazardous Materials (Cont.)			
Impact HAZ-2: The Project could result in the accidental release of hazardous materials used during construction through improper handling or storage, however, compliance with regulatory requirements will ensure no significant public hazard would result (Criterion 2). (Less than Significant)	None required	HAZ SCA 1: Hazards Best Management Practices; HAZ SCA 5: Lead-Based Paint/Coatings, Asbestos, or PCB Occurrence Assessment; HAZ SCA 6: Environmental Site Assessment Reports Remediation; and HAZ SCA 9: Health and Safety Plan per Assessment	Less than Significant
Impact HAZ-3: The Project could result in the exposure of hazardous materials in soil and ground water, however, compliance with regulatory requirements will ensure no significant public hazard would result (Criteria 2 and 5). (Less than Significant)	None required	HAZ SCA 1: Hazards Best Management Practices; HAZ SCA 5: Lead-Based Paint/Coatings, Asbestos, or PCB Occurrence Assessment; HAZ SCA 6: Environmental Site Assessment Reports Remediation; HAZ SCA 9: Health and Safety Plan per Assessment; and HAZ SCA 10: Radon or Vapor Intrusion.	Less than Significant
Impact HAZ-4: The Project could result in the exposure of hazardous building materials during building demolition, however, compliance with regulatory requirements will ensure no significant public hazard would result (Criterion 2). (Less than Significant)	None required	HAZ SCA 7: Lead-based Paint Remediation, and HAZ SCA 2: Asbestos Removal in Structures	Less than Significant
Impact HAZ-5: The Project would require use of hazardous materials within 0.25 mile of a school, however, compliance with regulatory requirements will ensure that no significant public hazard would result (Criteria 3 and 4). (Less than Significant)	None required	HAZ SCA 11: Hazardous Materials Business Plan	Less than Significant
Impact HAZ-6: The Project would not result in fewer than two emergency access routes for streets exceeding 500 feet in length and would not physically interfere with an adopted emergency response plan or emergency evacuation plan (Criteria 6 and 9). (Less than Significant)	None required		Less than Significant
Impact HAZ-7: The Project, when combined with other past, present, existing, approved, pending and reasonably foreseeable development in the vicinity, would not result in significant cumulative hazards. (Less than Significant)	None required	HAZ SCA 8: Other Materials Classified as Hazardous Waste; HAZ SCA 12: Hazardous Materials Business Plan; and HAZ SCA 3: Site Review by Fire Services Division	Less than Significant

SUMMARY OF IMPACTS, MITIGATION MEASURES, STANDARD CONDITIONS OF APPROVAL AND RESIDUAL EFFECTS

Environmental Impact	Mitigation Measures and Recommendations	Standard Condition of Approval	Level of Significance after application of Mitigation and SCA
Hydrology and Water Quality			
Impact HYD-1: The Project could alter drainage patterns and increase the volume of stormwater or the level of contamination or siltation in stormwater flowing from the project site, however, compliance with applicable regulatory requirements will ensure that no significant impacts would result (Criteria 1, 3 through 7, and 12). (Less than Significant)	None required	HYD SCA 1: Stormwater Pollution Prevention Plan; HYD SCA 2: Post-construction Stormwater Pollution Management Plan; HYD SCA 3: Maintenance Agreement for Stormwater Treatment Measures; and UTIL SCA 2: Stormwater and Sewer	Less than Significant
Impact HYD-2: The Project could be susceptible to flooding hazards in the event of dam or reservoir failure (Criteria 10 and 11). (Less than Significant)	None required		Less than Significant
Impact HYD-3: The Project would not be susceptible to inundation in the event of sea-level rise (Criterion 11). (Less than Significant)	None required		Less than Significant
Impact HYD-4: The Project would not adversely affect the availability of groundwater supplies or interfere substantially with groundwater recharge (Criterion 2). (Less than Significant)	None required		Less than Significant
Impact HYD-5: The Project would not be susceptible to mudflow, seiche, and tsunami-related hazards (Criterion 11). (Less than Significant)	None required		Less than Significant
Impact HYD-6: The Project, combined with past, present, existing, approved, pending, and reasonably foreseeable future projects would not result in potentially significant cumulative impacts to hydrologic resources. (Less than Significant)	None required		Less than Significant
Land Use, Plans, and Policies			
Impact LU-1: The Project would not result in the physical division of an existing community or conflict with adjacent or nearby land uses (Criteria 1 and 2). (Less than Significant)	None required		Less than Significant

TABLE 2-1 (Continued)
SUMMARY OF IMPACTS, MITIGATION MEASURES, STANDARD CONDITIONS OF APPROVAL AND RESIDUAL EFFECTS

Environmental Impact	Mitigation Measures and Recommendations	Level of Significance after application of Mitigation and SCA
Land Use, Plans, and Policies (cont.)	Standard Condition of Approval	
Impact LU-2: The Project would not conflict with applicable land use plans and policies adopted for the purpose of avoiding or mitigating an environmental effect (Criterion 3). (Less than Significant)	None required	Less than Significant
Impact LU-3: The Project would not fundamentally conflict with any applicable habitat conservation plan or natural community conservation plan (Criterion 4). (Less than Significant)	None required	Less than Significant
Impact LU-4, 7: The Project, combined with cumulative development in the defined geographic area, including past, present, existing, approved, pending, and reasonably foreseeable future development, does not result in any significant adverse cumulative impacts in the area. (Less than Significant)		
Impact NOI-1: The Project would not result in substantial temporary or periodic increases in ambient noise levels in the project area above existing levels without the Project and in excess of standards established in the local general plan or noise ordinance, or applicable standards of other agencies (Criteria 1, 2 and 8). (Less than Significant)	None required	Less than Significant
Impact NOI-2: Days/Hours of Construction		Less than Significant
Operation; NOI SCA 2: Noise Control; NOI SCA 3: Noise Complaint Procedures; NOI SCA 6: Vibration; and NOI 7: Pile Driving and Other Extreme Noise Generators		
Implementation of NOI SCA 2: Noise Control:		
1. Temporary Noise Barrier: During all construction activities, a temporary noise barrier of approximately 385 feet in length shall be located along or near the west property line of the project site, as shown generally in Figure 4.10.3. The noise barrier shall require a maximum 10-foot return on each end and be oriented 45 degrees into the construction site.		
a. Construction Site:		
(i) The temporary noise barrier could be constructed of a sound blanket system hung on scaffolding to achieve a minimum height (described below) and to allow the		

TABLE 2-1 (Continued)
SUMMARY OF IMPACTS, MITIGATION MEASURES, STANDARD CONDITIONS OF APPROVAL AND RESIDUAL EFFECTS

Environmental Impact	Mitigation Measures and Recommendations	Standard Condition of Approval	Level of Significance after application of Mitigation and SCA
Noise and Vibration (cont.)	Impact NOI-1 (cont.)	<p>system to be moved or adjusted if necessary to allow construction activity immediately adjacent to the west property line.</p> <p>(ii) An alternative temporary noise barrier design could consist of plywood installed on top of a portable concrete K-Rail system which also allows the ability to move or adjust the wall location.</p> <p>The minimum height of the temporary noise barrier design "i" or "ii" situated on the project site would range from at least 16 feet tall near the south property line (30th Street end) to 10 feet tall near the north property line, to maintain at least 6 feet of the barrier above the existing retaining wall (which is approximately 10 feet tall at the south property line and four feet tall at the north property line). This minimum height is prescribed to block the line of sight between the receptor property and the construction site for maximum effectiveness.</p>	<p>b. Receptor Site</p> <p>(i) As an alternative to an on-site temporary noise barrier (described above in "a" and "b"), the applicant shall coordinate with the owner/operator of the adjacent Oakland Healthcare and Wellness Center property and evaluate the feasibility of locating a temporary noise barrier design on the receptor property, specifically along the elevated walkway between the residential units and the shared property line. This approach would allow a 6-foot-tall barrier on top of the elevated walkway to block the line of</p>
			2-12

TABLE 2-1 (Continued)
SUMMARY OF IMPACTS, MITIGATION MEASURES, STANDARD CONDITIONS OF APPROVAL AND RESIDUAL EFFECTS

Environmental Impact	Mitigation Measures and Recommendations	Standard Condition of Approval	Level of Significance after application of Mitigation and SCA
Noise and Vibration (cont.)	<p>sight between the receptor property and the construction site, but would also require a 10-foot long return on each end of the barrier on the construction site, if feasible in a manner that improves the effective noise reduction.</p> <p>(iii) Effectiveness Monitoring. The applicant shall monitor the effectiveness of the implemented temporary noise barrier design by taking noise measurements during each construction phase (excavation, foundations, erection, interior and exterior finishing). Implementation of the temporary noise barrier designs described in #1 are estimated to achieve noise level reduction of approximately 5 dBA from the construction noise levels at the adjacent receptor, where levels are estimated to be as high as 96.5 dBA at the west property line. Up to 5 dBA is considered the maximum feasible noise attenuation that would be achieved with installation of a temporary noise barrier, and some additional level of additional reduction would be achieved with adherence to NOI SCA 2. The applicant shall submit the recorded noise measurements to the Planning and Zoning Division and the Building Services Division.</p>		
Impact NOI-1 (cont.)			<p>NOI SCA 4: Interior Noise; and NOI SCA 5: Operational Noise (General)</p> <p>None required</p> <p>Impact NOI-2: The Project would not increase operational noise levels in the project area to levels in excess of standards established in the Oakland Noise Ordinance and Planning Code (Criterion 3). (Less than Significant)</p>

TABLE 2-1 (Continued)
SUMMARY OF IMPACTS, MITIGATION MEASURES, STANDARD CONDITIONS OF APPROVAL AND RESIDUAL EFFECTS

Environmental Impact	Mitigation Measures and Recommendations	Standard Condition of Approval	Level of Significance after application of Mitigation and SCA
Noise and Vibration (cont.)			
Impact NOI-2 (cont.)	<p>Recommendation NOI-1: Acoustical louvers could be installed in these ventilation openings on the west elevation of the ground-level of the garage to reduce the transmission of garage sounds.</p> <p>Recommendation NOI-2: To reduce the noise levels within the garage and further reduce noise emanating from the garage, the underside of the garage ceiling could be fully lined with spray-on thermal/acoustic insulation, and sound-absorptive material could be applied to the ramp walls.</p> <p>Recommendation NOI-3: Potential tire noise could be reduced by avoiding a polished (squeaky) concrete slab surface.</p> <p>Recommendation NOI-4: Power washing of shopping carts should occur within the enclosed loading dock area, or at the far end of the service deck, away from residential neighbors.</p>		Less than Significant
Impact NOI-3:	The Project would not expose persons to exterior noise levels in conflict with the land use compatibility guidelines of the Oakland General Plan after incorporation of all applicable Standard Conditions of Approval (Criterion 6). (Less than Significant)	None required	NOI SCA 4: Exterior Noise
Impact NOI-4:	The Project would not expose persons to interior Ldn or CNEL greater than 45 dBA for multi-family dwellings, hotels, motels, dormitories and long-term care facilities to noise levels in excess of standards established in the Oakland Noise Ordinance and Planning Code (Criterion 6). (Less than Significant)	None required	Less than Significant
Impact NOI-5:	Traffic generated by Project could substantially increase traffic noise levels in the project area (Criterion 4). (Less than Significant)	None required	Less than Significant

TABLE 2-1 (Continued)
SUMMARY OF IMPACTS, MITIGATION MEASURES, STANDARD CONDITIONS OF APPROVAL AND RESIDUAL EFFECTS

Environmental Impact	Mitigation Measures and Recommendations	Standard Condition of Approval	Level of Significance after application of Mitigation and SCA
Noise and Vibration (cont.)			
Impact NOI-6: Traffic generated by the Project, in combination with traffic from past, present, existing, approved, pending and reasonably foreseeable future projects, could substantially increase traffic noise levels in the project area; and construction and operational noise levels in combination with traffic from past, present, existing, approved, pending and reasonably foreseeable future projects, could increase ambient noise levels (Criterion 4). (Less than Significant)	None required	NOI SCA 1: Days/Hours of Construction Operation; NOI SCA 2: Noise Control and NOI SCA 3: Noise Complaint Procedures; NOI SCA 4: Interior Noise; and NOI SCA 5: Operational Noise (General); NOI SCA 6: Vibration; NOI SCA 7: Pile Driving and Other Extreme Noise Generators.	Less than Significant
Impact NOI-7: Stationary noise sources such as rooftop mechanical equipment in combination with traffic generated by the Project, and from past, present, existing, approved, pending and reasonably foreseeable future projects, could substantially increase noise levels at sensitive land uses in the project area. (Criterion 4). (Less than Significant)	None required	NOI SCA 4: Interior Noise; and NOI SCA 5: Operational Noise (General)	Less than Significant
Population, Housing, and Employment			
Impact POP-1: The Project would not induce substantial population growth in a manner not contemplated in the General Plan, either directly or indirectly. (Criterion 1). (Less than Significant)	None required		Less than Significant
Public Services and Recreation			
Impact PSR-1: The Project could result in an increase in calls for police services, but would not require new or physically altered police facilities in order to maintain acceptable performance objectives. (Criterion 1). (Less than Significant)	None required		Less than Significant
Impact PSR-2: The Project could result in an increase in calls for fire protection and emergency medical response services, but would not require new or physically altered fire protection facilities in order to maintain acceptable performance objectives. (Criterion 1). (Less than Significant)	None required	PSR SCA 2: Fire Safety Phasing Plan	Less than Significant

TABLE 2-4 (Continued)
SUMMARY OF IMPACTS, MITIGATION MEASURES, STANDARD CONDITIONS OF APPROVAL AND RESIDUAL EFFECTS

Environmental Impact	Mitigation Measures and Recommendations	Standard Condition of Approval	Level of Significance after application of Mitigation and SCA
Public Services and Recreation (cont.)	None required		Less than Significant
Impact PSR-3: The Project, in combination with other past, present, existing, approved, pending, and reasonably foreseeable future projects within and around the project site, would not result in a cumulative increase in demand for police, fire, and school services. (Less than Significant)	None required		Less than Significant
Impact PSR-4: The Project could result in new students for local schools, but would not require new or physically altered school facilities to maintain acceptable performance objectives (Criterion 1). (Less than Significant)	None required		Less than Significant
Recreation	Impact REC-1: The Project could increase the use of existing neighborhood or regional parks or other recreational facilities, but not such that substantial physical deterioration of the facility would occur or be accelerated, or cause the need for new or physically altered public facilities, the construction of which could cause significant environmental impacts, in order to maintain acceptable service ratios (Recreation Criterion 1 and Public Services Criterion 1). (Less than Significant)	None required	Less than Significant
Transportation and Circulation	Impact TRANS-1: The Project would increase the V/C ratio for a critical movement by 0.05 or more (Significant Threshold #5) during the weekday PM peak hour at the Piedmont Avenue/Hawthorne Avenue/Brook Street/Broadway intersection.	<p>Mitigation Measure TRANS-1: Implement the following measures at the Piedmont Avenue/Hawthorne Avenue/Brook Street/Broadway intersection:</p> <ul style="list-style-type: none"> • Optimize signal timing (i.e., changing the amount of green time assigned to each lane of traffic approaching the intersection). • Coordinate the signal timing changes at this intersection with the adjacent intersections that are in the same signal coordination group. <p>To implement this measure, the project sponsor shall submit the following to City of Oakland's Transportation Services Division for review and approval:</p>	Less than Significant

TABLE 2-1 (Continued)
SUMMARY OF IMPACTS, MITIGATION MEASURES, STANDARD CONDITIONS OF APPROVAL AND RESIDUAL EFFECTS

Environmental Impact	Mitigation Measures and Recommendations	Standard Condition of Approval	Level of Significance after application of Mitigation and SCA
Transportation and Circulation (cont.)			
Impact TRANS-1 (cont.)	<ul style="list-style-type: none"> • Plans, Specifications, and Estimates (PS&E) to mobility intersection. All elements shall be designed to City standards in effect at the time of construction and all new or upgraded signals should include these enhancements. All other facilities supporting vehicle travel and alternative modes through the intersection should be brought up to both City standards and Americans with Disabilities Act (ADA) standards (according to Federal and State Access Board guidelines) at the time of construction. Current City Standards call for the elements listed below: <ul style="list-style-type: none"> - 2077B: Type Controller with cabinet assembly - GPS communications (clock) - Accessible pedestrian crosswalks according to Federal and State Access Board guidelines with signals (audible and tactile) - Countdown pedestrian head module switch out - City standard ADA wheelchair ramps - Video detection on existing equipment (or new, if required) - Mast arm poles, full actuation (where applicable) - Pedestrian push buttons (full actuation) - Bicycle detection (full actuation) - Pull boxes - Signal interconnect and communication with trenching (where applicable), or through (E) conduit (where applicable)- 600 feet maximum - Conduit replacement contingency - Fiber Switch - PTZ Camera (where applicable) 		

TABLE 2-1 (Continued)
SUMMARY OF IMPACTS, MITIGATION MEASURES, STANDARD CONDITIONS OF APPROVAL AND RESIDUAL EFFECTS

Environmental Impact	Mitigation Measures and Recommendations	Standard Condition of Approval	Level of Significance after application of Mitigation and SCA
Transportation and Circulation (cont.)	<ul style="list-style-type: none"> - Transit Signal Priority (TSP) equipment consistent with other signals along corridor - Signal timing plans for the signals in the coordination group. <p>The project sponsor shall fund the cost of preparing and implementing these plans. However, if the City adopts a transportation fee program prior to implementation of this mitigation measure, the Project Sponsor shall have the option to pay the applicable fee in lieu of implementing this mitigation measure and payment of the fee shall mitigate this impact to less than significant. A straight line interpolation of intersection traffic volume between Existing and 2035 plus project conditions indicates that mitigation at this intersection may be required by 2034. Investigation of the need for this mitigation shall be studied at that time and every three years thereafter until 2035 or until the mitigation measure is implemented, whichever occurs first.</p> <p>After implementation of this measure, the intersection would continue to operate at LOS F during the weekday PM peak hour. However, the mitigation measure would reduce the v/c ratio for the critical movements and mitigate the impact. No secondary impacts would result from implementation of this measure.</p>		
Impact TRANS-1 (cont.)	<ul style="list-style-type: none"> - <p>Mitigation Measure TRANS-2: Implement the following measures at the 27th Street/Broadway intersection:</p> <ul style="list-style-type: none"> - Upgrade traffic signal operations at the intersection to actuated-coordinated operations - Provide protected left-turn phase(s) for the southbound approach. <p>Impact TRANS-2: The Project would increase the total intersection v/c ratio by 0.03 or more and increase the V/C ratio for a critical movement by 0.05 or more during the weekday PM peak hour (Significant Threshold #5) at the 27th Street/Broadway intersection (#10), which would operate at LOS F under 2035 conditions (Significant)</p>		Less than Significant

TABLE 2-1 (Continued)
SUMMARY OF IMPACTS, MITIGATION MEASURES, STANDARD CONDITIONS OF APPROVAL AND RESIDUAL EFFECTS

Environmental Impact	Mitigation Measures and Recommendations	Standard Condition of Approval	Level of Significance after application of Mitigation and SCA
Transportation and Circulation (cont.)	<p>Impact TRANS-2 (cont.)</p> <ul style="list-style-type: none"> • Optimize signal timing (i.e., changing the amount of green time assigned to each lane of traffic approaching the intersection). • Coordinate the signal timing changes at this intersection with the adjacent intersections that are in the same signal coordination group. <p>To implement this measure, the project sponsor shall submit the following to City of Oakland's Transportation Services Division for review and approval:</p> <ul style="list-style-type: none"> • PS&E to modify intersection as detailed in Mitigation Measure TRANS-1. • Signal timing plans for the signals in the coordination group. <p>The project sponsor shall fund the cost of preparing and implementing these plans. However, if the City adopts a transportation fee program prior to implementation of this mitigation measure, the Project Sponsor shall have the option to pay the applicable fee in lieu of implementing this mitigation measure and payment of the fee shall mitigate this impact less than significant. A straight line interpolation of intersection traffic volume between Existing and 2035 Plus Project conditions indicates that mitigation at this intersection may be required by 2033. Investigation of the need for this mitigation shall be studied at that time and in 2035 or until the mitigation measure is implemented, whichever occurs first.</p> <p>After implementation of this measure, the intersection would continue to operate at LOS F during the weekday PM peak hour. However, the mitigation measure would reduce the v/c ratio for the intersection and critical movements and mitigate the impact. No secondary impacts would result from implementation of this measure.</p>		

SUMMARY OF IMPACTS, MITIGATION MEASURES, STANDARD CONDITIONS OF APPROVAL AND RESIDUAL EFFECTS

TABLE 2-1 (Continued)

Environmental Impact	Mitigation Measures and Recommendations	Standard Condition of Approval	Level of Significance after application of Mitigation and SCA
Impact TRANS-3: The Project would increase the V/C ratio for a critical movement by 0.05 or more (Significant Threshold #5) during the weekday PM peak hour and increase the total intersection V/C ratio by 0.03 or more and increase the V/C ratio for a critical movement by 0.05 or more during the Saturday peak hour (Significant Threshold #5) at the 27th Street/Bay Place/Harrison Street intersection (#11), which would operate at LOS F under 2035 conditions. (Significant and Unavoidable)	<p>Mitigation Measure TRANS-3: Implement the following measures at the 27th Street/24th Street/Bay Place/Harrison Street intersection:</p> <ul style="list-style-type: none"> • Reconfigure the 24th Street approach at the intersection to restrict access to 24th Street to right turns only from 27th Street and create a pedestrian plaza at the intersection approach. • Convert 24th Street between Valdez and Harrison Streets to two-way circulation and allow right turns from 24th Street to southbound Harrison Street south of the intersection, which would require acquisition of private property in the southwest corner of the intersection. • Modify eastbound 27th Street approach from the current configuration (one right-turn lane, two through lanes, and one left-turn lane) to provide one right-turn lane, one through lane, and two left-turn lanes. • Realign pedestrian crosswalks to shorten pedestrian crossing distances. • Reduce signal cycle length from 160 to 120 seconds, and optimize signal timing (i.e., changing the amount of green time assigned to each lane of traffic approaching the intersection). • Coordinate the signal timing changes at this intersection with the adjacent intersections that are in the same signal coordination group. <p>To implement this measure, the project sponsor shall submit the following to City of Oakland's Transportation Services Division for review and approval:</p> <ul style="list-style-type: none"> • PS&E to modify intersection as detailed in Mitigation Measure TRANS-1. • Signal timing plans for the signals in the coordination group. 		

TABLE 2-1 (Continued)
SUMMARY OF IMPACTS, MITIGATION MEASURES, STANDARD CONDITIONS OF APPROVAL AND RESIDUAL EFFECTS

Environmental Impact	Mitigation Measures and Recommendations	Standard Condition of Approval	Level of Significance after application of Mitigation and SCA
Transportation and Circulation (cont.)	The project sponsor shall fund the cost of preparing and implementing these plans. However, if the City adopts a transportation fee program prior to implementation of this mitigation measure, the Project Sponsor shall have the option to pay the applicable fee in lieu of implementing this mitigation measure and payment of the fee shall be considered the equivalent of implementing the mitigation measure, which would still result in significant unavoidable impacts. A straight line interpolation of intersection traffic volume between Existing and 2035 Plus Project conditions indicates that mitigation at this intersection may be required by 2033. Investigation of the need for this mitigation shall be studied at that time and in 2035 or until the mitigation measure is implemented, whichever occurs first.		
Impact TRANS-3 (cont.)	<p>The project sponsor shall fund the cost of preparing and implementing these plans. However, if the City adopts a transportation fee program prior to implementation of this mitigation measure, the Project Sponsor shall have the option to pay the applicable fee in lieu of implementing this mitigation measure and payment of the fee shall be considered the equivalent of implementing the mitigation measure, which would still result in significant unavoidable impacts. A straight line interpolation of intersection traffic volume between Existing and 2035 Plus Project conditions indicates that mitigation at this intersection may be required by 2033. Investigation of the need for this mitigation shall be studied at that time and in 2035 or until the mitigation measure is implemented, whichever occurs first.</p> <p>After implementation of this measure, the intersection would continue to operate at LOS F during the weekday PM peak hour and improve to LOS D during the Saturday peak hour. Although the mitigation measure would reduce the total intersection V/C ratio during the weekday PM peak hour, it would not reduce the V/C ratio for critical movements to 0.05 or less. Therefore, the impact would remain significant and unavoidable.</p> <p>No other feasible mitigation measures are available that would mitigate the project impacts at the 27th Street/24th Street/Bay Place/Harrison Street intersection. Traffic operations at the intersection can be further improved by providing additional automobile travel lanes, such as a third lane on northbound or southbound Harrison Street, or a second through lane on eastbound 27th Street. However, these modifications cannot be accommodated within the existing automobile right-of-way and would require additional right-of-way, and/or loss of existing bicycle lanes,</p>		

TABLE 2-1 (Continued)
SUMMARY OF IMPACTS, MITIGATION MEASURES, STANDARD CONDITIONS OF APPROVAL AND RESIDUAL EFFECTS

Environmental Impact	Mitigation Measures and Recommendations	Standard Condition of Approval	Level of Significance after application of Mitigation and SCA
Impact TRANS-3 (cont.)	<p>medians and/or on-street parking, and are considered to be infeasible. Therefore, the impact is considered significant and unavoidable.</p> <p>This mitigation measure would also reduce pedestrian delays at the intersection and improve pedestrian safety by realigning the crosswalks at the intersection and reducing pedestrian crossing distances. No other secondary impacts would result from implementation of this measure.</p> <p>Mitigation Measure TRANS-4: Implement the following measures at the Grand Avenue/Broadway intersection:</p> <ul style="list-style-type: none"> • Provide permitted protected left-turn phasing for the northbound approach. • Optimize signal timing (i.e., changing the amount of green time assigned to each lane of traffic approaching the intersection). • Coordinate the signal timing changes at this intersection with the adjacent intersections that are in the same signal coordination group. <p>To implement this measure, the project sponsor shall submit the following to City of Oakland's Transportation Services Division for review and approval:</p> <ul style="list-style-type: none"> • PSEA to modify intersection as detailed in Mitigation Measure TRANS-1. • Signal timing plans for the signals in the coordination group. • The project sponsor shall fund the cost of preparing and implementing these plans. However, if the City adopts a transportation fee program prior to implementation of this mitigation measure, the Project Sponsor shall have the option to pay the applicable fee in lieu of implementing this mitigation measure and payment of the fee shall mitigate this impact to less than significant. <p>A straight line interpolation of intersection traffic volume</p>	<p>Demand Management; and TRANS SCA 2: Construction Traffic and Parking</p>	Less than Significant

SUMMARY OF IMPACTS, MITIGATION MEASURES, STANDARD CONDITIONS OF APPROVAL AND RESIDUAL EFFECTS

Environmental Impact	Mitigation Measures and Recommendations	Standard Condition of Approval	Level of Significance after application of Mitigation and SCA
Transportation and Circulation (cont.) Impact TRANS-4 (cont.)	<p>between Existing and 2035 Plus Project conditions indicates that mitigation at this intersection may be required by 2034. Investigation of the need for this mitigation shall be studied at that time and in 2035 or until the mitigation measure is implemented, whichever occurs first.</p> <p>After implementation of this measure, the intersection would continue to operate at LOS F during the weekday PM peak hour. However, the mitigation measure would reduce the v/c ratio for the intersection and critical movements and mitigate the impact. No secondary impacts would result from implementation of this measure.</p> <p>Recommendation TRANS-5: Implement the following measures:</p> <ul style="list-style-type: none"> • Provide the following at the signalized 30th Street/Broadway intersection: <ul style="list-style-type: none"> - Pedestrian signal heads with count-down signals at the four crosswalks at the intersection; however, if the existing signal equipment cannot accommodate new pedestrian signal heads, replace the existing signal equipment necessary to include these facilities; - Directional curb ramps at all four corners of the intersection aligning with the crosswalks, avoiding, or relocating if necessary, the existing signal poles. - Consider providing Leading Pedestrian Intervals for the pedestrian crossings at this intersection. - Coordinate these improvements at 30th Street/Broadway intersection with AC Transit and Recommendation TRANS-8. • Provide the following at the unsignalized midblock crossing on Broadway just north of the project site: 		

TABLE 2-1 (Continued)
SUMMARY OF IMPACTS, MITIGATION MEASURES, STANDARD CONDITIONS OF APPROVAL AND RESIDUAL EFFECTS

Environmental Impact	Mitigation Measures and Recommendations	Standard Condition of Approval	Level of Significance after application of Mitigation and SCA
Transportation and Circulation (cont.)	<ul style="list-style-type: none"> - Bulbouts on both sides of the crossing - Rectangular Rapid Flash Beacons (RRFB) for both directions of Broadway <p>Recommendation TRANS-6: Coordinates with AC Transit to implement the following, which are consistent with the draft improvements for Route 51 TPI:</p> <ul style="list-style-type: none"> • Move the southbound Route 51A bus stop from just north of 30th Street to just south of 30th Street, and provide a bulbout at the bus stop and amenities such as a shelter and bench. • Move the northbound Route 51A bus stop from just north of 29th Street to just north of 30th Street, extend the existing bulbout to accommodate buses, and provide amenities such as a shelter and bench. 	<p>Recommendation TRANS-7: Although not required to address an adverse environmental impact, the following should be considered in regards to bicycle parking:</p> <ul style="list-style-type: none"> • Ensure that short-term and long-term bicycle parking spaces are consistent with City of Oakland Bicycle Parking Rack Guidelines. • Ensure the short-term bicycle parking on sidewalks do not block pedestrian circulation. • Ensure that some short-term bicycle parking spaces can accommodate bicycles with trailers. • Monitor the usage of long-term and short-term bicycle parking spaces, and if necessary provide additional parking spaces. 	
Impact TRANS-4 (cont.)			

TABLE 2-1 (Continued)
SUMMARY OF IMPACTS, MITIGATION MEASURES, STANDARD CONDITIONS OF APPROVAL AND RESIDUAL EFFECTS

Environmental Impact	Mitigation Measures and Recommendations	Standard Condition of Approval	Level of Significance after application of Mitigation and SCA
Transportation and Circulation (cont.)	<p>Impact TRANS-4 (cont.)</p> <p>Recommendation TRANS-8: Although not required to address an adverse environmental impact, the following strategies, to further implement SCA 25, should be considered to reduce project parking demand and better manage the available parking supply:</p> <ul style="list-style-type: none"> • Limit parking on the ground level to ADA accessible spaces and short-term (20 minutes or less) parking. • Limit most parking spaces on the roof-level to two hours or less so that they are available to project visitors and not used for commuter parking. • Encourage employees to park on the roof-level furthest away from the elevators and in the compact parking spaces. • Provide signage informing motorists in the ground level parking that additional parking is available on the roof-top. • Install parking meters at all on-street parking spaces along the project frontage on Broadway and 30th Street and limit parking to one-hour or less. 	<p>Recommendation TRANS-8: Implement the following measures to minimize queues on the eastbound 30th Street approach at the 30th Street/Broadway intersection:</p> <ul style="list-style-type: none"> • Adjust signal timing parameters at the intersection to provide more green time for the eastwest movements. • Consider providing a right-turn lane on eastbound 30th Street at Broadway. This may require elimination of one or more on-street parking spaces on 30th Street. 	
			2-25

SUMMARY OF IMPACTS, MITIGATION MEASURES, STANDARD CONDITIONS OF APPROVAL AND RESIDUAL EFFECTS

Environmental Impact	Mitigation Measures and Recommendations	Standard Condition of Approval	Level of Significance after application of Mitigation and SCA
Utilities and Service Systems			
Impact UTIL-1: The water demand generated by the Project would not exceed water supplies available from existing entitlements and resources (Criterion 3). (Less than Significant)	None required		Less than Significant
Impact UTIL-2: The Project would not exceed the wastewater treatment requirements of the San Francisco Regional Water Quality Control Board or result in a determination that new or expanded wastewater treatment facilities would be required (Criteria 1 and 4). (Less than Significant)	None required		Less than Significant
Impact UTIL-3: The Project would not require or result in construction of new stormwater drainage facilities or expansion of existing facilities, the construction of which could cause significant environmental effects. (Criteria 2). (Less than Significant)	None required	UTIL SCA 2: Stormwater and Sewer	Less than Significant
Impact UTIL-4: The Project would not violate applicable federal, state, and local statutes and regulations related to solid waste, nor generate solid waste that would exceed the permitted capacity of the landfills serving the area (Criteria 5 and 6). (Less than Significant)	None required	UTIL SCA 1: Waste Reduction and Recycling	Less than Significant
Impact UTIL-5: The Project would not violate applicable federal, state and local statutes and regulations relating to energy standards, nor result in a determination by the energy provider which serves or may serve the area that it does not have adequate capacity to serve projected demand in addition to the providers' existing commitments and require or result in construction of new energy facilities or expansion of existing facilities (Criteria 7 and 8). (Less than Significant)	None required	UTIL SCA 3: Compliance with the Green Building Ordinance, and UTIL SCA 4: Compliance with the Green Building Ordinance for Building and Landscape Projects	Less than Significant
Impact UTIL-6: The Project in combination with other past, present, existing, approved, pending, and reasonably foreseeable future projects within and around the Project would result in an increased demand for utilities services. (Less than Significant)	None required	UTIL SCA 1: Waste Reduction and Recycling, UTIL SCA 2: Stormwater and Sewer, HYD SCA 1: Stormwater Pollution Prevention Plan; and HYD SCA 2: Post-construction Stormwater Management Plan	Less than Significant



CITY OF OAKLAND

Department of Planning and Building
Planning and Zoning Division
250 Frank H. Ogawa Plaza, Suite 3315, Oakland, California, 94612-2032

COMBINED NOTICE OF RELEASE AND AVAILABILITY OF THE DRAFT ENVIRONMENTAL IMPACT REPORT AND NOTICE OF PUBLIC HEARING ON THE DRAFT ENVIRONMENTAL IMPACT REPORT FOR THE SHOPS AT BROADWAY RETAIL PROJECT

PROJECT TITLE: The Shops at Broadway Retail Project.

PROJECT SPONSOR: Portfolio Development Partners LLC.

CASE NOS.: CMDV13-194; TPM10164; ER12-0007

PROJECT LOCATION: 3001-3039 Broadway, Oakland, California; northwest corner of Broadway and 30th Street. APNs 009-0705-004-00; 009-0705-005-00; 009-0705-006-00; and 009-0705-007-00.

SUMMARY OF THE PROJECT: The Project involves the development of a new, one-story development with 36,000 square feet of high volume retail space and associated parking. Specifically, the proposed development would include a 26,000 square-foot retail anchor tenant, Sprouts Farmers Market, and an additional 10,000 square-feet currently planned to accommodate three retail tenant spaces. All retail areas would be oriented along Broadway and would be primarily accessed through a public plaza connected to the sidewalk along Broadway. Public-realm amenities proposed include landscaping, a public gathering area with café style seating for customers, as well as a plaza and garden seating for customers on the rooftop level. A total of 162 parking spaces would be provided on the ground level (18 spaces behind the retail tenant spaces), and on a rooftop parking deck accessed from an internal ramp (144 spaces). All vehicular access to the project site would be from a driveway on 30th Street, and service vehicles/trucks would exit the site and internal loading dock area via a driveway on Broadway. The project site is not listed on the Cortese List of hazardous materials sites.

ENVIRONMENTAL REVIEW: A Draft Environmental Impact Report (DEIR) has been prepared for the Project under the requirements of the California Environmental Quality Act (CEQA) pursuant Public Resources Code Section 21000 *et. seq.* The DEIR analyzes potentially significant environmental impacts in the following environmental categories: Aesthetics; Agricultural and Forestry Resources; Air Quality; Biological Resources; Cultural Resources; Geology, Soils and Geohazards; Greenhouse Gases and Climate Change; Hazards and Hazardous Materials; Hydrology and Water Quality; Land Use, Plans and Policies; Mineral Resources; Noise; Population, Housing and Employment; Public Services; Recreation; Transportation, Circulation and Parking; and Utilities and Service Systems. The DEIR identifies a significant unavoidable environmental impact related to Transportation, Circulation and Parking. Copies of the DEIR are available for review or distribution to interested parties at no charge at the Department of Planning and Building, Planning and Zoning Division, 250 Frank H. Ogawa Plaza, 2nd Floor Zoning Counter, Oakland, CA, 94612, Monday through Friday, 8:00 a.m. to 4:00 p.m. (Wednesday 9:30 a.m. to 4:00 p.m.). The DEIR may also be reviewed at the following website: <http://www2.oaklandnet.com/Government/o/PBN/OurServices/Application/DOWD009157>.

PUBLIC HEARING:

The City Planning Commission will conduct a public hearing on the DEIR on
September 11, 2013, at 6:00 p.m. in the City Council Chambers,
City Hall, 1 Frank H. Ogawa Plaza, Oakland, CA.

ATTACHMENT C

The City of Oakland is hereby releasing the DEIR, finding it to be accurate and complete and ready for public review. Members of the public are invited to comment on the DEIR and the project. There is no fee for commenting, and all comments received will be considered by the City prior to finalizing the EIR and making a decision on the project. Comments on the DEIR should focus on the sufficiency of the EIR in discussing possible impacts on the physical environment, ways in which potential adverse effects might be minimized, and alternatives to the project in light of the EIR's purpose to provide useful and accurate information about such factors. Comments may be made at the public hearing described above or in writing. Please address all written comments to Peterson Vollmann, Planner III, City of Oakland, Department of Planning and Building, Planning and Zoning Division, 250 Frank H. Ogawa Plaza, Suite 2214, Oakland, CA, 94612; (510) 238-4730 fax or e-mailed to pfullmann@oaklandnet.com. Comments should be received no later than 4:00 p.m. on **September 30, 2013**. Please reference case number **ER12-0007** in all correspondence. If you challenge the environmental document or project in court, you may be limited to raising only those issues raised at the Planning Commission public hearing described above, or in written correspondence received by the Department of Planning and Building on or prior to 4:00 p.m. on **September 30, 2013**.

After all comments are received, a Final EIR will be prepared and the Planning Commission will consider certification of the Final EIR and render a decision on the project at a later meeting date to be scheduled. For further information, please contact Peterson Vollmann, Planner III, at (510) 238-6167 or pfullmann@oaklandnet.com.



SCOTT MILLER
Zoning Manager
Environmental Review Officer

August 16, 2013

TABLE 5-1
SUMMARY OF ALTERNATIVES TO THE PROJECT

NOTE: A summary narrative of each of alternative follows this table.	Project	Reduced Project + Residential			
		1A: Mixed Use 150 (150 Units + Grocery/ Local Retail) ^a	1B: Mixed Use 225 (225 Units + Grocery/ Local Retail) ^a	2: Mixed Use 225 No Grocery (225 Units + Local Retail)	3: Office/Retail (Office + Local Retail)
Grocery Store	26,010	-	28,000	26,000	20,000
Local Serving Retail	10,000	-	6,500	9,400	10,000
Office	-	-	-	-	100,000
Residential Units		150	225	225	
Studios	-	-	-	54 (24%)	-
1 BedRooms	-	-	100 (67%)	114 (51%)	-
2 BedRooms	-	-	45 (30%)	57 (25%)	-
3 BedRooms	-	-	5 (3%)	-	-
Parking Spaces	158	279	328	223	201
Retail	158	157	173	68 b	34 b
Residential	-	122	155	155	-
Office	-	-	-	-	167 c
General	-	287	-	-	-
Maximum Building Height	40 feet / 2 levels	0	75 feet / 6 levels	75 feet / 6 levels	65 feet / 5 levels
Driveways / Ramps					40 feet / 2 levels
30th Street	1 driveway / 2 ramps	2 driveways	2 driveways / 2 ramps	2 driveways / 2 ramps	1 driveway / 2 ramps
Broadway	1 driveway (trucks only)	7 driveways	1 driveway (trucks + residents)	1 driveway (trucks only)	1 driveway (trucks only)
Ramps	West Elevation	West Elev. + Internal	West Elev. + Internal	West Elev. + Internal	West Elevation
West Setbacks					
Ground Level	24 feet / 10 feet	-	10 feet	10 feet	10 feet
Upper Level(s)	10 feet	-	25 feet / 10 feet	10 feet	25 feet / 10 feet
Other Basic Characteristics					Each alternative will incorporate, as appropriate to its scale and use, all other basic characteristics of the Project, including biofiltrated landscaped areas, sustainability and green building elements, rooftop landscaping, public realm improvements, signage, and lighting.

^a Lowney Architecture, 2013.^b Same as proposed Project assumptions and ratios. ^c Based on Oakland Municipal Code Section 17.116.080

TABLE 5-2
SUMMARY OF QUANTIFIED CHARACTERISTICS OF THE ALTERNATIVES

		Reduced Project + Residential				
Project		1A: Mixed Use 150 (150 Units + Grocery/ Local Retail) ^a	1B: Mixed Use 225 (225 Units + Grocery/ Local Retail) ^a	2: Mixed Use 225/ No Grocery (225 Units + Local Retail)	3: Office/Retail (Office + Local Retail)	4: Fully Mitigated / Grocery Only
Vehicle Trips						
Daily Vehicle Trips	3,385	3,898	4,546	2,322	1,650	2,268
Peak Hour Vehicle Trips (AM/PM/Saturday)	130 / 239 / 308	161 / 274 / 326	220 / 348 / 399	142 / 211 / 231	165 / 195 / 197	68 / 44 / 157
GHG Emissions						
Total Emissions (CO ₂ e)	1,510	2,616	3,190	2,505	1,708	1,067
GHG Emissions by Service Population (CO ₂ e)	19.9	7.6	6.7	5.6	4.9	24.8
Air Quality						
ROG / NO _x / PM _{2.5} (pounds/day)	9.6 / 17.8 / 0.7	17.5 / 27 / 2.4	22.2 / 33 / 1.4	16 / 21 / 1.3	9.2 / 15.4 / 0.8	6.48 / 12.25 / 0.5
PM ₁₀ (pounds/day)	6.9	13.1	16.5	11.6	8.6	4.98
Service Population	76	342	479	444	350	43
Employees	76	73	75	40	20	43
Residents	-	269	404	404	330	-

Bold and underlined indicates value is less than would occur with the Project.

^a Lowney Architecture, 2013.

SOURCE: Detailed tables for each of the data in this table are provided in Appendix H, *Alternatives Technical Detail*, to this Draft EIR.

would occur if the project were approved. With the No Project Alternative, the Project would not occur; the project site would continue to operate as a fully paved parking lot in its existing condition. Existing conditions reflecting the No Project Alternative are described in Section 3.1, *Project Location and Site Characteristics*, and shown in Figures 4.1-2 (photo #2) and 4.1-3 (photo #4), in Chapter 3 to this EIR.

No Project Alternative Impacts Compared to the Project's

None of the impacts identified with the Project would occur since no new development or its associated traffic, air quality and noise (including those associated with the Project traffic), greenhouse gas (GHG) emissions, new structures, utility and service demands, or construction activity would occur. In particular, the No Project Alternative would avoid the conservatively significant and unavoidable impact to greenhouse gas emissions (Impact GHG-1) and the significant and unavoidable impact to traffic (Impact TRANS-3).