

BUILDING DESIGN

Building Design 1 / Massing: New buildings should be designed with major massing elements that are consistent with those found in existing desirable buildings located in the immediate vicinity.

The project contains two mid-rise and one high-rise buildings that range from 7-story to 23-story. As discussed in this staff report, the proposed buildings provide minimal massing relief on the facades and roof to create a cohesive composition. The proposal needs to consider using different design components to create volumes and articulation to create balance and style.

Response: Massing Changes have been introduced to the facades to provide corner articulation, Massing relief and volume articulation. See updated elevations and perspectives.

Building Design 2 / Fenestration and Materials.' Fenestration elements, such as windows, doors, lowers, vents, wall panels, skylights, storefronts, curtain walls, and other glazed systems, can be either more historic or more contemporary depending on the context, and should be articulated to maintain the sense of scale found in the immediate context.

The project provides a cohesive arrangement of various size of windows, wall panels and glazing storefronts that are contemporary and help to reduce the visual scale of the large building frontage.

Response: New design changes have provided more articulation

WEST OAKLAND SPECIFIC DESIGN GUIDELINES TO THE 7TH STREET OPPORTUNITY AREAS

The following section of the Design Guidelines addresses the urban design strategies and guidelines that are particular to the 7th Street Opportunity Areas, especially as to neighborhood commercial corridors with



housing. The 7th Street guidelines intend that the project become the focus of the surrounding neighborhoods with active street edges that would encourage neighbors and visitors to experience a high-quality urban streetscape.

NEIGHBORHOOD COMMERCIAL

Neighborhood Commercial 1/ Site Planning: Buildings should be built immediately fronting 7th Street to emphasize and re-establish where necessary the continuity of the neighborhood commercial street. Ground floors should have active publically accessible uses such as restaurants, retail, lobbies and galleries. Driveways and vehicular entrances are discouraged from accessing directly from 7th Street and moved to side streets where feasible.

The proposal contains three detached mixed-use buildings that front 7" Street to create continuity in the S-15 Transit-Oriented Development Commercial zone. The project includes ground floor retail and residential lobbies that would be accessible from 7" Street and thus create a more active environment on the main corridor. The proposal also includes two separate driveways for partial vehicular access to the "community gathering" pedestrian pathways, which is opposite to the prescribed 7" Street guidelines.

Response: NA

Neighborhood Commercial 2 / Massing. Residential upper stories are encouraged to include bay windows above the ground floor to provide light and air, and to break up the scale of buildings and convey residential use.

The project development contains buildings that range from 7-story to 23-story, but do not contain any bay windows to the residences or provide articulation to create visual relief to the building mass.

Response: Balconies and bays have been added along all major street facades to provide articulation. See revised elevations and perspectives



Neighborhood Commercial 3 / Height: Except when located at important intersections such as Mandela Parkway and 7th Street, buildings over 5 stories in height should generally include a significant step- back along commercial arterial roadways to harmonize the scale of new buildings with the existing neighborhood.

The project proposal is not located at the intersection of 7t Street and Mandela Parkway. The project includes buildings that are more than five stories in height and do not provide a significant step-back from the main commercial corridor, 7" Street, to create a balanced scale with other buildings in the area.

Response: Building articulation along 7thhas been added to respond to height of the residential building across street.

Neighborhood Commercial 4 / Fenestration. Ground floors should have as many openings as possible with as few blank wall sections as possible. Awnings and canopies are encouraged.

The proposal provides a decent amount of openings and glazing along the ground floor on 7" Street. The project development, however, can use additional awnings or canopies to define and make the main entries more prominent from the commercial corridor.

Response: Double height lobby spaces are aligned with courtyards beyond to provide layering of space at ground level. Awnings have been added to define entries.

Neighborhood Commercial 5 / Materials: Buildings should have a variety of high quality materials that Define an interesting character when viewed up close and from a distance.

The proposal provides a modest mix of materials and colors that range from light to medium color metal cladding, cement panels, powder coated storefront and aluminum window framing, gray glazing, accent colors and perforated metal balcony railings.

Response: The material pallet has been updated to create more variation.



Neighborhood Commercial 6 / Renovation of Older Buildings: Older commercial buildings should be restored in a manner consistent with their original architectural style.

The project proposal does not plan to restore the existing one-story commercial building because it will be demolished as part of the new development. The property is not considered a historic property or in a historic district.

Response: NA

Neighborhood Commercial 7 / Landscape: Street trees should be of a type that allows high visibility to storefronts and spaced to allow street lights to penetrate to sidewalks during nighttime.

The proposal includes a landscaping plan that shows the installation of a mix of street trees around the property. The species of the street trees range from 36-inch box size Quercus Suber, Pistacia Chinensis and Gingko Biloba trees. The plan also shows that these trees are spaced between an average of 20 to 40 feet on center. The majority of the street trees will be planted on a landscaped strip, except for the trees on 7th Street which will be contained in a well surrounded by metal grates.

Response: NA

Neighborhood Commercial 8 / Landscape: Publicly accessible outdoor space areas should be comprehensively designed with high quality pavement, landscaping, and seating, and are encouraged at the following locations: Mandela and 7th Street, San Pablo Avenue and West Grand Avenue, San Pablo and 32nd Street.

The project proposal is not located on any of these street intersections, so it does not apply. However, the project includes "community gathering spaces", located between the mid-rise and high-rise buildings. These pedestrian pathways are designed to provide direct access from 7" and 5" Streets to the ground floor commercial flex spaces. These two pedestrian pathways provide some type of open space that include furniture and landscaping such as pergolas, benches, planting areas and color paving surfaces to create an inviting environment to the public and residents as well. It should be noted that the community gathering spaces are unarticulated and the buildings on either side are not stepped back. These areas risk being dark, cold, and unanimated without a high-quality, detailed design.



Response: The public gathering spaces are landscaped with a mix of hardscapes to provide articulation across the floor surface. As noted, planting and furnishings are added to enhance the space. The pedestrian pathways face North / South and will get plenty of direct mid-day sun as well as morning and noon reflected light off buildings fronting the spaces.

High quality materials in storefronts and facades have been further articulated.

DESIGN ISSUES

Based on design plans provided, staff has reviewed the project and has the following comments for consideration by the Planning Commission:

Site Planning
Public Right-of-Way:

The proposed design plans, received on February 10, 2018 provide minimal information as to the extent of any right-of-way improvements around the subject property. Other than proposing new or improved curbcuts for ADA access ramps and extension of the existing median strips around the project site, staff believes that additional detail plans are needed to better evaluate the project and provide recommendations. Typically, such information is provided when a Subdivision Map and/or a Planned Unit Development plan is provided. The submission of a subdivision map to merge and subdivide the property into three new parcels has not been submitted to provide additional information that can help assess the off-site improvements as it relates to the proposed project.

Response: Project team had meeting with public works to discuss site improvements and have incorporated additional crosswalk and road diets into plans.

Parcelization:

The applicant has indicated that the existing three parcels will be reconfigured and merged into three new parcels through a subdivision map. The three new proposed parcels would allow each of the proposed detached buildings to be developed in two phases. Phase 1 will include the construction of the two mid-rises



and Phase 2 will include the construction of the high-rise. Without the required subdivision map, it is not clear at this time where would the property lines be located in relation to the proposed "community gathering space (pedestrian pathways) and building separation. If the map shows a proposed property line in the center of the pedestrian pathways, it may or may not conform to the zoning development standards such as building setbacks or will it conflict with any proposed utility easements. The subdivision map is critical to analyzing the project and determining appropriate permits and procedures.

Response: Drat TPM is prepared, see attachment A in set.

Building Design
Building Height and Mass:

The proposal provides three detached buildings, two mid-rises and one high-rise. The two mid- rise buildings measure up to 84 feet in height and the high-rise measures up to 233 feet in height to the rooftop. The maximum allowed building height in the S-15W zoning district is 160 feet. Because the application includes a Density Bonus, the project sponsor is entitled to request for concessions or incentives. So, in this case the applicant proposes a building height increase of 233 feet (+73 feet). Staff believes that this transit-oriented development site could accommodate the proposed density. However, staff has some concerns about the massing of the buildings. The West Oakland Specific Plan Design Guidelines implies for continuity with the West Oakland's unique history and character. The intent of the guidelines is for new buildings to be designed with major massing elements that are consistent with buildings in the immediate vicinity. The current massing of the buildings is bulky and monolithic, and needs to be finessed to create different volumes and articulation. The proposal can use a strong variation of roof and facade planes to provide an attractive appearance when viewed from the street and from distant views from around the city. Staff comments also apply to the two mid-rise buildings that further development is recommended to break up mass on the facade and roof planes. The height of these two buildings are not of a concern, but how the massing can be improved to provide visual relief and interest within the context of the neighborhood is of concern.

Response: The project design has been modified to place a distinctive tower element at both the 7th and Union, and 7th and Kirkham intersections. In the case of 7th and Union, the high-rise tower features changes in massing and materiality that imply a slender, articulated tower at the northeast corner of the property. At the apex of the tower, a wind/mechanical screen gestures towards the downtown core,



helping to differentiate the mass of this wing of the tower, without adding program. This wing of the high-rise will also be clad in glass and metal, and distinctly different from the south wing, which comprises punched openings in a more solid expression.

The updated design also features a series of retail spaces along Union that successively step back from the street to create protected entry/seating nooks along this very busy frontage. These articulated retail boxes utilize the language of the tower to distinguish them from the adjoining retail/live work spaces that address the BART right-of-way. At the street level at 7th and Union, an entry canopy frames the corner of the building, setting it apart from the balance of the retail frontage, and further emphasizing the prominence of this important corner.

Land-Uses
Off-street Parking:

The project proposes a total of 8 parking spaces for commercial use on a small surface parking lot, located near the intersection of 5" and Kirkham Streets. Per the S-15W zone district, the required number of parking spaces for the proposed application is 516 spaces (0.5 parking space per residential unit). Zoning regulations also allow additional parking reduction of 30%, when a project development site is located in a Transit Accessible Area such as BART. So, the result for the base parking count for required off-street residential parking is 361 spaces within the property. Furthermore, per the Density Bonus regulations, the applicant can request incentives or concessions to reduce the required number of off-street parking. In this case, the applicant is proposing to reduce residential parking to zero and instead proposes 8 parking spaces primarily for commercial or retail uses in a small surface parking lot. Staff believes that the proposal for not providing off-street parking for the residential units and/or parking for residential and commercial loading berths may be of a concern in the surrounding neighborhood.

CONCLUSION

The proposed project reflects to some degree the intent of the 5-15 W zoning district and vision of the West Oakland Specific Plans (WOSP) for developing multi-story, high-density mixed-use development in Transit-Oriented Development Commercial Zones. There are issues, however that staff believes are significant and need to be addressed to improve the' overall design appearance of the buildings. Staff has concerns



regarding the lack of building wall and roof planes particularly along 7th Street. Although the buildings integrate horizontal and vertical design features, the buildings appear bulky and massive in appearance. To provide visual relief on the building mass it is recommended that further development is made to improve articulation and design interest of the building facades. At a minimum, staff recommends the applicant consider and incorporate on a revised design plan the following:

• Provide roof plane variety to be less monotonous to create a balance proportion and articulation. The high-rise roof plane needs further development to reduce the heavy top. The building roof can also use a prominent design feature to provide interest. The low-rise building also need roof plane articulation to reduce bulk. It is suggested that the low-rise building at 7" and Kirkham Streets include a design feature such as a marquee to make the entry more prominent.

Response: Articulation added to roof line and façade to respect scale of neighborhood.

Submit conceptual design plans for future commercial signage for retail and flex spaces.

Response: Signage intent added to the renderings, see updated images for reference.

Include details for the courtyard 34-foot tall wall metal panel, and building windows.

Response: Sheet added showing details for sound wall at courtyards.

Integrate sun shades or trellises and aesthetic features on the roof deck and upper terraces.

Response: Sculptural canopy added to upper roof terrace.

Consider removal of new curb cuts /driveways on 7" Street for the community gathering areas.

Response: These are meant to be rolled edges and not curb cuts. We have discussed with public works and traffic.



Provide additional information (program) for the operation of the pop-up retail activities.

Response: Owner has hired SiteLab to develop retail program. See information added to packet regarding retail program.

Include laundry areas for the residential tenants of Building 3/ high-rise.

Response: Laundry area included at ground level

Provide decorative lamps in the public open spaces, community gathering spaces and courtyards.

Response: Lamps and string lights have been added to open space, community gathering spaces and courtyards.

Screen from view all utility equipment from public view and from building rooftop.

Response: equipment will be screened from view

Submit details for the solar system located on the rooftop.

Response: solar system is shown for intent. Actual system will need to be calculated and designed by engineers prior to permitting.

Review with City Public Works/Traffic the feasibility for all street parking around the site.

Design Review Committee


Case File Number: PLN17428 / PUDF07 February 28, 2018

Project Location: Assessor's Parcel Numbers:	500 Kirkham Street. The property is bounded by 7th Street, Union Street and 5th Street and is located near the West Oakland BART Station. 004 004900100, 004 004900301 & 004005101802
Proposal:	To construct two detached eight and nine-story buildings and one detached 23-story building consisting of 1,032 residential units with ground-floor retail and flex space commercial areas, surface parking lot for eight parking spaces, courtyards, roof deck, terraces, pedestrian commercial pathways including an amenity and outdoor pop-up retail space.
Project Applicant/ Telephone:	Zac Shore, Panoramic Interests / (415) 701-7002
Property Owner:	500 Kirkham, LLC
Case File Number:	PLN17428/ PUDF07
Planning Permits Required:	Conditional Use Permits for Planned Unit Development (PUD); Regular Design Review for new construction; and Tentative Parcel Map Subdivision to subdivide three new parcels.
General Plan: Specific Plan:	Community Commercial West Oakland Specific Plan (WOSP)
Zoning:	S-15W Transit-Oriented Development Zone
Environmental Determination:	Under Review
Property Historic Status:	Non-Historic Property
City Council District:	3
Project Status:	Referral for Review by the Design Review Committee
Action to be Taken:	Provide comments to applicant and staff
For Further Information:	Contact Case Planner, Mike Rivera at (510) 238-6417, or by email at mrivera@oaklandnet.com

SUMMARY

The applicant proposes to construct a mixed-use project consisting of residential and commercial uses on a 3.15 acres property. The project site has no buildings, except for a vacant one-story commercial building that would be demolished. The project also includes the construction of a surface parking lot with eight parking stalls, large private courtyards and (community gathering spaces) pedestrian pathways including other accessory outdoor areas to be under the control and maintenance of the property owner. The proposal includes a total of 1,032 market rate and affordable residential units. The project is undergoing an environmental analysis, and the proposal will require a decision by the Planning Commission at a future public meeting. Staff is seeking comments and direction from the Design Review Committee, based on the submitted design plans.

CITY OF OAKLAND PLANNING COMMISSION

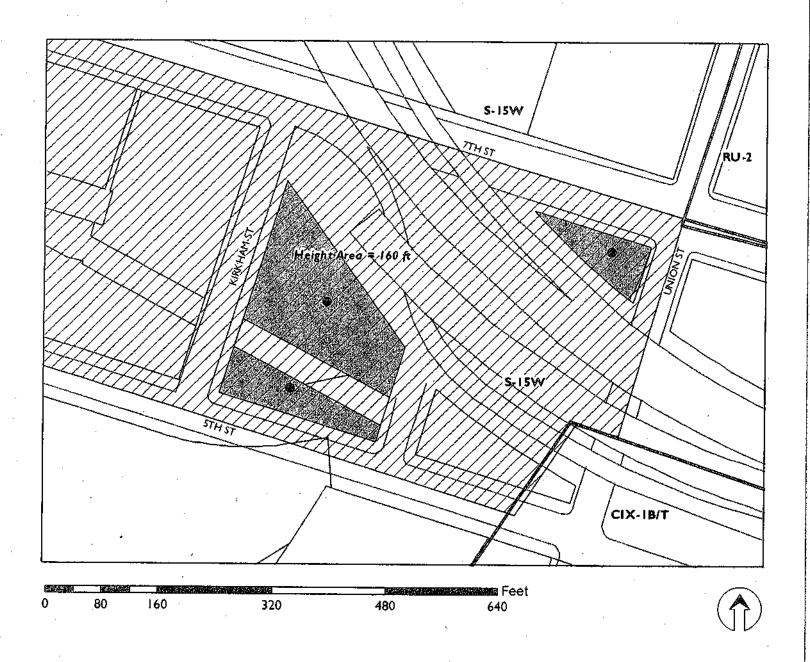

Case File:

PLN 17428 / PUDF07

Applicant:

Panoramic Interest, Zac Shore

Address:

500 Kirkham Street

Zone:

S-15W

Height Area:

160 ft

Page 3

PROJECT SITE AND SURROUNDINGS

The property is paved, contains a vacant one-story commercial building and is enclosed by a six-foot high chain-link fence. The property is bounded by Kirkham Street to the west, 7th Street to the north, Union Street to the east and 5th Street to the south. The property is surrounded by a mix of uses including medium density four-story residential and two-story commercial and light industrial buildings. Nearby uses or facilities include auto-fee parking lots, Caltrans storage yards, BART elevated tracks and the West Oakland BART Station. The site is also near I-880 west-bound/east-bound freeway ramps and within the vicinity of the Prescott and Acorn residential neighborhoods including the Mandela Parkway Park.

PROJECT PROPOSAL

The proposal "The Hub" is to construct three detached buildings that will provide a mix of residential unit types, retail and flex-commercial spaces. The project includes private courtyards, roof decks, upper terrace and a small parking lot. Between the buildings, two landscaped pathways, identified in the attached plans as "community gathering spaces" traverse the property from 7th Street to 5th Street to provide access to the flex commercial spaces and building separation. The applicant proposes to develop the project in two phases. Phase 1 involves the construction of the two detached mid-rise buildings (buildings #1 and #2), an eight-space parking lot and pop-up retail area; and Phase 2 involves the construction of a high-rise building (building #3). The existing support columns and the elevated BART tracks crossing the property near Kirkham and 5th Streets will not be altered. The applicant indicates that the proposed buildings will be distanced at least 20 feet from the elevated tracks, which is based on the development guidelines by BART. The following table is a summary of the proposed buildings:

Project Program	Building 1 (mid-rise)	Building 2 (mid-rise)	Building 3 (high-rise)
Building Height/Story	84-ft. / 9 stories	84-ft. / 8 stories	233-ft. / 23 stories
Building Gross Area	254,969 sf.	210,433 sf.	447,086 sf.
Number of Units	329 residential units	267 residential units	436 residential units
Retail Floor Area	4,581 sf.	4,419 sf.	9,401 sf.
Flex Space Floor Area	10,319 sf.	10,194 sf.	5,343 sf.
Off-Street Parking	8 parking spaces	No parking spaces	No parking spaces
Off-Street Loading	0 space	0 space	0 space

The development proposal provides a mix of 1,032 residential units ranging from studios, one-bedroom to four-bedroom and 10-bedroom units (rooming house). The applicant has not provided any specific information as to how the market rate and affordable residential units will be arranged in the three buildings. The following table shows the type of bedroom and count for the residential units:

Bedroom Type	Building 1 (mid-rise)	Building 2 (mid-rise)	Building 3 (high-rise)	Unit Size*
Studio:	0 units	1 studio	0 units	441-sf
One-Bedroom:	14 units	0 units	73 units	392/468-sf
Two-Bedroom:	151 units	137 units	0 units	462-sf
Two-Bedroom Suite	112 units	103 units	255 units	546-sf
Three-Bedroom:	52 units	26 units	22 units	676-sf
Four-Bedroom:	0 units	0 units	64 units	900-sf
Ten-Bedroom: (rooming house) **	0 units	0 units	22 units	2,532-sf
Total Unit Count:	329	267	436	

Page 4

* The size of these units are approximate and may vary in the future

** In the S-15W zoning district, a rooming house will require a Conditional Use Permit. Rooming units are a suite of rooms, not including a kitchen, designed or occupied as separate living quarters, with or without common boarding provisions.

The principal entry for the residential units will be from 7th Street through the ground-floor lobbies in each building. The ground-level of the buildings contains a lobby, bicycle storage, trash/recyclable and utility rooms including laundry areas in the upper floors. The entry for the retail and flex space units will be from 7th Street, Kirkham Street, Union Street and through the "community gathering" pathways. The proposal includes four new curb cuts on 7th and 5th Streets to allow partial vehicular access into the pathways for the commercial-flex spaces. The project provides a surface parking lot with a total of eight spaces for retail use, located under the BART elevated tracks and near Kirkham and 5th Streets. Access to the parking lot will be from 5th Street and exit into Kirkham Street. The proposal does not provide within the property any additional off-street residential parking, residential or commercial loading berths.

The project includes private courtyards that contain concrete paving pathways and plazas with pergolas, shared stoops, metal grate crossovers over the bio-retention areas, planting area and a row of 36-inch size trees. The courtyards will be accessed from the ground floor of the buildings and 5th Street through a door that contains a 34-foot tall metal panel wall. The applicant indicated that the reason for such a tall wall is to reduce noise from the passing by BART trains. The courtyards will have a mix of wall-mounted sconce lighting and led pedestrian post lighting. Furthermore, the project includes "community gathering space" pedestrian pathways with entry plazas, removable bollards, wooden benches, pergolas, color concrete and pavers, planting areas, bio-retention areas, a cluster of 36-inch size trees with metal grates, wall-mounted and pedestrian post lighting fixtures. No entry doors or gates are proposed at the entry of the pedestrian pathways at this time, and access will be limited to fire trucks. The project does not propose any other outdoor amenities such as playgrounds or barbecue areas for the 1,032 residential unit facility. The proposal also includes the installation of approximately 32 new street trees around the property that would replace the 15 street trees proposed for removal.

The project includes design concepts for public art within the 'community gathering" pedestrian pathways and along the south and east facade of the buildings. The proposed public art range from images and other creative elements or structures. The applicant also proposes additions and/or modifications to the West Oakland Historic Art signage walk along 7th Street. These existing art works derive from the City's 7th Street Concept and Urban Design Plan by Walter Hood adopted in 2004. The intent of the Plan is to provide recommendations to reduce impacts of transportation, primarily on the 7th Street between Wood and Union Streets. The plan also recommends amenities conducive to future transit oriented development and activity with emphasis on creating a strong civic character for identity. See pages G0.7 & G0.7.1 of the design plans for details.

GENERAL PLAN POLICIES

The development proposal is located in the Community Commercial of the Oakland General Plan Land Use and Transportation Element (LUTE). The intent of the Community Commercial is to identify, create, maintain and enhance areas suitable for wide variety of commercial and institutional operations along the City's major corridors and in shopping districts and centers. The desired character and uses in the community commercial districts may include neighborhood center uses and large scale retail and commercial uses, such as auto related businesses, business and personal services, health services and medical uses, educational facilities and entertainment uses. The community commercial areas can be

Page 5

complemented by the addition of urban residential and compatible mixed use development. Based on plans submitted, below are the City's policies that would be applicable to the project when a decision is made by the Planning Commission in the future. Staff has summarized how the proposal may or may not meet the intended policies:

<u>Policy N1.1 / Concentrating Commercial Development:</u> Commercial development in the neighborhoods should be concentrated in areas that are economically viable and provide opportunities for smaller scale, neighborhood-oriented retail.

The proposal would provide retail and flex space commercial units on the ground floor of the buildings to create business opportunities that can be allowed under the underlying zoning district. Some of these commercial activities can include custom-manufacturing goods, general food sales and/or compatible personal services. The flex space would comply if it includes active commercial uses.

Policy N1.5 / Designing Commercial Development: Commercial development should be designed in a manner that is sensitive to surrounding residential uses.

The proposal includes ground floor retail and flex space commercial facilities that would be sensitive to the character of the surrounding residential properties. However, because the project does not include on-site commercial loading spaces, staff believes that large vehicles would use curb side parking or park on the street, which may affect traffic flow on the surrounding streets.

<u>Policy N3.1 / Facilitating Housing Construction</u>: Facilitating the construction of housing units should be considered a high priority of the City of Oakland.

The proposal would provide substantial new housing on a site that has not been developed for high density residential and thus, the project would increase the housing stock that is much needed in the City.

<u>Policy N3.2 / Encouraging Infill Development</u>: In order to facilitate the construction of needed housing units, infill development that is consistent with the General Plan should take place throughout the City of Oakland.

The proposal is located in an urban setting and the construction of new housing on an underdeveloped site will be consistent with the General Plan for providing additional residential units. However, as the application is not yet complete, staff has not fully analyzed the proposal in order to determine if it is fully in compliance with the General Plan.

<u>Policy N3.8 / Required High-Quality Design</u>: High-quality design standards should be required of all new residential construction. Design requirements and permitting procedures should be developed and implemented in a manner that is sensitive to the added costs of those requirements and procedures.

The proposal provides a design intended for high density development, but further development is recommended to meet the applicable policies and criteria. The building needs at least massing relief and design features to improve visual appearance.

Policy N3.9: Orienting Residential Development. Residential development should be encouraged to face the street and to orient their units to desirable sunlight and view, while avoiding unreasonably blocking

Design Review Committee

Case File Number: PLN17428 / PUDF07

February 28, 2018

Page 6

sunlight and views for neighboring buildings, respecting the privacy needs of residents of the development and surrounding properties, providing for sufficient conveniently located on-site open space, and avoiding undue noise exposure.

The proposal includes on-site open space for its residential units, but further development is recommended to increase the size and accessibility of open space at least for the units in the high-rise. The open space on the roof deck and lower terrace may not be of adequate size and practical for the residents of the proposed 436 residential units.

<u>Policy N3.10: Guiding the Development of Parking.</u> Off-street parking for residential buildings should be adequate in amount and conveniently located and laid out, but its visual prominence should be minimized.

The project proposal does not provide adequate off-street parking, is and the applicant has yet to demonstrate analysis that justifies that additional parking can't be accommodated in the property. Staff is concerned that; one) what little parking is provided is visually prominent; and that two) With no on-site parking for over 1,000 residential units, even minimal parking demand for the project would negatively affect public parking and circulation in the surrounding area.

<u>Policy N6.1: Mixing Housing Types</u>. The City will generally be supportive of a mix of projects that provide a variety of housing types, unit sizes, and lot sizes which are available to households with a range of incomes.

The proposal includes a mix of residential units that vary in bedroom type and size area and would also accommodate households with different incomes.

<u>Policy N8.1: Developing Transit Villages</u>. "Transit Village" areas should consist of attached multi-story development on properties near or adjacent to BART Stations or other well-used or high volume transit facilities, such as light rail, train, ferry stations or multiple-bus transfer locations. While residential units should be encouraged as part of any transit village, other uses may be included where they will not negatively affect the residential living environment.

The proposal is within a Transient Oriented Development (TOD) area that includes high-density residential and ground floor commercial development, located near the West Oakland BART Station. The mixed-use project would also serve other existing transportation nodes such as AC transit bus lines and thus contribute to a pedestrian-oriented environment.

ZONING ANALYSIS

The proposal is located in the S-15W Transit Oriented Development Zone. The S-15W regulations are intended to create, preserve and enhance areas devoted primarily to serve multiple nodes of transportation and to feature high-density residential, commercial, and mixed-use developments to encourage a balance of pedestrian-oriented activities, transit opportunities, and concentrated development.

Development in the S-15W zone is intended to encourage a safe and pleasant pedestrian environment near transit stations by allowing a mixture of residential, civic, commercial, and light industrial activities, allowing for amenities such as benches, kiosks, lighting, and outdoor cafes; and by limiting conflicts

Design Review Committee

Case File Number: PLN17428 / PUDF07

February 28, 2018 Page 7

between vehicles and pedestrians, and is typically appropriate around transit centers such as Bay Area Rapid Transit (BART) stations, AC Transit centers, and other alternatives for transportation nodes.

The proposal partially meets the intent of the S-15W Zone by creating a high density residential and commercial building that will also promote and enhance the use of the existing major transportation systems such as AC Transit lines, BART and other potential modes of transportation such as car-share, bike-ride, etc. The proposal will in some ways facilitate the growth of pedestrian-oriented activities because retail uses and other commercial uses are included in the project that will serve local and regional residents, thus contributing to a vibrant transit corridor in the West Oakland BART Station area.

While the proposed project meets some of the objectives of the underlying zoning district, it is deficient and/or not enough information is provided to determine compliance with regards to specific regulations. Staff recommends that the applicant revise the project to meet the required zoning regulations as described in the table below. The table below shows the applicable regulations and development proposal in the S-15W zone:

Development Standards	Requirements	Proposed	Comments
Minimum Lot Area	4,000 sq. ft.	3.15 acres	Meets Code
Minimum Lot Width and Frontage	25 ft.	372 ft. to 520 ft.	Meets Code
Maximum Residential Density	611 units (baseline or outright permitted)	1,032 units	Allowed per PUD and Density Bonus Regulations
Maximum Building Height *	160 ft.	233 ft.	
Maximum Building Height on Principal Street (7th St) * (If within 10 feet of the front property line, the maximum building height is the height area of the parcel across the principal street, whichever is less)	75 ft.	84 ft. (Buildings 1 & 2) 233 ft. (Building 3)	Does Not Meet Code: May qualify if conforms to
Off-Street Parking-Residential *	361 spaces **	0 spaces	criteria for Density Bonus
Group Open Space *	206,400 sq. ft.	22,125 sq. ft.	& PUD
Minimum Front Setback	0 ft.	2.5 ft. to 5 ft.	Meets Code
Minimum Street Side Setback	0 ft.	1.5 ft. to 8 ft.	Meets Code
Minimum Rear Setback (Residential)	10 ft.	1.3 ft. to 5.7 ft.	Does Not Meet Code
Ground Floor Off-Street Parking &	20 ft.	10 ft,	Does Not Meet
Loading within Pedestrian Walkways			Code
Off-Street Parking-Retail/Commercial	0 spaces	8 spaces	Meets Code
Residential Loading Berth	1 space	0 space	Does Not Meet Code
Commercial Loading Berth	1 space	0 space	Does Not Meet Code

Design Review Committee

February 28, 2018

Case File Number: PLN17428 / PUDF07

Page 8

Development Standards	Requirements	Proposed	Comments
Bicycle Parking-Residential Long Term	258 spaces	299 spaces	Meets Code
Bicycle Parking-Residential Short Term	52 spaces	207 spaces	Meets Code
Bicycle Parking-Commercial Long Term	4 spaces	6 spaces	Meets Code
Bicycle Parking-Commercial Short Term	22 spaces	23 spaces	Meets Code

^{*} The proposed building height, off-street parking, building height within 10 feet of 7th street and group open space are at least four elements that require deviation or reduction from the development standards when the project seeks Density Bonus.

Density Bonus

The applicant proposes a Density Bonus and Planned Unit Development to include affordable residential units. The purpose of the State and City's Density Bonus and Planned Unit Development provisions is to encourage the construction of affordable housing where incentives or concessions and waivers can be applied to provide relaxation of the required development standards. California Government Code Section 65915 states that local governments shall grant a density bonus and concessions or incentives to residential development that includes a percentage of affordable units within the project site.

The applicant proposes a Density Bonus of 35% and Planned Unit Development bonus of 25% to construct 11% of very low-income affordable units within the property. The proposal would increase the number of residential units from the allowed 611 units to 1,032 units. Based on State and City Density Bonus regulations, the applicant can receive up to two concessions and can also ask for two waivers or relaxations from the development standards. Based on documentation submitted, the following table shows the applicable density bonus regulations, the applicant's request, and the State and City's allowance for concessions/incentives and waivers:

	A	FFORDABLE	HOUSING	CONCESSION	AND WAI	VER ANALYSIS		
G	ity Regulations		Apı	plication Requ	est		Allow	rance
Gode Section	Standard	Density Allowed	Density Bonus	Concession	Waiver	Justification/ Comment	State Law Section	City Code
Planned Unit	t Development	Regulations	(PUD)	\$4. E. S. S.				
17.142.004(B)	Dwelling Units (du)	611 du	153 du (max. 25% increase)	N/A		Meets Planning Code.	N/A	17.142.100 E (2)
2 2 3 3 5 4 2 3 9 W	No. 172 100 1011		153+611= 764 du					
Density Bonu	is and Concessi	ons or Incen	tive Proced	lures		<u> Paristana da Pari</u>		
17.107.010	Dwelling Units (du)	764 du (based on S15W and PUD regulation s)	268 du (max. 35% increase)	Up to Four (Building height, building height	Up to Four (Building height, building	Only two concessions or incentives allowed per State and City Regulations;	Government al Code Section 65915(d)(1)(2)(B)	17.107.040 (C)
	<u> </u>		268+764=	setback	height	however,		

^{**} The required number of parking spaces for this project is 516 spaces (½ parking space per unit in the S-15 zone). Section 17.116.110(c)(1) of the OMC states that required parking can be reduced up to an additional 30% when located within Transit Accessible Areas such as BART. So, the proposed count is 516 x 0.30 (155) = 361 parking spaces.

Page 9

the design			A site of the Contract of the	Contract to the second		VER ANALYSIS		e eu
Cit	y Regulations		App	olication Requ	est		Allow	ance 🐷
Code Section	Standard	Density. Allowed	Density Bonus	Concession	Waiver	Justification/ Comment	State Law Section	City Code
			1,032 du (total proposed)	within principal street, off- street parking, Open space	setback within principal street, off- street parking, open space)	application requests up to four and does not clarify whether requests are specifically for concessions or waivers		
	i					Above density bonus allowances, applicant would need to request variances and make findings		·

Based on the State and City's regulations for Density Bonus and Planned Unit Development (PUD) and the applicant's request it shows that at least four significant elements of the project require reduction or deviation from the City's development standards as follow:

- a) Building Height (high-rise)
- b) Off-street parking
- c) Open space; and
- d) Maximum building height within 10 feet of the front property line on 7th Street

Under Government Code 659159(d)(2)(b), the proposal is entitled to request two incentives or concessions. Additional relief from the strict application of the City's zoning regulations may be available under the waiver provisions of Government Code 659(e)(1). However, the proposed application shows that a total of four waivers are requested, where two waivers could only be permitted under the allowed concessions or incentives. So, if the project proposal seeks two additional waivers under the Density Bonus regulations, these would not be allowed. Without any justification for the two additional waivers, the proposal will require a Variance permit that staff may not be able to support.

PROJECT DESIGN

The envelopes for the buildings are sited in three sections on the large parcel and include pedestrian pathways, courtyards and other small outdoor areas to provide circulation access through the ground-floor commercial spaces and around the property. The mid-rises' two private courtyards and the high-rise L-shaped building are designed to provide natural light and views of the streets for the residential units. The high-rise and two mid-rise buildings step down from the east to the west to some degree to manage volume. The buildings provide similar roof and wall planes, except for a section of the west and north sides of the high-rise walls that are set back to provide open space to the nine residential units on level 9. Also, the south façade of Building 1 and east façade of the retail space on Building 3 provide different wall planes to provide mass relief. The ground-floor retail has a glazing storefront of approximately 18 feet high. The building windows are symmetrical and of different sizes. The building vertical and

Page 10

horizontal bands and Juliette balconies help to provide form and scale. The building also provides a variation of materials that include metal cladding, cement fiber panels with reveal joints, aluminum widows and storefront frame including subtle colors. The project provides a variety of landscaping that range from 36-inch size Birch, Gingko and London trees to a mix of 5-gallon shrubs and lawns to be planted in the courtyards, "community gathering spaces" pedestrian pathways and on the upper level terrace of Building 3. The plan includes a mix of structures such as wood benches, concrete seating walls, texture sidewalks and colorful pavers including decorative outdoor lighting.

Staff has worked with the applicant to provide more elegant massing, articulation and façade variation to reduce the appearance of monotonous and bulky massing. However, staff remains concerned that the buildings are not sited to provide an inviting site plan with a rich public-private interface, and that the buildings are not yet elegant and attractive.

DESIGN GUIDELINES APPLICABLE TO ALL INDUSTRIAL / BUSINESS / COMMERCIAL OPPORTUNITY AREAS IN THE WEST OAKLAND SPECIFIC PLANS (WOSP)

The following guidelines are applicable throughout the West Oakland Specific Plan's industrial/business/commercial Opportunity Areas. The Intent for new construction and renovation in the four identified Opportunity Areas should be designed to maintain continuity with West Oakland's unique history and character. The proposed project is located in the West Oakland Specific Plan (WOSP) Opportunity Area 2 (7th Street).

SITE PLANNING

<u>Site Planning 1 / Pedestrian Circulation</u>: Active street edges with entrances from city sidewalks should directly face streets, maximizing the utilization of city sidewalks by users of the buildings.

The project provides direct access from the street to the proposed residences, retail, flex space and community gathering pathways. These entries are located around the property, thus making them adequate for the users of the property and to the general public. However, the edges of the buildings and the areas where the on-site open space meet the public rights-of-way are not detailed enough to indicate articulated, welcoming project entries with appropriate gateway and amenity features.

<u>Site Planning 2 / Vehicular Circulation</u>: Vehicular entrances and garages should be less prominent than pedestrian entrances.

The proposed project only provides within the property an eight-space surface parking lot for commercial use. The entry for this small parking lot will be on 5th Street, near Kirkham Street. The entry for the open non-residential parking lot facility will not be prominent because it is located under the BART elevated tracks and will contain new landscaping for screening. However, the eight-space surface parking lot is prominent in that it is unenclosed and near the property line with the public right-of-way and will require a Conditional Use Permit for an open Nonresidential facility.

<u>Site Planning 3 / Service Circulation</u>; Service areas should be hidden from view from sidewalks whenever possible.

The proposed service areas such as the trash/recyclable rooms are fairly distanced and screened from view from the sidewalks. However, it is unclear how some of the flex spaces on Buildings 1 and 2 will

Design Review Committee

Case File Number: PLN17428 / PUDF07

<u>February 28, 2018</u>

Page 11

have convenient access to the service rooms. The plans do not show any internal access to the service rooms and would require tenants of the flex spaces to walk at least 280 feet to the closes service rooms.

<u>Site Planning 4 / Building Footprint</u>: New construction should be built to the edge of sidewalks to maintain the continuity of the area's street walls. Small ground-level inset bays for entrances, outdoor seating, and special corner features are appropriate variations within the street wall. In addition, an occasional plaza may be also appropriate.

- · Relate to existing buildings and utilitarian structures, which need to be rehabilitated and reused.
- Expansion of existing buildings is encouraged, with unique aspects of existing buildings respected, featured, and protected.
- Surface parking is strongly discouraged along frontages facing public streets.

The proposed project provides a building footprint close to the sidewalk along the front and street side of the property. The ground floor of the buildings along 7th and Kirkham Streets are slightly setback to allow for potential outdoor seating; and the main entry doors are also recessed to identify and provide distinction along the storefront. At this time, the proposal does not contain prominent building corner features at the main street intersections such as Kirkham and Union Streets.

<u>Site Planning 5 / Open Space</u>: West Oakland's public streetscapes along with its parks need to be embraced, improved, and enriched as public open space elements. Any new open space located in public view should not be walled from the street by dense planting or a tall fence.

To improve the public streetscape, the proposal includes the replacement of the street trees around the project site. The proposal includes courtyards for the two low-rise buildings that can be seen from public view along 5th Street. The two courtyards, however, include a 34 foot tall wall metal fence intended to minimize noise reduction from the adjacent BART tracks.

BUILDING DESIGN

<u>Building Design 1 / Massing:</u> New buildings should be designed with major massing elements that are consistent with those found in existing desirable buildings located in the immediate vicinity.

The project contains two mid-rise and one high-rise buildings that range from 7-story to 23-story. As discussed in this staff report, the proposed buildings provide minimal massing relief on the facades and roof to create a cohesive composition. The proposal needs to consider using different design components to create volumes and articulation to create balance and style.

<u>Building Design 2 / Fenestration and Materials</u>: Fenestration elements, such as windows, doors, louvers, vents, wall panels, skylights, storefronts, curtain walls, and other glazed systems, can be either more historic or more contemporary depending on the context, and should be articulated to maintain the sense of scale found in the immediate context.

The project provides a cohesive arrangement of various size of windows, wall panels and glazing storefronts that are contemporary and help to reduce the visual scale of the large building frontage.

Page 12

WEST OAKLAND SPECIFIC DESIGN GUIDELINES TO THE 7TH STREET OPPORTUNITY AREAS

The following section of the Design Guidelines addresses the urban design strategies and guidelines that are particular to the 7th Street Opportunity Areas, especially as to neighborhood commercial corridors with housing. The 7th Street guidelines intend that the project become the focus of the surrounding neighborhoods with active street edges that would encourage neighbors and visitors to experience a high-quality urban streetscape.

NEIGHBORHOOD COMMERCIAL

<u>Neighborhood Commercial 1/ Site Planning:</u> Buildings should be built immediately fronting 7th Street to emphasize and re-establish where necessary the continuity of the neighborhood commercial street. Ground floors should have active publically accessible uses such as restaurants, retail, lobbies and galleries. Driveways and vehicular entrances are discouraged from accessing directly from 7th Street and moved to side streets where feasible.

The proposal contains three detached mixed-use buildings that front 7th Street to create continuity in the S-15 Transit-Oriented Development Commercial zone. The project includes ground floor retail and residential lobbies that would be accessible from 7th Street and thus create a more active environment on the main corridor. The proposal also includes two separate driveways for partial vehicular access to the "community gathering" pedestrian pathways, which is opposite to the prescribed 7th Street guidelines.

<u>Neighborhood Commercial 2 / Massing</u>: Residential upper stories are encouraged to include bay windows above the ground floor to provide light and air, and to break up the scale of buildings and convey residential use.

The project development contains buildings that range from 7-story to 23-story, but do not contain any bay windows to the residences or provide articulation to create visual relief to the building mass.

<u>Neighborhood Commercial 3 / Height</u>: Except when located at important intersections such as Mandela Parkway and 7th Street, buildings over 5 stories in height should generally include a significant stepback along commercial arterial roadways to harmonize the scale of new buildings with the existing neighborhood.

The project proposal is not located at the intersection of 7th Street and Mandela Parkway. The project includes buildings that are more than five stories in height and do not provide a significant step-back from the main commercial corridor, 7th Street, to create a balanced scale with other buildings in the area.

<u>Neighborhood Commercial 4 / Fenestration:</u> Ground floors should have as many openings as possible with as few blank wall sections as possible. Awnings and canopies are encouraged.

The proposal provides a decent amount of openings and glazing along the ground floor on 7th Street. The project development, however, can use additional awnings or canopies to define and make the main entries more prominent from the commercial corridor.

Design Review Committee

Case File Number: PLN17428 / PUDF07

February 28, 2018

Page 13

<u>Neighborhood Commercial 5 / Materials</u>: Buildings should have a variety of high quality materials that will define an interesting character when viewed up close and from a distance.

The proposal provides a modest mix of materials and colors that range from light to medium color metal cladding, cement panels, powder coated storefront and aluminum window framing, gray glazing, accent colors and perforated metal balcony railings.

<u>Neighborhood Commercial 6 / Renovation of Older Buildings</u>: Older commercial buildings should be restored in a manner consistent with their original architectural style.

The project proposal does not plan to restore the existing one-story commercial building because it will be demolished as part of the new development. The property is not considered a historic property or in a historic district.

<u>Neighborhood Commercial 7 / Landscape</u>: Street trees should be of a type that allows high visibility to storefronts and spaced to allow street lights to penetrate to sidewalks during nighttime.

The proposal includes a landscaping plan that shows the installation of a mix of street trees around the property. The species of the street trees range from 36-inch box size Quercus Suber, Pistacia Chinensis and Gingko Biloba trees. The plan also shows that these trees are spaced between an average of 20 to 40 feet on center. The majority of the street trees will be planted on a landscaped strip, except for the trees on 7th Street which will be contained in a well surrounded by metal grates.

<u>Neighborhood Commercial 8 / Landscape</u>: Publicly accessible outdoor space areas should be comprehensively designed with high quality pavement, landscaping, and seating, and are encouraged at the following locations: Mandela and 7th Street, San Pablo Avenue and West Grand Avenue, San Pablo and 32nd Street.

The project proposal is not located on any of these street intersections, so it does not apply. However, the project includes "community gathering spaces", located between the mid-rise and high-rise buildings. These pedestrian pathways are designed to provide direct access from 7th and 5th Streets to the ground floor commercial flex spaces. These two pedestrian pathways provide some type of open space that include furniture and landscaping such as pergolas, benches, planting areas and color paving surfaces to create an inviting environment to the public and residents as well. It should be noted that the community gathering spaces are unarticulated and the buildings on either side are not stepped back. These areas risk being dark, cold, and unanimated without a high-quality, detailed design.

Design Review Committee

Case File Number: PLN17428 / PUDF07

February 28, 2018

Page 14

DESIGN ISSUES

Based on design plans provided, staff has reviewed the project and has the following comments for consideration by the Planning Commission:

Site Planning

Public Right-of-Way:

The proposed design plans, received on February 10, 2018 provide minimal information as to the extent of any right-of-way improvements around the subject property. Other than proposing new or improved curb-cuts for ADA access ramps and extension of the existing median strips around the project site, staff believes that additional detail plans are needed to better evaluate the project and provide recommendations. Typically, such information is provided when a Subdivision Map and/or a Planned Unit Development plan is provided. The submission of a subdivision map to merge and subdivide the property into three new parcels has not been submitted to provide additional information that can help assess the off-site improvements as it relates to the proposed project.

Parcelization:

The applicant has indicated that the existing three parcels will be reconfigured and merged into three new parcels through a subdivision map. The three new proposed parcels would allow each of the proposed detached buildings to be developed in two phases. Phase 1 will include the construction of the two mid-rises and Phase 2 will include the construction of the high-rise. Without the required subdivision map, it is not clear at this time where would the property lines be located in relation to the proposed "community gathering space (pedestrian pathways) and building separation. If the map shows a proposed property line in the center of the pedestrian pathways, it may or may not conform to the zoning development standards such as building setbacks or will it conflict with any proposed utility easements. The subdivision map is critical to analyzing the project and determining appropriate permits and procedures.

Building Design

Building Height and Mass:

The proposal provides three detached buildings, two mid-rises and one high-rise. The two midrise buildings measure up to 84 feet in height and the high-rise measures up to 233 feet in height to the rooftop. The maximum allowed building height in the S-15W zoning district is 160 feet. Because the application includes a Density Bonus, the project sponsor is entitled to request for concessions or incentives. So, in this case the applicant proposes a building height increase of 233 feet (+73 feet). Staff believes that this transit-oriented development site could accommodate the proposed density. However, staff has some concerns about the massing of the buildings. The West Oakland Specific Plan Design Guidelines implies for continuity with the West Oakland's unique history and character. The intent of the guidelines is for new buildings to be designed with major massing elements that are consistent with buildings in the immediate vicinity. The current massing of the buildings is bulky and monolithic, and needs to be finessed to create different volumes and articulation. The proposal can use a strong variation of roof and façade planes to provide an attractive appearance when viewed from the street and from distant views from around the city. Staff comments also apply to the two mid-rise buildings that further development is recommended to break up mass on the facade and roof planes. The height of these two buildings

Page 15

are not of a concern, but how the massing can be improved to provide visual relief and interest within the context of the neighborhood is of concern.

Land-Uses

Off-street Parking:

The project proposes a total of 8 parking spaces for commercial use on a small surface parking lot, located near the intersection of 5th and Kirkham Streets. Per the S-15W zone district, the required number of parking spaces for the proposed application is 516 spaces (0.5 parking space per residential unit). Zoning regulations also allow additional parking reduction of 30%, when a project development site is located in a Transit Accessible Area such as BART. So, the result for the base parking count for required off-street residential parking is 361 spaces within the property. Furthermore, per the Density Bonus regulations, the applicant can request incentives or concessions to reduce the required number of off-street parking. In this case, the applicant is proposing to reduce residential parking to zero and instead proposes 8 parking spaces primarily for commercial or retail uses in a small surface parking lot. Staff believes that the proposal for not providing off-street parking for the residential units and/or parking for residential and commercial loading berths may be of a concern in the surrounding neighborhood.

CONCLUSION

The proposed project reflects to some degree the intent of the S-15 W zoning district and vision of the West Oakland Specific Plans (WOSP) for developing multi-story, high-density mixed-use development in Transit-Oriented Development Commercial Zones. There are issues, however that staff believes are significant and need to be addressed to improve the overall design appearance of the buildings. Staff has concerns regarding the lack of building wall and roof planes particularly along 7th Street. Although the buildings integrate horizontal and vertical design features, the buildings appear bulky and massive in appearance. To provide visual relief on the building mass it is recommended that further development is made to improve articulation and design interest of the building facades. At a minimum, staff recommends the applicant consider and incorporate on a revised design plan the following:

- Provide roof plane variety to be less monotonous to create a balance proportion and articulation. The high-rise roof plane needs further development to reduce the heavy top. The building roof can also use a prominent design feature to provide interest. The low-rise building also need roof plane articulation to reduce bulk. It is suggested that the low-rise building at 7th and Kirkham Streets include a design feature such as a marquee to make the entry more prominent.
- Submit conceptual design plans for future commercial signage for retail and flex spaces.
- Include details for the courtyard 34-foot tall wall metal panel, and building windows.
- Integrate sun shades or trellises and aesthetic features on the roof deck and upper terraces.
- Consider removal of new curb cuts /driveways on 7th Street for the community gathering areas.
- Provide additional information (program) for the operation of the pop-up retail activities.
- Include laundry areas for the residential tenants of Building 3/ high-rise.
- Provide decorative lamps in the public open spaces, community gathering spaces and courtyards.
- Screen from view all utility equipment from public view and from building rooftop.
- Submit details for the solar system located on the rooftop.
- Review with City Public Works/Traffic the feasibility for all street parking around the site.

Design Review Committee

Case File Number: PLN17428 / PUDF07

<u>February 28, 2018</u>

Page 16

RECOMMENDATION

Staff recommends that the Design Review Committee consider the proposal and provide comments to the applicant and staff before the proposal is considered by the Planning Commission at a future public hearing.

Prepared by:

Mike Rivera

Major Projects Development

Bureau of Planning

Approved for forwarding to the

Design Review Committee:

Catherine Payne

Acting Development Planning Manager

Bureau of Planning

ATTACHMENTS

Project Design Plans, dated February 9, 2018

THE HUB

500 KIRKHAM STREET OAKLAND, CA 94607

PROJECT DIRECTORY

PANORAMIC INTERESTS 1221 MISSION STREET SAN FRANCISCO, CA 94103 ZAC SHORE 415, 721, 7002 ZAC@PANORAMIC COM FLETCHER STUDIO 2325 3RD STREET SUITE 413 SAN FRANCISCO MITO? DAVID FLETCHER 415.431,7878 DFLETCHER@FLETCHERSTLIDIO.COM LOWNEY ARCHITECTURE 360 17th STREET, SUITE 100 OAKLAND, CA 94612 ATTN, NCK GOMEZ NICKGLOWNEY ARCH COM 510.838,5400 510.838,5400 510.838,5400 KPFF ENGINEERS
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WATERPROOFING: CROSS 2 DESIGN GROUP 2475 WESTLAKE AVE N, SUITE 102 SEATTLE, WA 88109 200 283 0066

PROPOSED PROJECT



PROJECT LOCATION

Attachment A

9 2018 City of Oakland



DRC SUBMITTAL 02/09/18

DRAWING LIST

	DRAWING LIST	
SHEET NUMBER	SHEET NAME	
090		
G0.0	COVER SHEET	
C0.2	PROJECT INFORMATION	
00.3	PROJECT INFORMATION	
90.4	EXISTING CONDITIONS	
Q0.5	EXISTING CONDITIONS	
00.6	EXISTING CONDITIONS	
00.7	PUBLIC ART ELEMENT	
CO,T,1	HISTORIC ART I SIGNAGE	
G0.8	SITE PLAN	
C0.9	PUBLIC SPACE PRECEDENTS	
LANDSCAPE	Total Control of the	
L1.00	RLUSTRATIVE SITE PLAN	
L2 00	BUILDING 1 COURTYARD PLAN	
12.01	BUILDING 2 COURTYARD PLAN	
U.DO	COMMUNITY GATHERING SPACE 1 PLAN	
13.01	COMMUNITY GATHERING SPACE 2 PLAN	
L3:22	COMMUNITY GATHERING SPACE 1 & 2	
L4:00	BUILDING 3 PUBLIC OPEN SPACE PLAN	
LAM	PUBLIC OPEN SPACE & POP-UP RETAIL PLAN	
L5.00	TREE PRESENDIATION PLAN	
ORC		
A2.0	DVERALL GROUND FLOOR PLAN	
A2.1	RLDG 1 LEVELS 1 & M FLOOR PLANS	
A2.Z	BLDG 1 LEVELS 24 LEVELS 34 FLOOR PLAN	
A2.3	BLDG 1 ROOF PLAN	
AZA	BLDG 2 LEVELS 1 & M FLOOR PLANS	
A2.5	BLDG 2 LEVEL 2 & LEVELS 3-7 FLDOR PLAN	
A2.5	BLDG 2 ROOF PLAN	
A2.5	BLDG 3 LEVEL 1 & 2 FLOOR FLANS BLDG 3 LEVEL 3 22 TYP A ROOF FLAN	
A32	OVERALL EXT. ELEVATION - NORTH	
A3.1	DIFFALL FIT BLEVATION - NORTH	
43.2		
A34	OVERALL DIT. ELEVATION - WEST OVERALL EXT. ELEVATION - EAST	
AAD	OVERALL SECTION	
ALI.	SLDG 1 SULDING SECTIONS	
ALZ	BLDG 2 BUILDING SECTIONS BLDG 2 BUILDING SECTIONS	
AL3	BLDG 3 BUILDING SECTIONS	
A5.0	PERSPECTIVE	
A5.1	PERSPECTIVE	
A5.2	PERSPECTIVE	
A5.3	PERSPECTIVE	
A5.4	PERSPECTIVE	
ASS .	PERSPECTIVE	
AD.S	PERSPECTIVE	
AS.7	PERSPECTIVE	
40.0	PERSPECTIVE	
At 2	BLDG T - LICHTING PLANS	
A8.1	BLDG 2 - LIGHTING PLANS	
ALZ.	BLDG 1 - LIGHTING PLANS	

lowney arch

PROJECT NAME

500 Kirkham

PANORAMIC INTERESTS

500 KIRKHAM ST, DAKLAND, CA

ARCHITECT

NOT FOR CONSTRUCTION

CONSULTANT

CONSULTANT STAMP

DATE ISSUES & REVISIONS BY 0209/2018 DRC SUBMITTAL



DRAWN BY: PROJECT NUMBER:

SHEET ISSUE DATE: SHEET TITLE

COVER SHEET


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17-007

11/27/17

Planning & Zoning Division

BUILDING 3/4PHASE II LEGEND RETAIL FLEX SPACE LOBBY UTILITY 1 SITE PHASING PLAN

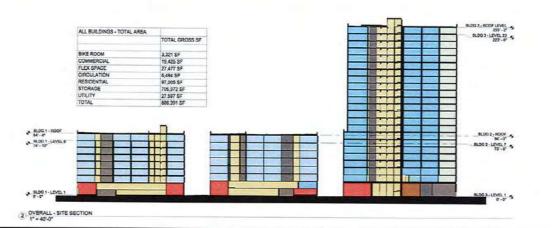

PROJECT DATA

SITE LOCATION: LOTAREA

500 KIRKHAM STREET OAKLAND, CA 94007

137,388.61 SF (3.15 ACRES)

ZONING DISTRICT:

ASSESSOR'S PARCEL #

ASSESSOR'S MAP 4, PAGE 51, PARCELS 18-1 AND 18-2 ASSESSOR'S MAP 4, PAGE 49, PARCEL 1 AND PIO PARCEL 3

HEIGHT AREA: GROUP USABLE OPEN SPACE PER UNIT: 160 FT (75 WITHIN 10' OF PRINCIPAL ST)

200 SF PER DWELLING UNIT

SETRACKS SIDE:

OFT MIN. - OFT MAX.

OFT

10 FT

REAR: BART:

20 FT TO TRACK EDGE

lowney arch

= \$20.6365400 = townsywich com

PROJECT NAME

500 Kirkham

PANORAMIC

INTERESTS 500 KIRKHAM ST, OAKLAND, CA

ARCHITECT

NOT FOR CONSTRUCTION

CONSULTANT

CONSULTANT STAMP

DATE ISSUES & REVISIONS BY 11/27/2017 DRC SUBMITTAL NG 02/09/2018 DRC SUBMITTAL NG



DRAWN BY: PROJECT NUMBER

SHEET ISSUE DATE:

11/27/11 SHEET TITLE

PROJECT INFORMATION

Author

SHEET NUMBER

BUILDING 1

TYPE IS

YES

112

BUILDING 1 GROSS AREA

AREA 30,152 SF

13,417 SF

30,200 SF 30,200 SF

30,200 SF

30,200 SF

30,200 SF

30,200 SF

254,969 SF

LONG TERM PROVIDED

110 SPACES

COMPLIANT

FLOOR

3

5

6

8

LONG TERM REQUIRED

83 SPACES (1 SPACE FOR EACH 4 DWELLINGS)

2 SPACES (1 SPACE FOR 12,000 SF FLOOR AREA)

TOTAL

BUILDING INFORMATION

NUMBER OF STORIES:

ALLOWABLE HEIGHT: 160' (75' WITHIN 10' OF 7TH ST)

PROPOSED HEIGHT: CONSTRUCTION TYPE

233 - 2" TYPE IA

23

BUILDING 3

SPRINKLERED: YES

OCCUPANCY CLASSIFICATION:

TOWER GROSS AREA

PROJECT NAME

500 Kirkham

lowney arch

PANORAMIC INTERESTS

500 KIRKHAM ST, CAKLAND, CA

ARCHITECT

NOT FOR CONSTRUCTION

CONSULTANT

CONSULTANT STAMP

DATE ISSUES & REVISIONS BY 11/27/2017 DRC SUBMITTAL NG 02/09/2018 DRC SUBMITTAL NG

PROJECT TRUE NORTH NORTH

DRAWN BY:

PROJECT NUMBER:

SHEET ISSUE DATE: SHEET TITLE:

PROJECT INFORMATION

Autho

17-000

11/27/1

SHEET NUMBER

BUILDING INFORMATION

NUMBER OF STORIES:

ALLOWARI F HEIGHT:

160' (75' WITHIN 10' OF 7TH ST)

BUILDING 2

PROPOSED HEIGHT: CONSTRUCTION TYPE:

TYPE IS

SPRINKLERED:

YES

OCCUPANCY CLASSIFICATION: R2

BLDG 2 - UNIT TYPES

BUILDING 2 GROSS AREA				
FLOOR	AREA			
1	28,238 SF			
M	12,767 SF			
2	28,238 SF			
3	28,238 SF			
4	28,238 SF			
5	28,238 SF			
6	28,238 SF			
7	28,238 SF			
OTAL	210,433 SF			

BLDG 3 - UNIT TO	PES
Name	Count
18R	73
299 SUITE	255
SER	22
48R	64
10 BEDROOM UNIT	22

	FLOOR	AREA	FLOOR	AREA
	1	25,366 SF	13	18,744 SF
	2	20,080 SF	14	18,744 SF
PES	3	20,080 SF	15	18,744 SF
Count	4	20,080 SF	16	18,744 SF
73	5	20,080 SF	17	18,744 SF
255	6	20,080 SF	18	18,744 SF
22	7	20,080 SF	19	18,744 SF
64	8	20,080 SF	20	18,744 SF
22	9	18,744 SF	21	18,744 SF
	10	18,744 SF	22	18,744 SF
	15	18,744 SF	23	18,744 SF
	12	18,744 SF	TOTAL	447,086 SF
	Count	1 2 3 5 5 5 5 5 5 5 5	1 25.366 SF 2 20,080 SF 2 20,080 SF 3 20,080 SF 5 20,080 SF 5 20,080 SF 25 8 20,080 SF 25 7 20,080 SF 22 7 20,080 SF 24 8 20,080 SF 25 9 18,744 SF 10 18,744 SF	1 25 366 SF 13 2 20,080 SF 14 3 20,080 SF 15 Count 4 20,080 SF 16 7 5 20,080 SF 17 285 8 20,080 SF 19 22 7 20,080 SF 19 4 8 20,080 SF 20 64 8 20,080 SF 20 18,744 SF 21 10 18,744 SF 22

TOWER GROSS AREA

BICYCLE PARKING INFORMATION

RESIDENTIAL

COMMERCIAL

BLDG 1 - UNIT TYPES

BUILDING INFORMATION

NUMBER OF STORIES:

ALLOWABLE HEIGHT:

CONSTRUCTION TYPE:

OCCUPANCY CLASSIFICATION:

SPRING FRED

BUILDING 1 PARKING INFORMATION						
	REQUIRED	PROVIDED	NOTES			
RESIDENTIAL	115	0 STALLS				
COMMERCIAL	0	8 STALLS	UNDER BART TRACKS			

17 SPACES (1 SPACE FOR EACH 20 DWELLINGS)

8 SPACES (1 SPACE FOR 2,000 SF FLOOR AREA)

SHORT TERM PROVIDED

T4 SPACES

8 SPACES

	REQUIRED	PROVIDED	NOTES
RESIDENTIAL	93	0 STALLS	
COMMERCIAL		OSTALLS	

	REQUIRED	PROVIDED	NOTES
RESIDENTIAL	93	OSTALLS	
COMMERCIAL	0	OSTALLS	

BICYCLE PARKI	NG INFORMATION				
	SHORT TERM REQUIRED	SHORT TERM PROVIDED	LONG TERM REQUIRED	LONG TERM PROVIDED	COMPLIANT
RESIDENTIAL	13 SPACES (1 SPACE FOR EACH 20 DWELLINGS)	104 SPACES	67 SPACES (1 SPACE FOR EACH 4 DWELLINGS)	80 SPACES	Y
	7 SPACES		2 504055		

	REQUIRED	PROVIDED	NOTES
RESIDENTIAL	153	0 STALLS	
COMMERCIAL	0	0 STALLS	

BICYCLE PARKING INFORMATION						
	SHORT TERM REQUIRED	SHORT TERM PROVIDED	LONG TERM REQUIRED	LONG TERM PROVIDED	COMPLIANT	
RESIDENTIAL	13 SPACES (1 SPACE FOR EACH 20 DWELLINGS)	104 SPACES	67 SPACES (1 SPACE FOR EACH 4 DWELLINGS)	80 SPACES	Y	
COMMERCIAL	7 SPACES (1 SPACE FOR 2,000 SF FLOOR AREA)	7 SPACES	2 SPACES (1 SPACE FOR 12,000 SF FLOOR AREA)	2 SPACES	Y	

BICYCLE PARKING INFORMATION SHORT TERM REQUIRED SHORT TERM PROVIDED LONG TERM REQUIRED LONG TERM PROVIDED COMPLIANT RESIDENTIAL 109 SPACES (1 SPACE FOR EACH 4 DWELLINGS) 109 SPACES Y 2 SPACES (1 SPACE FOR 12,000 SF FLOOR AREA) 8 SPACES (1 SPACE FOR 2,000 SF FLOOR AREA) Y



lowney arch

≈510 836 5400 **∞** sowreparch com

PROJECT NAME

500 Kirkham

PANORAMIC INTERESTS

500 KIRNHAM ST, OAKLAND, CA

ARCHITECT

CONSULTANT STAMP

DATE ISSUES & REVISIONS BY 11/2/12/17 DRC SUBMITTAL NG NG SUBMITTAL NG



DRAWN BY: PROJECT NUMBER: SHEET ISSUE DATE

EXISTING CONDITIONS

Author

17-007

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NUMBER CORRESPONDS TO IMAGE OF PROPERTY PROVIDED ON SHEETS GO.5 & GO.5







(2) 1430 7TH STREET



(3) 1380 7TH STREET



(8) 1260 7TH STREET



(4) 1320 TTH STREET



(7) 1240 7TH STREET



(8) 1160 7TH STREET

(5) 1300 7TH STREET



9 700 ADELINE STREET



500 Kirkham

PANORAMIC INTERESTS

500 KIRKHAM ST, OAKLAND, CA

ARCHITECT

CONSULTANT

CONSULTANT STAMP

DATE ISSUES & REVISIONS BY 11/27/2017 DRC SUBMITTAL ING 02/09/2018 DRC SUBMITTAL ING



PROJECT NUMBER:

SHEET ISSUE DATE: SHEET TITLE:

EXISTING CONDITIONS

10. PUBLIC ART OVER 7TH STREET



(11) 1451 7TH STREET



12-1395 7TH STREET



15 1225 TTH STREET



13 S33 KIRKHAM STREET

16 1207 7TH STREET



(17) 1155 7TH STREET

14 1225A 7TH STREET



18 1133 7TH STREET



PROJECT NAME

500 Kirkham

PANORAMIC **INTERESTS**

500 KIRKHAM ST, OAKLAND, CA

ARCHITECT

CONSULTANT

CONSULTANT STAMP

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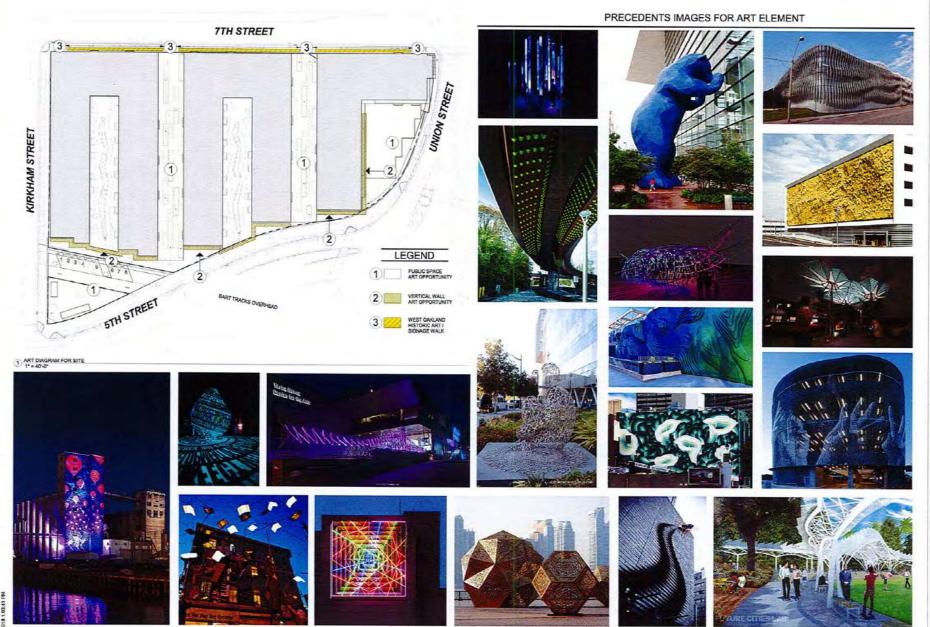
SHEET ISSUE DATE:

EXISTING CONDITIONS

Author 17-007

11/27/17





lowney arch

500 Kirkham

PANORAMIC INTERESTS

500 KIRKHAM ST, OAKLAND, CA

CONSULTANT

CONSULTANT STAMP

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SHEET ISSUE DATE: SHEET TITLE

PUBLIC ART ELEMENT

17-007

WEST OAKLAND HISTORIC ART / SIGNAGE WALK















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PANORAMIC INTERESTS

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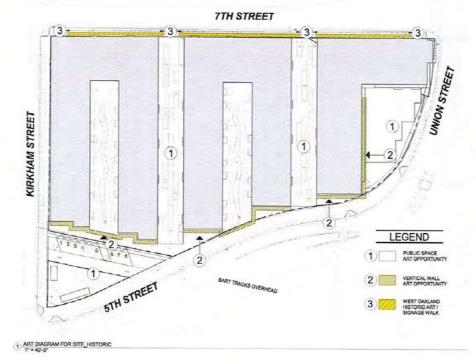




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SHEET TITLE

HISTORIC ART / SIGNAGE


























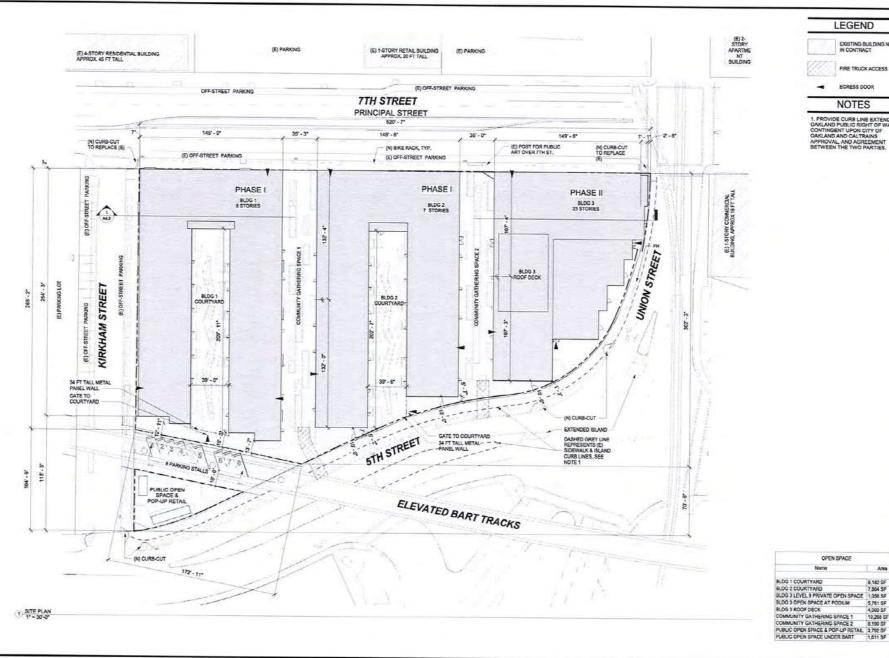

LEGEND



EGRESS DOOR

PROVIDE CURB LINE EXTENDING DAGLAND PUBLIC RIGHT OF WAY, CONTINGENT UPON CITY OF OAKLAND AND CALTRAINS APPROVAL, AND AGREEMENT BETWEEN THE TWO PARTIES.

EXISTING BUILDING NOT IN CONTRACT

NOTES

lowney arch

= 510.836.5400 = luwreparch.com

PROJECT NAME

500 Kirkham

PANORAMIC INTERESTS 500 KIRKHAM ST, CAKLAND, CA

ARCHITECT

NOT FOR CONSTRUCTION

CONSULTANT

CONSULTANT STAMP

:	DATE	ISSUES & REVISIONS	6
	11/27/2017	DRC SUBMITTAL	N
	02/09/2018	DRC SUBMITTAL	N
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PROJECT

DRAWN BY PROJECT NUMBER SHEET ISSUE DATE:

OPEN SPACE

10,298 SF

SITE PLAN

Author

17-007

11/23/17

SHEET NUMBER

G_{0.8}





















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PROJECT NAME

500 Kirkham

PANORAMIC INTERESTS

500 KIRKHAM ST, GAKLAND, CA



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PROJECT NUMBER:

SHEET ISSUE DATE: SHEET TITLE:

PUBLIC SPACE PRECEDENTS



lowney arch

PROJECT NAME

THE HUB

PANORAMIC INTERESTS

NOT FOR CONSTRUCTION



CONSULTANT STAMP

DATE ISSUES & REVISIONS BY

PROJECT TRUE NORTH NORTH

DRAWN BY: PROJECT NUMBER: SHEET ISSUE DATE

ILLUSTRATIVE

SITE PLAN

L1.00

CW, BW, LE

7TH ST 16 . 20-14 301 33 KIRKHAM STREET 25 27 p.

SITE LEGEND

ı CONCRETE PAVING, INTEGRAL COLOR CONC COLOR: PALAMINO

CONCRETE PAVING. INTEGRAL COLOR CONC COLOR: SILVERSMOKE FINISH: TOP CAST

3 MODULAR CONC UNIT PAVERS, MANUF: BELGARD COLOR: CHAMPAGNE FINISH: GROUND FACE

SIDEWALK, CITY STANDARD CONC

CONCRETE SITE WALL. COLOR: STANDARD CONC HEIGHT: VARIES, 20" MAX FINISH: MEDIUM SANDBLAST

6 NOT USED

7 BIORETENTION BASIN W METAL GRATE

CROSSOVERS

BIORIETENTION BASIN
W VEHICULAR METAL
GRATE LID

9 OVERHEAD PERGOLA STRUCTURE

10 CUSTOM SCULPTURAL OVERHEAD STRUCTURE

11 WOODEN BENCH SEATING

12 SHARED STOOP GATHERING SPACE

ENTRY PLAZA.
VEHICULAR RATED FOR FIRE TRUCK ACCESS

14 PLAZA

15 TREE GRATE

16 STREETSCAPE PLANTING

17 PLANTING AREA

18 LAWN

19 STREET TREE
Platecia chinerais

20 STREET TREE
Overtus Subar

21 STREET TREE Ginko biloba 'Saraloga

22 ADA CURB RAMP

23 DRIVE APRON

BIKE RACK

24 25 26 BART RAIL OVERHEAD

2 WIDE COURTESY

27 28 4" PASS THROUGH MODULAR RETAIL STRUCTURES

ANGLED PARKING

PARALLEL PARKING

29 30 31 32 REMOVABLE BOLLARDS PREVIOUS CURB

LOCATION 33 PROPERTY LINE

GENERAL NOTES:

ORIP IRRIGATION TO BE USED IN ALL LANDSCAPE AREAS
 ALL PLANTING AREAS TO INCLUDE 2" LAYER OF JIE"
 BLACK MINI-CHIP MULCH
 MODIFICATIONS TO THE MORTH CURB LINE AND TRAVEL

LANE WIDTH ON WESTBOUND 5TH STREET CONTINGENT UPON CITY OF OAKLAND AND CALTRANS APPROVALS, AND AGREEMENT SETWEEN THE AFOREMENTIONED PARTIES.

PLANT PALETTE





Western Sword Fern

SITE FURNISHING



OVERHEAD PERGOLA STRUCTURE



METAL GRATE CROSSOVER

STREETSCAPE PLANT PALETTE



Lomandra longifolia 'Breeze' 'Breeze' Dwarf Mat Rush 5 Gal



Cork Clek 36" Box



PAVING LAYOUT



BIORETENTION BASIN W METAL GRATE

lowney

= 510 834 5400 - Towns

PROJECT NAME

THE HUB

PANORAMIC INTERESTS

500 KIRKHAM ST. OAKLAND CA

ARCHITECT

NOT FOR CONSTRUCTION



CONSULTANT STAMP

ISSUES L'REVISIONS BY

PROJECT TRUE MORTH NORTH


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SHEET TITLE: **BUILDING 1** COURTYARD PLAN


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17-004



NTS 🖔

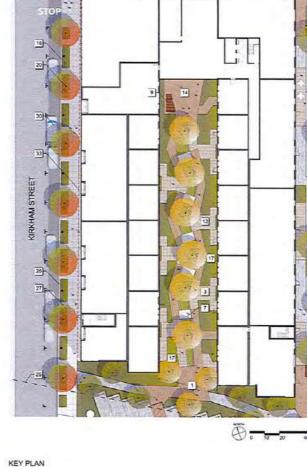

SITE LEGEND

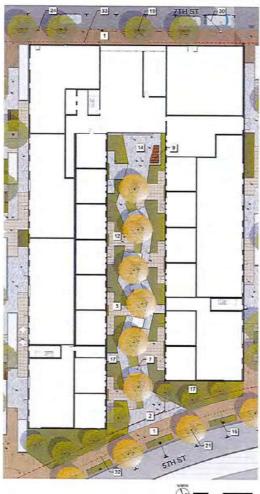CONCRETE PAVING, INTEGRAL COLOR CONC COLOR: PALAMINO FINISH: TOP CAST



CONCRETE PAVING, INTEGRAL COLOR CONC COLOR: SILVERSMOKE FINISH TOP CAST



MODULAR CONC UNIT PAVERS, MANUF: BELGARD COLOR: CHAMPAGNE FINISH: GROUND FACE



SIDEWALK, CITY STANDARD CONC

CONCRETE SITE WALL, COLOR: STANDARD CONC HEIGHT: VARIES, 20" MAX FINISH: MEDIUM SANDBLAST

6 NOT USED

7 BIORETENTION BASIN w/ METAL GRATE CROSSOVERS

3 BIORETENTION BASIN w/ VEHICLILAR METAL GRATE LID

9 OVERHEAD PERGOLA STRUCTURE

CUSTOM SCULPTURAL OVERHEAD STRUCTURE

11 WOODEN BENCH SEATING

12 SHARED STOOP GATHERING SPACE

ENTRY PLAZA VEHICULAR RATED FOR FIRE TRUCK ACCESS

14 PLAZA

15 TREE GRATE

STREETSCAPE PLANTING

17 PLANTING AREA

18 LAWN

19 STREET TREE
Pletage chiners

20 STREET TREE Quercus Suber

STREET TREE Ginko biloba 'Saratoga' 21

22 ADA GURB RAMP

23 DRIVE APRON

24 BIKE RACK 25 BART RAIL OVERHEAD

26 2 WIDE COURTESY STRIP 27 4 PASS THROUGH
28 MODULAR RETAIL STRUCTURES

29 ANGLED PARKING 30 PARALLEL PARKING

31 REMOVABLE BOLLARDS 32 PREVIOUS CURB LOCATION

33 PROPERTY LINE

GENERAL NOTES:

DRIP PRRIGATION TO BE USED IN ALL LANDSCAPE AREAS
2 ALL PLANTING APEAS TO INCLUDE IT LAYER OF SIF
SEACK MINE-OHIP MULCH
3. MODIFICATIONS TO THE NORTH OURB LINE AND TRAVEL
LANE WIGHT ON WESTBOUND STHE STREET CONTINGENT
UPON CITY OF OMILAND AND CALTRAVIS APPROVALS. AND
ARREMENT ENTREET THE APPORTMENT OF MATTER
ARE CONTINUED THE PROPER THE AND CHEMICIPATION PRATTER.

PLANT PALETTE









SITE FURNISHING



OVERHEAD PERSOLA STRUCTURE



PLANTING IN BIORETENTION BASIN





Chandra Cape Rush 5 Gai



PAVING LAYOUT



BIORETENTION BASIN WI METAL GRATE



■ 510-836 5400 • townsyst

PROJECT NAME

THE HUB

PANORAMIC **INTERESTS**

500 KIRKHAM ST, DAKLAND, CA

ARCHITECT

NOT FOR CONSTRUCTION



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DATE ISSUES & REVISIONS BY

PROJECT TRUE NORTH NORTH

DRAINN BY PROJECT NUMBER SHEET ISSUE DATE:

SHEET TITLE **BUILDING 2** COURTYARD PLAN

SHEET NUMBER


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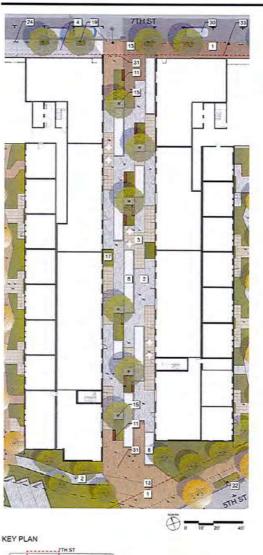
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52/09/18



KEY PLAN



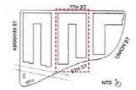

SITE LEGEND

CONCRETE PAVING, INTEGRAL COLOR CONC 1 COLOR: PALAMINO FINISH: TOP CAST

CONCRETE PAVING. INTEGRAL COLOR CONC COLOR: SILVERSMOKE FINISH: TOP CAST

MODULAR CONC UNIT PAVERS, MANUF BELGARD COLOR: CHAMPAGNE FINISH: GROUND FACE

4 SIDEWALK, CITY STANDARD CONC

CONCRETE SITE WALL, COLOR: STANDARD CONC HEIGHT: VARIES 20" MAX FINISH: MEDIUM SANDGLAST

6 NOT USED

7 BIORETENTION BASIN METAL GRATE CROSSOVERS

BIORETENTION BASIN w/ VEHICULAR METAL GRATE LID

9 OVERHEAD PERGOLA STRUCTURE

10 CUSTOM SCULPTURAL

11 WOODEN BENCH SEATING

12 SHARED STOOP GATHERING SPACE

13 ENTRY PLAZA, VEHICULAR RATED FOR FIRE TRUCK ACCESS

14 PLAZA

TREE GRATE Betula jacquemon 15

16 STREETSCAPE PLANTING

17 PLANTING AREA

18 LAWN

19 STREET TREE

STREET TREE Overcus Suber 20

21 STREET TREE Ginko bilobe 'Saratoga'

22 ADA CURB RAMP

23 DRIVE APRON

24 BIKE RACK BART RAIL OVERHEAD

26 2 WIDE COURTESY

27 4" PASS THROUGH

28 MODULAR RETAIL

STRUCTURES ANGLED PARKING

29 30 PARALLEL PARKING

31 REMOVABLE BOLLARDS

32 PREVIOUS CURB LOCATION

33 PROPERTY LINE

GENERAL NOTES:

1. DRIP IRRIGATION TO BE USED IN ALL LANDSCAPE AREAS 2. ALL PLANTING AREAS TO INCLUDE 3" LAYER OF 3/8" BLACK MINI-CHIP MULICH

BLACK MINI-CHE MULCH

3. MODIFICATIONS TO THE NORTH GURB LINE AND TRAVEL
LANE WIDTH ON WESTBOUND STHISTREET CONTINGENT
LIPON GITY OF GARLAND AND CALTRANS APPROVALS, AND
AGREEMENT BETWEEN THE APPRECIATIONED PRIFTIES.

PLANT PALETTE



Platarus acerfolis 'Bloodgood' London Plane Tree 36' Box



Carex divulsa

SITE FURNISHING



FLEXIBLE SEATING AT TREE GRATE





Podocarpus herikelii Long Leafed Yellow-wood



METAL GRATE LID AT BIORETENTION BASIN



lowney

= 510 536 5400 = teamporth.com

PROJECT NAME

THE HUB

PANORAMIC INTERESTS

500 KIRKHAMI ST, CAKLAND, CA

ARCHITECT

NOT FOR CONSTRUCTION



CONSULTANT STAMP

DATE ISSUES A REVISIONS BY

DRAWN BY PROJECT NUMBER: SHEET ISSUE DATE: SHEET TITLE:

COMMUNITY GATHERING SPACE 1 PLAN


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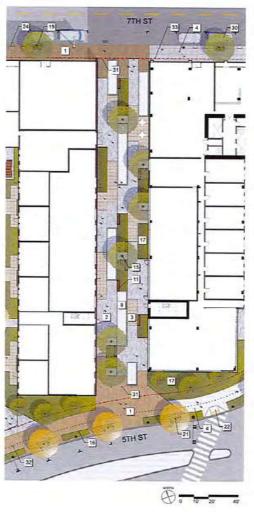
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17-004

02/09/18



NTS &

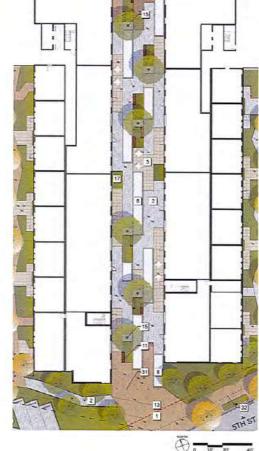

KEY PLAN

SITE LEGEND



ONCRETE PAVING, INTEGRAL COLOR CONC COLOR PALAMINO FINISH: TOP CAST



2 CONCRETE PAVING. INTEGRAL COLOR CONC COLOR: SILVERSMOKE FINISH: TOP CAST



3 MODULAR CONC UNIT PAVERS, MANUF: BELGARD COLOR: CHAMPAGNE FINISH: GROUND FACE



5 CONCRETE SITE WALL, COLOR: STANDARD CONC HEIGHT: VARIES, 20" MAX FINISH: MEDIUM SANDBLAST





BIORETENTION BASIN W VEHICULAR METAL GRATE LID

9 OVERHEAD PERGOLA STRUCTURE

10 CUSTOM SCULPTURAL OVERHEAD STRUCTURE

11 WOODEN BENCH SEATING

12 SHARED STOOP GATHERING SPACE

ENTRY PLAZA, VEHICULAR RATED FOR FIRE TRUCK ACCESS

14 PLAZA

15 TREE GRATE Betuta jacquementi

16 STREETSCAPE PLANTING

17 PLANTING AREA

18 LAWN

19 STREET TREE
Platacia chinessis

20 STREET TREE Overtus Suber

31 STREET TREE Ginko biloba 'Saratoga

22 ADA CURB RAMP

23 DRIVE APRON

24 BIKE RACK 25 BART RAIL OVERHEAD 26 2' WIDE COURTESY STRIP

4' PASS THROUGH

28 MODULAR RETAIL STRUCTURES

ANGLED PARKING PARALLEL PARKING

REMOVABLE BOLLARDS 32 PREVIOUS CURB LOCATION

33 PROPERTY LINE

GENERAL NOTES:

1. DRP PROGRED TO BE USED IN ALL LANDSCAPE AREAS 2. ALL PLANTING AREAS TO INCLUDE IT LAYER OF 38* BLACK MINI-OHP MULCH .

3. MODIFICATIONS TO THE MORTH CURB LINE AND TRAVEL LINE WIGHT ON WESTBOUND STH STREET CONTINUENT UPON CITY OF CANLAND AND CALTRANS APPROVAL, AND ARREAMENT BETWEEN THE AFOREMENT HORD PARTIES.

PLANT PALETTE





Platanus acertolia 'Bloodgood' London Plane Tree 36' Box





SITE FURNISHING



WOODEN BENCH SEATING



TREE GRATE





Podocarpus henkelii Long Leefed Yellow-wood 15 Gal



COMMUNITY GATHERING SPACE

lowney arch

PROJECT NAME

THE HUB

PANORAMIC INTERESTS

500 KIRKHAM ST, GARLAND, CA

ARCHITECT

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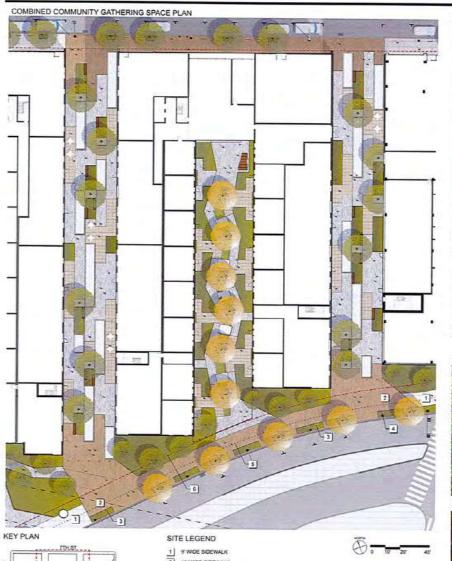
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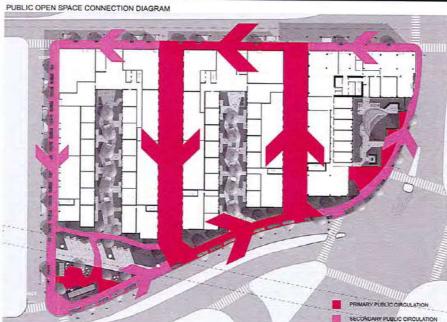
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> COMMUNITY **GATHERING** SPACE 2 PLAN

CW. BW. LE

17-604





PUBLIC OPEN SPACE PRECEDENTS







- 2 11 WIDE SIDEWALK
- 3 4 WIDE STREETSCAPE PLANTING BUFFER
- 5-6" WIDE STREETSCAPE PLANTING BUFFER
- 5 PREVIOUS CURB LOCATION
- 6 PROPERTY LINE

NTS TO

GENERAL NOTES:

- GENERAL INVIICS.

 1. DRP IRRIGATION TO BE USED IN ALL LANDSCAPE AREAS

 2. ALL PLANTING AREAS TO INCLUDE 3" LAYER OF 36"

 2. MAD WING-CIPP MILCO!

 3. MODIFICATIONS TO THE MORTH CURB LINE AND TRAVEL

 LANE WIDTH ON WESTBOUND STHISTREET CONTINUENT

 LANE WIDTH ON WESTBOUND STHISTREET CONTINUENT

 LANE WIDTH ON WESTBOUND STHISTREET CONTINUENT

 LANE WIDTH THE APPORTMENTIONED PRATIES.





UNION SQUARE - WINTER WALK SE

lowney

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PROJECT NAME

THE HUB

PANORAMIC INTERESTS 500 KIRKHAM ST, DAKLAND, CA

ARCHITECT

NOT FOR CONSTRUCTION



CONSULTANT STAMP

DATE ISSUES & REVISIONS BY


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SHEET TITLE COMMUNITY GATHERING


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CW, BW, LE



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GENERAL NOTES:

DRIP IRRIGATION TO SE USED IN ALL LANDSCAPE AREAS
 ALL PLANTING AREAS TO INCLUDE 3" LAYER OF 3/8"
 BLACK MINI-CHIP MULCH

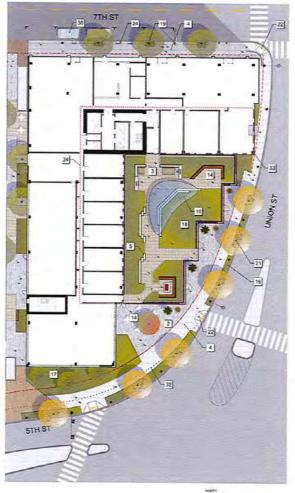BLACK MINI-CHIP MULCH

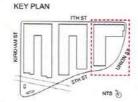2. MODIFICATIONS TO THE NORTH GURS LINE AND TRAVEL

LANE WIDTH ON WESTBOUND STM STREET CONTINGENT

UPON CITY OF CARLAND AND CALTRANS APPROVALS, AND

AGREEMENT BETWEEN THE APPREMENTIONED PARTIES.

SITE LEGEND



ONCRETE PAVING.
INTEGRAL COLOR CONC
COLOR: PALAMINO
FINISH: TOP CAST



2 CONCRETE PAVING, INTEGRAL COLOR CONC COLOR: SILVERSMOKE FINISH: TOP CAST



3 MODULAR CONC UNIT PAVERS, MANUF BELGARD COLOR CHAMPAGNE FINISH GROUND FACE



5 CONCRETE SITE WALL COLOR: STANDARD CONC HEIGHT: WARIES, 20' MAX FINISH: MEDILM SANDBLAST



7 BIORETENTION BASIN W METAL GRATE CROSSOVERS

BIORETENTION BASIN W VEHICULAR METAL GRATE LID

9 OVERHEAD PERSOLA STRUCTURE

0 CUSTOM SCULPTURAL OVERHEAD STRUCTURE

11 WOODEN BENCH SEATING

12 SHARED STOOP GATHERING SPACE

ENTRY PLAZA.

VEHICULAR RATED FOR FIRE TRUCK ACCESS

14 PLAZA

15 TREE GRATE
Betula jacquemontii

16 STREETSCAPE PLANTING

17 PLANTING AREA

18 LAWN

19 STREET TREE
Pistacia chinenso

20 STREET TREE Quartus Subar

21 STREET TREE Ginko bloba 'Saratog

22 ADA CURS RAMP

23 DRIVE APRON 24 BIKE RACK

26 BART RAIL OVERHEAD
26 Z WIDE COURTESY
STRIP

27 4 PASS THROUGH 28 MODULAR RETAIL STRUCTURES

51HUCTURES

29 ANGLED PARKING

30 PARALLEL PARKING

REMOVABLE BOLLARDS
PREVIOUS CURB
LOCATION

33 PROPERTY LINE

34 SECOND FLOOR ARCHITECTURE AS SHOWN

PLANT PALETTE



Querous suber Cork Oak 36" Box



Adenanthos sericeus Coastal Wolly Bush 15 Gwl

SITE FURNISHING



SEMI-PRIVATE COURTYARD



CONCRETE SEATWALL

STREETSCAPE PLANT PALETTE



Dietes grandiflora Fortnight Lify 5 Gal



Ginko biloba "Saratoga" Maldine Hair tree 36" Box



OUTDOOR LAWN



SCULPTURAL OVERHEAD

lowney arch

≈ \$10 EM \$400 → lowreywork.com

PROJECT NAME

THE HUB

PANORAMIC INTERESTS

500 KIRKHAM ST, GAKLAND, CA

ARCHITECT

NOT FOR CONSTRUCTION



CONSULTANT STAMP

DATE ISSUES & REVISIONS BY

PROJECT TRUE NORTH NORTH

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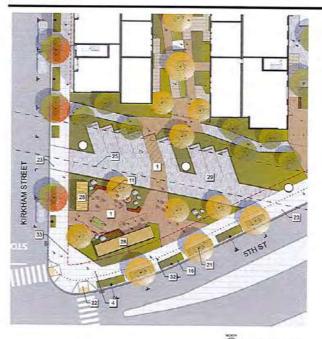
BUILDING 3
PUBLIC OPEN
SPACE PLAN

SHEET NUMBER

14.00

CIV. BW. LE

02/09/18



SITE LEGEND



CONCRETE PAVING.
INTEGRAL COLOR CONC
COLOR: PALAMINO
FINISH: TOP CAST

2 CONCRETE PAVING. INTEGRAL COLOR CONC COLOR: SILVERSMOKE FINISH: TOP CAST



MODULAR CONC UNIT PAVERS, MANUF BELGARD COLOR: CHAMPAGNE FINISH: GROUND FACE

4 SIDEWALK, CITY STANDARD CONC

5 CONCRETE SITE WALL COLOR: STANDARD CONC HEIGHT: VARIES, 20' MAX FINISH: MEDIUM SANDBLAST

6 NOT USED

7 BIORETENTION BASIN W/METAL GRATE CROSSOVERS

BIORETENTION BASIN W VEHICULAR METAL GRATE LID

9 OVERHEAD PERSOLA STRUCTURE

10 CUSTOM SCULPTURAL OVERHEAD STRUCTURE

11 WOODEN BENCH SEATING

5HARED STOOP GATHERING SPACE

13 ENTRY PLAZA VEHICULAR RATED FOR FIRE TRUCK ACCESS

14 PLAZA

15 TREE ORATE

16 STREETSCAPE

17 PLANTING AREA

18 LAWN

19 STREET TREE

20 STREET TREE

21 STREET TREE

22 ADA CURS RAMP

23 DRIVE APRON

24 BIKE RACK
25 BART RAIL OVERMEAD

26 2' WIDE COURTESY STRIP

27 4 PASS THROUGH

28 MODULAR RETAIL STRUCTURES

29 ANGLED PARKING 30 PARALLEL PARKING

31 REMOVABLE BOLLARDS

PREVIOUS CURB LOCATION

33 PROPERTY LINE

GENERAL NOTES:

BRIP IPRIGATION TO BE USED IN ALL LANDSCAPE AREAS 2. ALL PLANTING AREAS TO INCLUDE 3° LAYER OF 38° 58 JACK MIN-CHIP MILCH.
 MODIFICATIONS TO THE MORTH CLIPB LINE AND TRAVEL LANE WIDTH ON WESTBOUND STHISTINGT CONTINUENT LIPON CITY OF CHARAND AND CALTRANS APPROVINCE, AND ACRELIENT DETWEEN THE AF ORDEWESTHOSE PRATTES.

PLANT PALETTE



Cordyline australis Cabbage Tree

Aecrium arboreum 'Zwartkop' Stack Rose Aecrium 5 Gal

SITE FURNISHING







Agave Attenuals 'Nove' Fox Tall Agave





Padde Plant 5 Gal



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OUTDOOR MODULAR SEATING



UNDERPASS PROGRAMMING

MODULAR RETAIL SPACE



UNDERPASS ART

DRAWN BY PROJECT NUMBER SHEET ISSUE DATE SHEET TITLE:

PUBLIC OPEN SPACE AND POP-UP RETAIL PLAN

SHEET NUMBER

L4.01

CW, BW, LE


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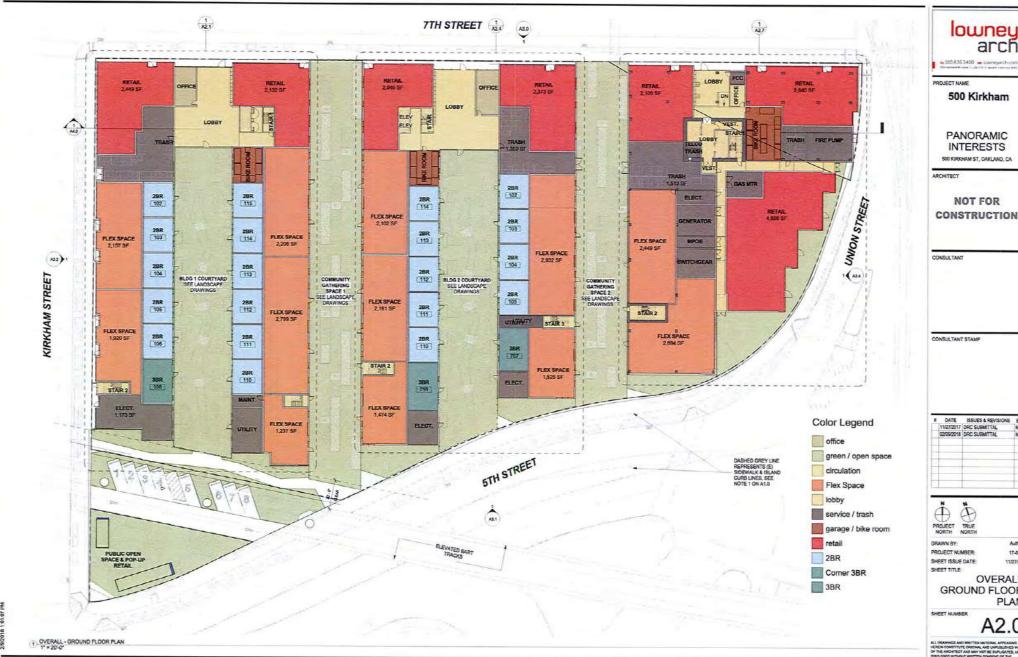
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NTS TO

KEY PLAN





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OVERALL GROUND FLOOR PLAN

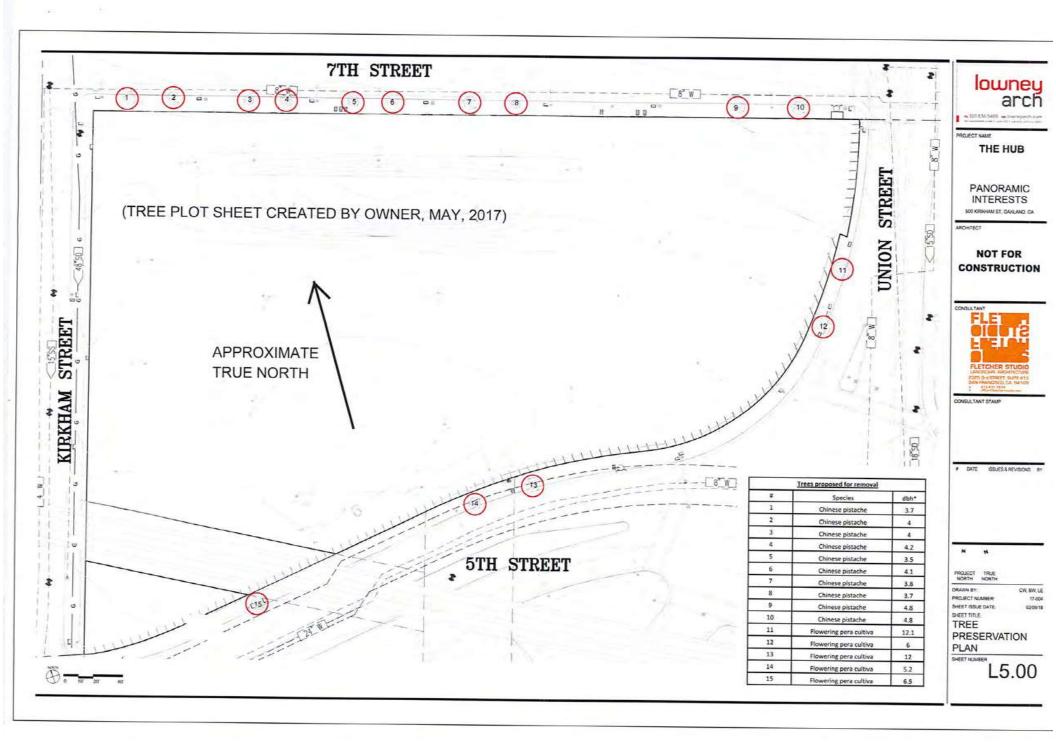Author

17-007

A2.0



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PROJECT NUMBER:


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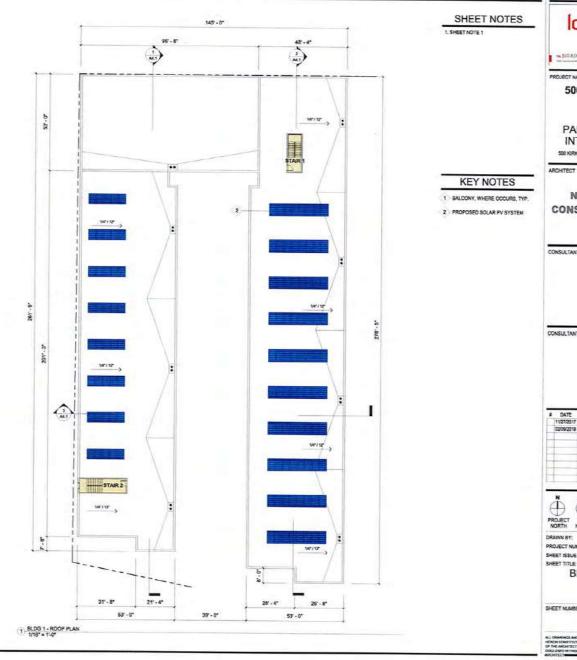
BLDG 1 LEVELS 1 & M FLOOR **PLANS**

Author

17-007

11/27/17



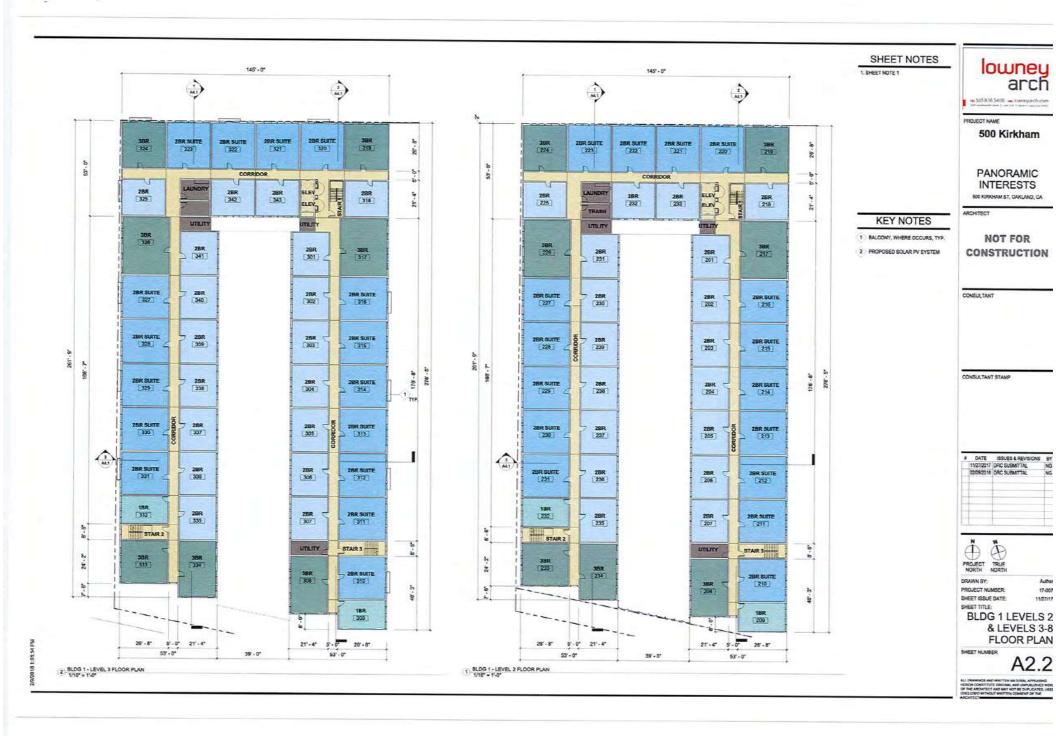

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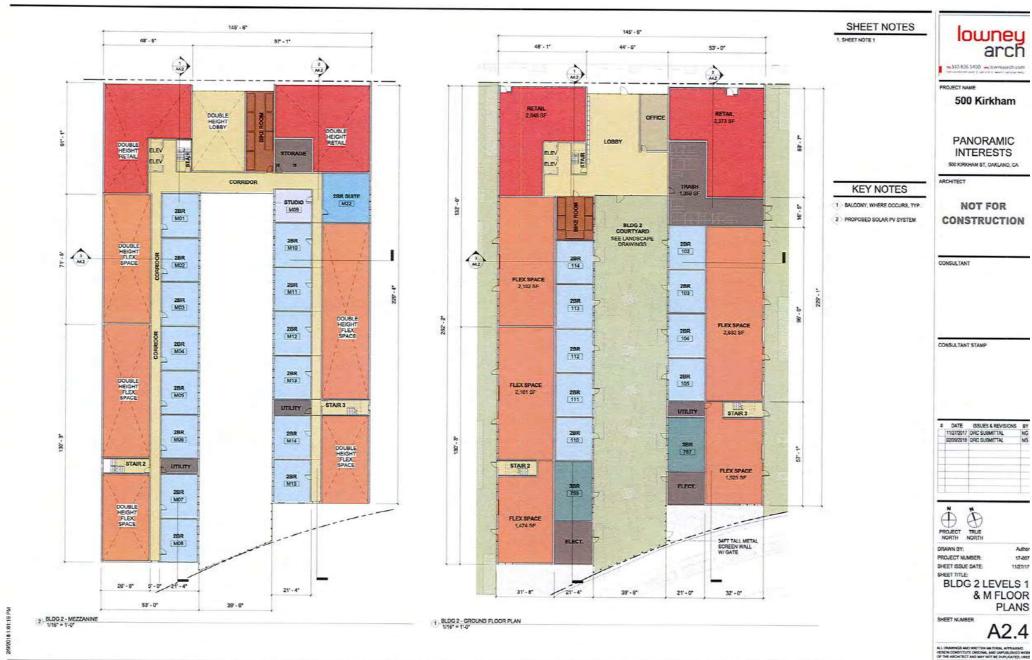
BLDG 1 ROOF PLAN


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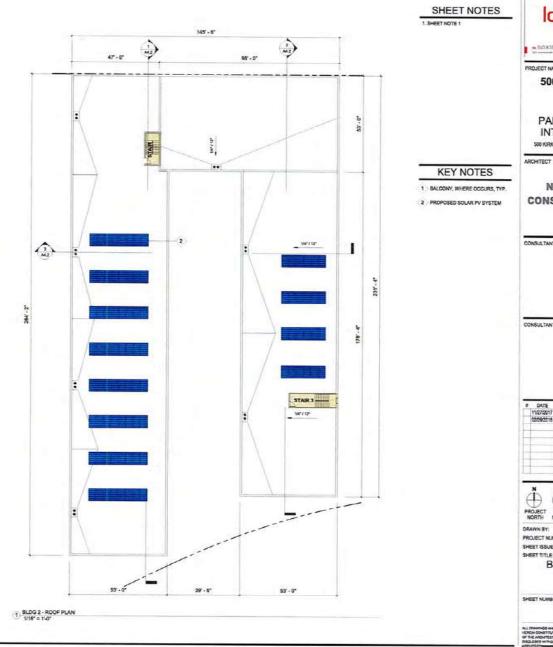
BLDG 2 LEVEL 2 &

LEVELS 3-7 FLOOR PLAN

A2.5

Author

17-007

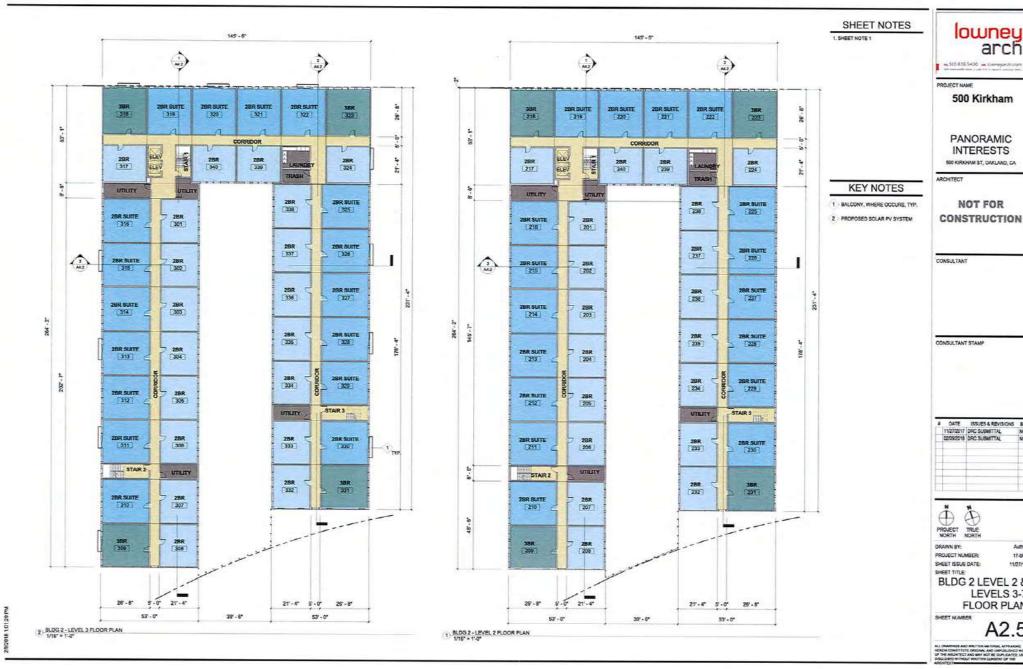

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PROJECT NAME

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PANORAMIC INTERESTS 500 KIRKHAM ST, DAKLAND, CA

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PROJECT NUMBER:

SHEET ISSUE DATE: SHEET TITLE

BLDG 2 ROOF PLAN

A2.6

Author

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17-007



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PROJECT NUMBER:

BLDG 3 LEVEL 3-23 TYP & ROOF

17-007

11/27/17

PLAN

WF1 WINDOW FRAMES CLEAR ANODIZED ALUMINUM



SFI CHARCOAL STOREFRONT BALCONY PANEL





METAL CLADDING FIELD COLOR



CEMENT FIBER PANEL FIELD COLOR



CEMENT FIBER PANEL ACCENT COLOR



CP1 FIBER CEMENT PANEL FIELD COLOR - ALTERNATIVE: EIFS

CP2 FIBER CEMENT PANEL ACCENT COLOR - ALTERNATIVE: EIFS

CP3 FIBER CEMENT PANEL ACCENT COLOR - ALTERNATIVE: EIPS

SF1) STOREFRONT

WF1 WINDOW FRAME

BP1 BALCONY PANEL

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INTERESTS

500 KIRKHAM ST, OAKLAND, CA

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ARCHITECT

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PROJECT NORTH DRAWN BY:

PROJECT NUMBER: SHEET ISSUE DATE:

SHEET TITLE OVERALL EXT.

ELEVATION NORTH

Author

17-007

11/27/17

SHEET NUMBER

A3.0





WFI WINDOW FRAMES CLEAR ANODIZED ALUMINUM



SFI CHARCOAL STOREFRONT



CEMENT FIBER PANEL ACCENT COLOR



BALCONY PANEL



METAL CLADDING FIELD COLOR



CEMENT FIBER PANEL FIELD COLOR



CEMENT FIBER PANEL ACCENT COLOR





CPZ FIBER CEMENT PANEL ACCENT COLOR - ALTERNATIVE: EIFS

CP3 FIBER CEMENT PANEL ACCENT COLOR - ALTERNATIVE: EIFS

SF1 STOREFRONT

WF1 WINDOW FRAME

BP1 BALCONY PANEL

lowney

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PROJECT NAME

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PANORAMIC INTERESTS 500 KIRKHAM ST, DAKLAND, CA

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11/27/17 OVERALL EXT.

ELEVATIONS SOUTH

Author

17-007

SHEET NUMBER

A3.1



MATERIAL LEGEND

MC1 METAL CLASSING

CP1 FIBER CEMENT PANEL FIELD COLOR - ALTERNATIVE: EIFS

CP2 FIBER CEMENT PANEL ACCENT COLOR - ALTERNATIVE: EIFS

CP3 FIBER CEMENT PANEL ACCENT COLOR - ALTERNATIVE EIPS

SF1 STOREFRONT

WF1 WINDOW FRAME

BP1 BALCONY PANEL

lowney arch

w 510 836 5400 w lowneys chican

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INTERESTS 500 KIRKHAM ST, QAKLAND, CA

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PROJECT TRUE NORTH

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PROJECT NUMBER: SHEET ISSUE DATE:

SHEET TITLE

OVERALL EXT. **ELEVATION** -WEST

A3.2

Author

17-007

SHEET NUMBER



OVERALL - EXTERIOR ELEVATION - WEST



MATERIAL LEGEND

MC1 METAL CLADDING

CP1 FIBER CEMENT PANEL FIELD COLOR - ALTERNATIVE BIFS

CPZ FIBER CEMENT PANEL ACCENT COLOR - ALTERNATIVE: EIFS

CP3 FIBER CEMENT PANEL ACCENT COLOR - ALTERNATIVE: EIFS

SF1 STOREFRONT

WF1 WINDOW FRAME

BP1 BALCONY PANEL

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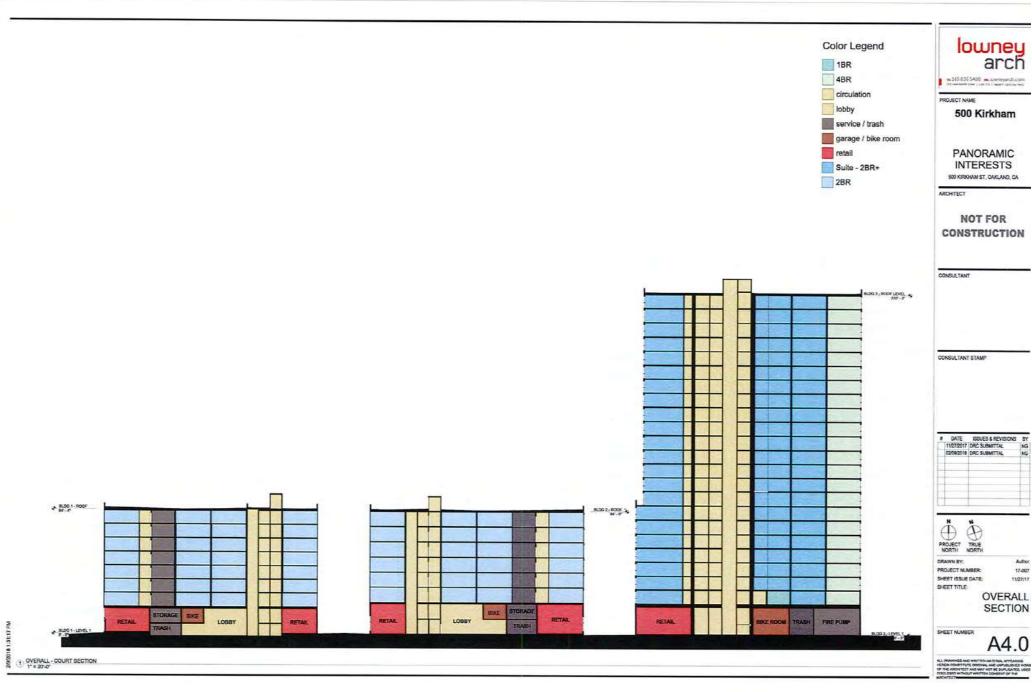
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OVERALL EXT. **ELEVATION** EAST

SHEET NUMBER

A3.4

11/27/17



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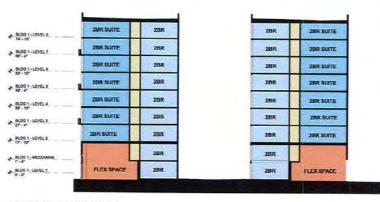
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OVERALL


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17-007

11/27/17



(3) BUILDING 1 - SECTION THROUGH COURT

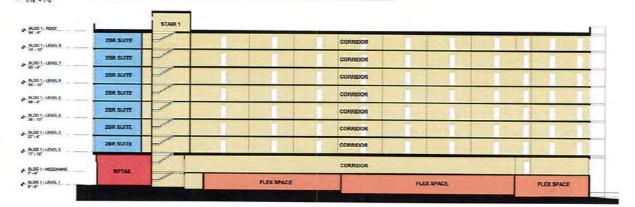

(2) BUILDING 1 - SECTION THROUGH FLEX SPACE IN ALLEY 1/19" = 1'-0"

-LEVEL 1	RETAIL		TRASH	2BR	2BR	28R	28R	28R	38R	ELEC
- MEZZANNE		STORAGE	2BR	2BR	28R	28R	28R	2BR	28R	38R
revers	2BR SUITE	JAUNOR	2BR	28R	2BR	ZBR	28R	28R	28R	38R
- LEVEL 3	2BR SUITE	AUNDRY	28R	28R	28R	28R	28R	28R	2BR	JAR
- LEVEL 4	28R SUITE	AUNDRY	2BR	2BR	28R	28R	2BR	28R	2BR	38R
-LOVEL 5	2BR SUITE	AUNDRY	28R	28R	28R	28R	2BR	28R	28R	38R
-LEVEL 0	28R SUITE	JALINDRY	2SR	2BR	29R	2BR	2BR	2BR	28R	38R
- LEVEL T	2BR SUITE	AUNDRY	28R	2BR	28R	2BR	2BR	2BR	28R	38R
- LEVEL 8	2BR SUITE	ALINDRY	28R	2BR	28R	2BR	28R	2BR	28R	3BR
1-R00F							_	_		

1) BLOG 1 - LONGITUDINAL SECTION THROUGH UNITS NEAR KIRKHAM

lowney arch

■ 555 836 5400 → correywich com

PROJECT NAME

500 Kirkham

PANORAMIC **INTERESTS**

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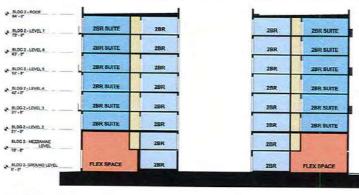
SHEET TITLE

BLDG 1 BUILDING SECTIONS


SHEET NUMBER

A4.1

Author



(3) BUILDING 2 - SECTION THROUGH COURT

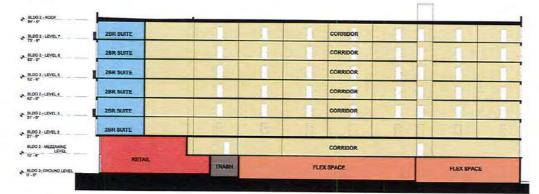

(2) BUILDING 2 - SECTION THROUGH FLEX SPACE & CORRIDOR @ UNITS 1/18" = 1'-0"

E-5.									_	
DG 2 - LEVEL T	28R SUITE		28R	28R	28R	29R	ZBR	2BR	28R	29R
DO 2 - LEVEL 8	28R SUITE		28R	28R	28R	28R	28R	2BR	2BR	28R
DG 2 - LEVEL 4	28R SUITE		2BR	28R	28R	28R	28R	28R	2BR	2BR
GZ-LEVEL4	28R SUITE	-51	28R	28R	28R	2SR	2BR	28R	28R	28R
G2-LEVEL)	29R SUITE		28R	28R	2BR	2BR	ZBR	2BR	28R	28R
63-TENETS	28R SUITE		2BR	28R	28R	2BR	2BR	2BR	2BR	2BR
G2 - MEZZANNE LEVEL	RETAIL	H	25R	2BR	28R	2BR	2BR	28R	28R	2BR
C 3- CROUND LEVEL	No.	K	BIKE ROOM	2BR	28R	2BR	ZBR	2BR	38R	ELECT.

1) BUILDING 2 - SECTION THROUGH UNITS

lowney arch

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PROJECT NAME

500 Kirkham

PANORAMIC INTERESTS

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PROJECT NUMBER:

SHEET ISSUE DATE: 1127/17
SHEET TITLE:
BLDG 2 BUILDING SECTIONS

17-007

4BR	28R SUITE	2BR SUITE	1BR	2BR SUITE	4BR	****
4BR	25R SUITE	2BR SUITE	1BR	2BR SUITE	4BR	BLDG 3 - LEVEL
488	28R SUITE	2BR SUITE	18R	2BR SUITE		\$120 3 - FEVER
				28K SUITE	4BR	BLDG 3 - LEVEL
48R	2BR SUITE	28R SUITE	1BR	2BR SUITE	4BR	8L003-LEVEL 1947-
48R	2BR SUITE	28R SUITE	1BR	2BR SUITE	48R	BLDG 3 - LEVEL
4BR	28R SUITE	28R SUITE	188	2BR SUITE	48R	8L003 - LEVEL
48R	2BR SUITE	2SR SUITE	1BR	2BR SUITE	48R	
4BR	28R SUITE	2BR SUITE	1BR	2BR SUITE	48R	BLDG 3 - LEVEL stor -
4BR	2BR SUITE	28R SUITE	1BR	28R SUITE	48R	BLOG 3 - LEVEL 1887 -
46R	28R SUITE	28R SUITE	1BR			BLDC 3 - LEVEL MF -
				2BR SUITE	48R	BLOG 3 - LEVEL 138 -
4BR	29R SUITE	2BR SUITE	1BR	2BR SUITE	48R	ILDG3 - LEVEL
4BR	28R SUITE	28R SUITE	1BR	28R SUITE	4BR	BLDG 7 - LEVEL
4BR	2BR SUITE	28R SUITE	1BR	2BR SUITE	4BR	NLDG 3 - LEVEL
4BR	2BR SUITE	28R SUITE	1BR	28R SUITE	4BR	BL003 - UDVEL SP - 1
48R	2BR SUITE	28R SUITE	18R	2BR SUITE	4BR	3000-000
45R	2BR SUITE	28R SUITE	18R	1BR	48R	
4BR	2BR SUITE	28R SUITE	1BR	1BR	48R	RIDGS-LEVEL
48R	28R SUITE	28R SUITE	18R	1BR	700-0	BLDG 3 - LEVEL BF - 1
	The State of				48R	BLDG3-LEVEL
4BR	2BR SUITE	28R SUITE	1BR	1BR	4BR	BLD93-LEVEL
4BR	2SR SUITE	2BR SUITE	1BR	1BR	4BR	BLD03 - LEVEL 38 - 1
48R	28R SUITE	28R SUITE	1BR	1BR	4BR	9.093+LEVEL 30*-
2BR SUITE	1BR 18	SR ZBR SU	TE 19	BR 2BR SUTT	E 387	BLDG 3 - LEVEL
1211				100.3		77.
RETAIL	LOSS	SY OFFICE		RETAIL		

5LDG.3 - ROOF LEVE 237 - 2	10 BEDROOM		and the second	CONTRACTOR OF THE PARTY OF THE	Company of the Compan	28R SUITE	2BR SUITE	48R
BLDKI 3 - LEVEL 2	UNIT	ALC: UNKNOWN	2BR SUITE	28R SUITE	28R SUITE	28R SUITE	ZBR SUITE	488
20.0	10 BEDROOM UNIT		25R SUITE	2BR SUITE	28R SUITE	28R SUITE	28R SUITE	4BR
BLDG 3 - LEVEL 2	10 BEDROOM		THE PERSON NAMED IN	28R SUITE	28R SUITE	2BR SUITE	298 SUITE	4BR
8109 3 - LEVEL 2	UNIT		28R SUITE	ZBR SUITE	2BR SOLIE	25KGUITE	20K GUITE	400.
SLOG 3 LEVEL 3	10 BEDROOM UNIT		2BR SUITE	2BR SUITE	2BR SUITE	28R SUITE	28R SUITE	48R
92.11	10 BEDROOM UNIT		2BR SUITE	2BR SUITE	2BR SUITE	2BR SUITE	28R SUITE	4BR
BLOG 3 - LEVEL 1	10 BEDROOM							
	UNIT	-	ZBR SUITE	2BR SUITE	ZBR SUITE	2BR SUITE	28R SUITE	4BR
BLDG 3 - LEVEL 1	10 SEDROOM			1			The Principal of	
8003.10m	UNIT	Pro-	2BR SUITE	2BR SUITE	2BR SUITE	2BR SUITE	2BR SUITE	4BR
BLDG 5 - LEVEL 5	10 BEDROOM		Towns or the	Salara Maria	1000	Annual Control	-	4BR
9LDG 3 - LEVEL 1	UNIT	hom	28R SUITE	2BR SUITE	2BR SUITE	2BR SUITE	2BR SUITE	48K
11,054,016	10 BEDROOM UNIT		28R SUITE	28R SUITE	2BR SUITE	2BR SUITE	2BR SUITE	4BR
BLDG 3 - LEVEL 1:	10 BEDROOM		SOME STATE OF	-	200000000000000000000000000000000000000		Was some of	200
8L001-LEVEL 1	UNIT		2BR SUITE	28R SUITE	28R SUITE	2RR SUITE	2BR SUITE	4BR
1987-0	10 BEDROOM		28R SUITE	28R SUITE	28R SUITE	200 SUITE	2BR SUITE	4BR
BLDG 3 - LEVEL 10 128 - 10	-	-	28K SUITE	ABR SUITE	*DK GOILE	ADM COLLE	aux ownt.	
BLOG 3 - LEVEL TO	10 BEDROOM UNIT		29R SUITE	2BR SUITE	2BR SUITE	28R SUITE	2BR SUITE	4BR
FIF-2	10 BEDROOM			V2570	State of		Test continue	
BLOG3+LPVRL1	UNIT	-	2BR SUITE	2BR SUITE	29R SUITE	28R SUITE	28R SUITE	48R
BLOG 3 - LEVEL 11	10 BEDROOM		-	200 0100	28R SUITE	2BR SUITE	2BR SUITE	4BR
8L06 2 - LEVEL 10 97 - 10	UNIT	1-1	2BR SUITE	2BR SUITE	SER SUITE	ZBR SUITE	28K SUITE	HON
	10 BEDROOM		288 SUITE	2BR SUITE	2BR SUITE	28R SUITE	28R SUITE	4BR
BLDG 3+LEYEL I			AUTOMATE	- Lori Santic		Santistania		17.12
50.00	10 SEDROOM UNIT	10 to 10 to	28R SUITE	28R SUITE	28R SUITE	28R SUITE	28R SUITE	4BR
N.DG.1 - LEVEL O	10 BEDROOM			To the second				
2.2.	UNIT		2BR SUITE	28R SUITE	2BR SUITE	2BR SUITE	2BR SUITE	4BR
SUNG 3 - LEVEL 7 SR - 12	10 BEDROOM			Time to the same of		Control of		75.1
8.001,1001	UNIT		28R SUITE	2BR SUITE	2BR SUITE	28R SUITE	2BR SUITE	48R
RDG3-LEVEL	10 BEDROOM	3 5	1	Samuel		Townson or 1	-	488
RLDG3 - LEVEL S	UNIT	Name and Address of the Owner, where	28R SUITE	20R SUITE	29R SUITE	2BR SUITE	28R SUITE	45K
49.6	10 BEDROOM UNIT		2BR SUITE	28R SUITE	2BR SUITE	2BR SUITE	2SR SUITE	4BR
30 - 10 A			ZDR QUILE	abr. some	SOCOGIE	- STANSOILE	- Automia	
	10 BEDROOM UNIT		28R SUITE	2BR SUITE	29R SUITE	2BR SUITE	2BR SUITE	4BR
8,003 - LEVEL 5	10 BEDROOM							
90003-10/012	UNIT		2BR SUITE	2BR SUITE	2BR SUITE	28R SUITE	2BR SUITE	SUITE 1BR
27 - P					100			
		H				TRASH	W 1	RETAIL
	FLEX SPACE	STAIR 2		FLEX SPACE		- NASH	353 F F W	200
BLDG3 - LEVEL 1								

PROJECT NAME

500 Kirkham

PANORAMIC **INTERESTS** 500 KIRKHAM ST, DAKLAND, CA

ARCHITECT

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PROJECT TRUE NORTH

DRAWN BY: PROJECT NUMBER:

SHEET ISSUE DATE:

11/27/17 SHEET TITLE

BLDG 3 BUILDING SECTIONS

Author

17-007

SHEET NUMBER

A4.3

(2) BUILDING 3 - SECTION THROUGH COMMERCIAL & CORRIDOR @ UNITS 1/16" = 1'-0"

1) BUILDING 3 - SECTION THROUGH FLEX SPACE & UNITS 1/16" + 1'-0"



PROJECT NAME

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PANORAMIC INTERESTS 500 KIRKHAM ST, CAKLAND, CA



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PROJECT NUMBER:

SHEET ISSUE DATE: 12/07/17
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PERSPECTIVE

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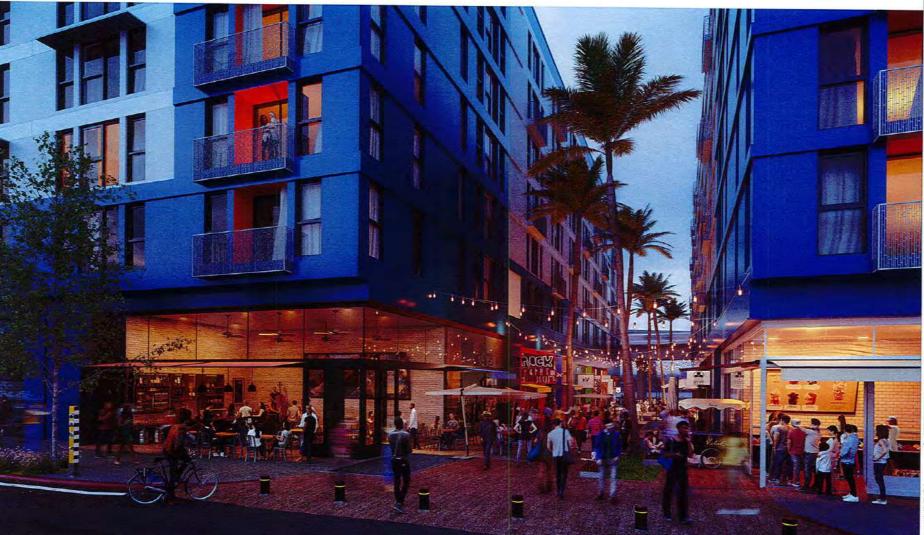
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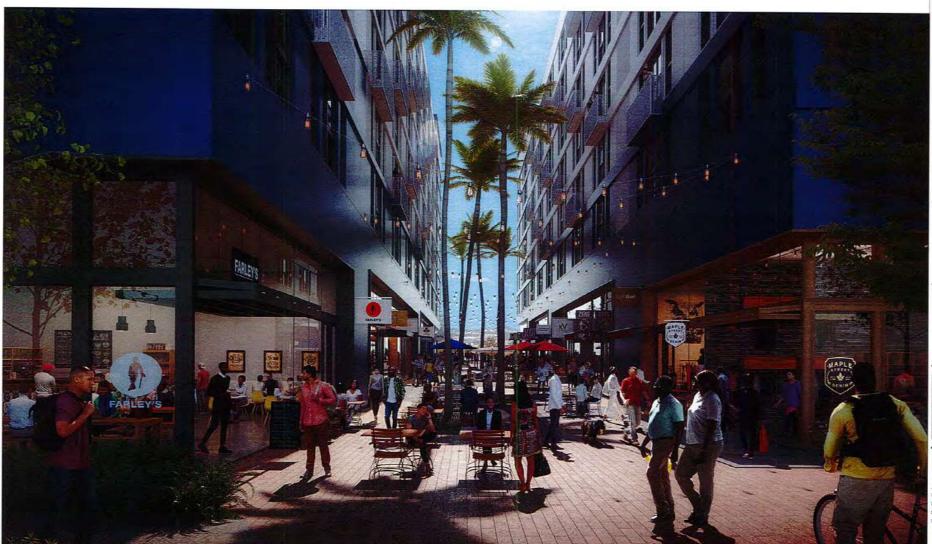


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A5.2

SHEET NUMBER





PROJECT NAME

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PROJECT NUMBER: 17-007
SHEET ISSUE DATE: 12/07/17
SHEET TITLE
PERSPECTIVE

A5.3



PROJECT NAME

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CONSULTANT

CONSULTANT STAMP

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PROJECT NAME

500 Kirkham

PANORAMIC INTERESTS

SOD KIRKHAM ST, DAKLAND, CA



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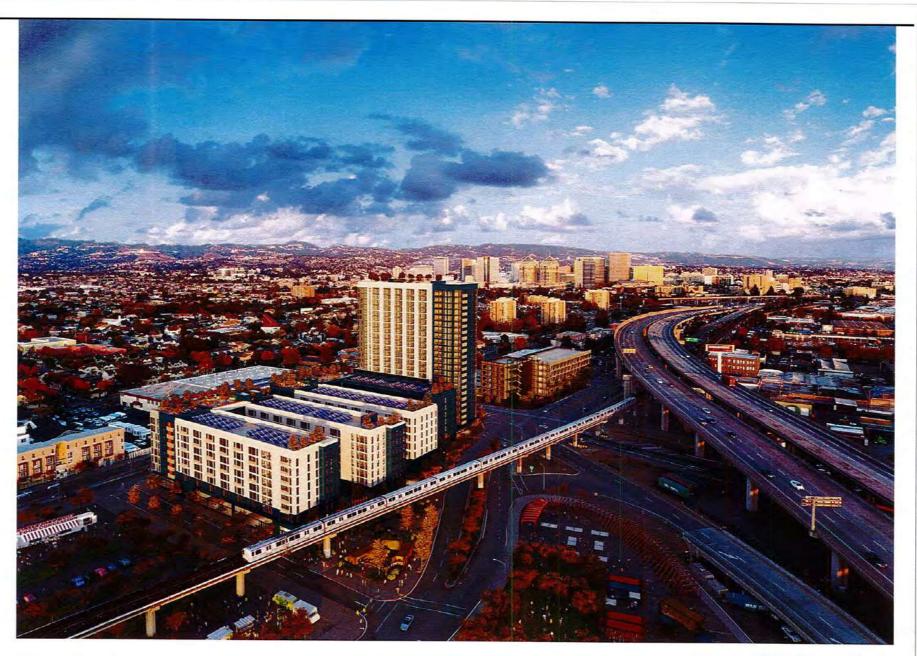
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AERIAL VIEW LOOKING EAST

lowney arch

PROJECT NAME

500 Kirkham

PANORAMIC INTERESTS

500 KIRKHAM ST, OAKLAND, CA



CONSULTANT


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AERIAL VIEW LOOKING EAST

lowney arch

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PROJECT NAME

500 Kirkham

PANORAMIC INTERESTS

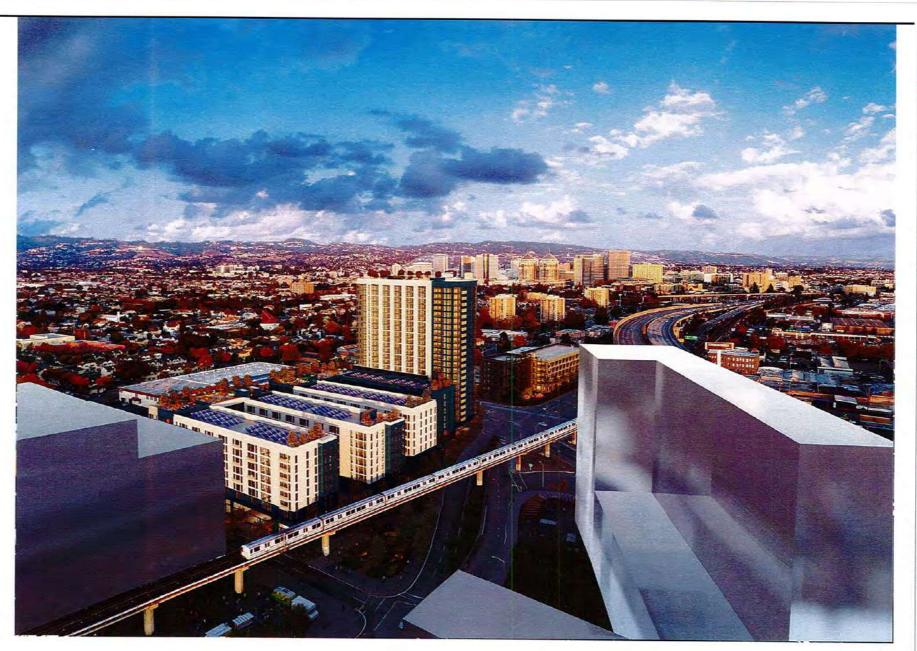500 KIRKHAM ST, QAKLAND, CA

ARCHITECT



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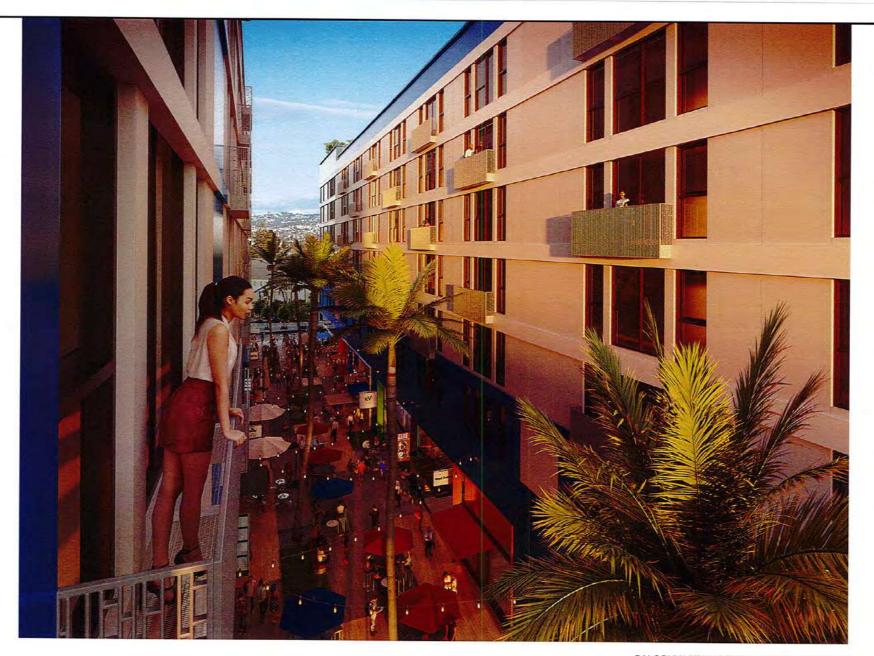
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BALCONY VIEW ABOVE PEDESTRIAN STREET

lowney arch

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PROJECT NAME

500 Kirkham

PANORAMIC INTERESTS

500 KIRKHAM ST, CAKLAND, CA

ARCHITECT



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