Case File Number: DA06011, PUD06010, PUD06010-PUDF12

March 27, 2019

Location:	Brooklyn Basin (formerly known as "Oak to 9th Avenue"); specifically, Parcel A
Assessor's Parcel Number(s):	APN 018 046500204
Proposal:	Final Development Permit (FDP) and Two Minor Variances for Parcel A, including 254 affordable residential units and 306 parking spaces, in a 73-
	foot tall building.
Applicant:	MidPen Housing Corporation
Contact Person/ Phone Number:	Jan Lindenthal, Chief Real Estate Development Officer
<b>v</b>	650-356-2900
Owner:	City of Oakland
Case File Number:	PUD06010-PUDF12
Planning Permits Required:	FDP, compliance with CEQA, variance for open space reduction, variance for residential off-street loading
General Plan and Estuary Plan:	Planned Waterfront Development-1
Zoning:	Planned Waterfront Zoning District (PWD-4)/D-OTN-4
<b>Environmental Determination:</b>	Final EIR certified on January 20, 2009
Historic Status:	Non-Historic Property
Service Delivery District:	3
City Council District:	2 – Nikki Fortunato Bas
Finality of Decision:	NA
For Further Information:	Contact case planner Dara O'Byrne at 510-238-6983 or by e-mail at dobyrne@oaklandca.gov


#### **SUMMARY**

The proposed project is a Final Development Permit (FDP) for construction of affordable housing in Brooklyn Basin. The proposed project includes 254 affordable housing units as well as accessory parking, in a 73-foot tall building encompassing an entire city block in the Brooklyn Basin Planned Unit Development (PUD) along the Oakland Estuary waterfront south of the Lake Merritt Channel. The Planning Commission approved FDPs for development for Brooklyn Basin at the adjacent Parcels F and B.

#### PROJECT SITE AND SURROUNDING AREA

Brooklyn Basin encompasses a 64-acre site that adjoins the Oakland Estuary to the south, the Embarcadero and I-880 freeway to the north, 9<sup>th</sup> Avenue to the east, and Fallon Street to the west. The project includes 29.9 acres of City parks located along the Oakland Estuary edge of the Brooklyn Basin Site. Shoreline Park is the southeastern-most park in Brooklyn Basin and is located on the water side of 9<sup>th</sup> Avenue, generally where the 9th Avenue Terminal is currently located.

### CITY OF OAKLAND PLANNING COMMISSION

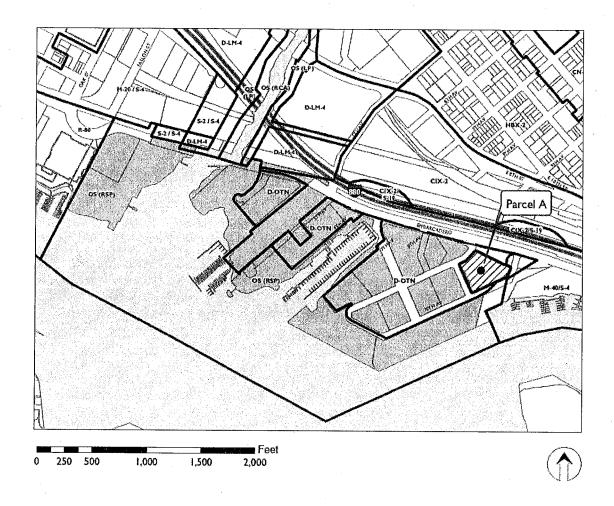

Case File: PUD06010-PUDF12

Applicant: MidPen Housing Corporation

Address: Brooklyn Basin (formerly known as "Oak to 9th Avenue")

specifically Parcel A

Zone: (PWD-4)/D-OTN-4

#### Case File Number DA06011, PUD06010, PUD06010-PUDF12

Page 3

Parcel A is located in Phase 1 of the Brooklyn Basin PUD; specifically, on the block bounded by 9<sup>th</sup> Avenue to the south, 8<sup>th</sup> Avenue to the north, Clinton Lane to the west, and Embarcadero to the east. Parcel A is located across the street from Parcel F, the other affordable housing parcel, and across Clinton Lane from Parcel B.

#### PROJECT BACKGROUND

Project History

The planned Brooklyn Basin Project consists of a mix of residential, retail and commercial, civic, and parks and open space uses preliminarily approved by the Planning Commission on March 15, 2006, and for which a Development Agreement was executed on July 18, 2006 by the City Council. Following a legal challenge, final entitlements were granted in 2009. The project sponsors plan to construct up to 3,100 residential units, 200,000 square feet of ground-floor commercial space, a minimum of 3,950 parking spaces, 29.9 acres of parks and public open space, two renovated marinas (with a total of 170 boat slips), and an existing wetlands restoration area. The existing buildings on the site will be demolished with the exception of a portion of the 9th Avenue Terminal shed building and the Jack London Aquatic Center. The project does not include approximately six acres of privately-held property along and east of 5th Avenue that contains a mix of commercial and industrial uses, as well as a small community of work/live facilities.

As noted above, Parcel A is located within Phase 1 of the Brooklyn Basin PUD. At this time, the Phase 1 Final Map has been recorded, horizontal infrastructure improvements constructed, and Final Development Permits issued for Shoreline Park, Parcel B, Parcel C, and Parcel F. The Final Development Permit for Parcel G will be considered by the Planning Commission on March 20, 2019. Most recently, the master developer has recorded the Phase 2 Final Map with the expectation to initiate development of Phase 2 parcels in the near future. Finally, it should be noted that the City of Oakland and the master developer, ZOHP, completed a parcel exchange to ease development of affordable housing on Brooklyn Basin Parcel A, so affordable housing will not be included on Parcel G.

Also of note, the Brooklyn Basin Master Developer (Master Developer) recently submitted an application to the City to amend the Development Agreement, the General Plan Designation and the underlying zoning district to allow for increased residential density at Brooklyn Basin, as well as to expand marina facilities in the Oakland Estuary at the planned parks. City staff is beginning environmental analysis of the application and will later consider the merits of the project. It should be noted that the Master Developer application does not impinge on rights to apply for and be granted FDPs at this time that comply with the existing entitlements.

#### Summary of Recent Brooklyn Basin Milestones 2018

Milestone	Requirement	Status
Phase 2 Infrastructure FDP	Brooklyn Basin PUD	Fall 2016
Parcel B Building Permits	Oakland Municipal Code,	Building Permit issued 2017;
issued	Title 15	Under construction
Parcel F FDP approved	EIR MM H, Prior to issuance	FDP approved November
	of site development building	2017; Building Permit
	permits	application submitted 2018
All Parks FDPs approved	Brooklyn Basin PUD	FDPs approved August 2017
DA amendment application	Planning Code Chapter	Currently under review
submittal, September 2018	17.138	
Parcel G FDP application	Brooklyn Basin PUD	Currently under review
submittal, August 2018		
Parcel A FDP application	Brooklyn Basin PUD	Currently under review
submittal, November 2018		

#### PROJECT DESCRIPTION

The proposed Brooklyn Basin Parcel A project is a 73-foot tall building encompassing a city block. The project includes 254 affordable residential units. The project includes a mix of one-, two-, and three-bedroom units. The project also includes 306 residential parking spaces. Plans, elevations and illustratives are provided in Attachment A to this report.

#### GENERAL PLAN ANALYSIS

The Brooklyn Basin project site is located in the Planned Waterfront Development-4 (PWD-4) Estuary Policy Plan (EPP) land use designation (the Estuary Policy Plan is the General Plan for the area that includes Brooklyn Basin). The intent of the PWD-4 land use designation is to "provide for the transition of underutilized industrial land to public parks and open space, commercial/retail, multifamily residential, cultural and civic uses. Improve public access to the waterfront by providing additional public parks and open space areas and a waterfront trail." In terms of desired character, future development should "create a new mixed-use residential, commercial/retail, recreational neighborhood in the areas south of the Embarcadero. New parks and open space areas will provide public access to the Estuary and will continue the series of waterfront parks and the San Francisco Bay Trail. Civic and cultural uses may be incorporated into the development. Two existing marinas will be renovated to enhance boating and marinerelated uses in the area." The maximum allowed intensity is 50 residential units per gross acre over the entire 64.2 planning area included in the PWD-4 land use classification, and approximately 200,000 square feet of commercial development. The master planned Brooklyn Basin PUD allows for development of up to 3,100 residential units. At this time, the total count for units considered under Final Development Permits is 693, well within the existing allowance. The following is an analysis of how the proposed project meets applicable EPP objectives (staff analysis in indented, italicized text below each objective):

- Objective LU-1: Provide for a broad mixture of activities within the Estuary area.
  - The proposal will deliver affordable housing that will intensify and support new uses in the Brooklyn Basin area and complement park and recreation uses along the Oakland Estuary waterfront.
- Objective LU-2: Provide for public activities that are oriented to the water.
  - The proposed project will include views of the waterfront across 9<sup>th</sup> Avenue. These strong visual and physical connections to the waterfront will enhance the experience of the waterfront for both residents and the public.
- Objective LU-3: Expand opportunities and enhance the attractiveness of the Estuary as a place to live.
  - The proposed project will provide much-needed affordable housing in a new neighborhood in a desirable location, supporting the socio-economic diversity of Oakland that makes it an attractive and desirable place to live.
- Objective LU-4: Develop the Estuary area in a way that enhances Oakland's long-term economic development.
  - The proposal will deliver much-needed affordable residential development that will intensify and support new uses in the Brooklyn Basin area and complement park and recreation uses, as well as commercial uses, along the Oakland Estuary waterfront. The proposal will provide affordable places to live for people who work in Oakland.
- Objective LU-5: Provide for the orderly transformation of land uses while acknowledging and respecting cultural and historical resources.
  - O The proposed mixed-use residential and commercial project would meet the goals for providing new uses on underutilized sites. The project is an important piece of the larger Brooklyn Basin project, which is transforming and improving the Oakland Estuary waterfront for public recreational and commercial use. As part of the Brooklyn Basin PUD, the master developer is retaining, restoring and occupying a portion of the historic 9<sup>th</sup> Avenue Terminal for historic interpretive, recreational, and commercial uses.
- Objective LU-6: Create greater land use continuity between the Estuary waterfront and adjacent inland districts.
  - The proposed project on Parcel A is part of the larger Brooklyn Basin PUD, which is designed specifically to connect the waterfront to the land side of Embarcadero, with landscaped streets and promenades, as well as improved pedestrian, bicycle and vehicular connectivity across Embarcadero and throughout the site.

#### **ZONING ANALYSIS**

Parcel A is located within the Planned Waterfront Zoning District-4 (PWD-4 Zone). The intent of the PWD-4 Zone is to provide mid-rise and high-rise housing opportunities together with

ground-floor retail and commercial uses. Future development is to be set back from the waterfront and address compatibility between residential and nonresidential uses, and reflect a variety of housing and business types. The following discussion outlines the purpose of the PWD-4 zone, with staff analysis provided below in indented, italicized text:

- Encourage the creation of a mixed-use district that integrates a combination of residential, commercial, public open space and civic uses.
  - The proposed project is an affordable housing project that will diversify living opportunities in the neighborhood.
- Establish development standards that allow residential, commercial, public open space and civic activities to compatibly co-exist.
  - The proposed project is subject to and generally meets the development and other standards under the PWD-4 Zone for density, height, setbacks, outdoor open space and parking, and is compatible with the site and surrounding area.
- Provide a balance of private development and public open space with convenient access to public open space and the waterfront.
  - The residential project is conveniently located across the street from Shoreline Park.
- Improve access to the waterfront and recreational opportunities along the waterfront including boat launches and marinas.
  - The proposal is part of the Brooklyn Basin PUD which includes infrastructure improvements such as marinas and boat launch areas for public use along the Oakland Estuary.
- Encourage quality and variety in building and landscape design as well as compatibility in use and form.
  - The proposal is designed to be visually interesting and differentiated from the planned project for Parcel F in order to provide variety in the neighborhood. In addition, the project includes landscaping concepts intended to provide connectivity between the public and private realms.

#### Zoning Considerations

- Residential density. 300 residential units were allocated to Parcel A according to the 2017 reallocation. The Parcel F entitlement included a swap of 46 units from Parcel A to Parcel F, which left a total of 254 residential units allocated to Parcel A. 254 residential units are proposed.
- Open Space. 38,100 square feet of group useable open space is required, but 26,187 square feet is provided. A minor variance will be required.
- Off-Street Loading. Each phase of development requires 1 off-street loading berth. Each phase provides an off-street loading berth, but the berths do not meet the height requirements for off-street residential zoning. A minor variance will be required.

#### **Brooklyn Basin Residential Density Allocation**

		for 2017 par	n (accounting reel swap and D allowances)			
Parcel	Baseline Density Allowance	2017 Allocation	Delta (from 2009 to 2017)	2019 Allocation	Delta (from 2017 to 2019)	Enabling Procedure
В	175	241	+66 du/38%			Design review (approved 2016)
С	175	241	+66 du/38%			Design review (approved 2017)
D .	175	175	0			Original approval
Е	131	138	+7 du/6%			By right
G	300	288	-12 du/5%	356	+68/24%	Design review (under review 2019)
Н	375	No change	0			Original approval
J	339	No change	0			Original approval
K	322	332	+10 du/4%			By right
L	146	No change	0 .			Original approval
M	390	360	-30 du/9%	292	-68/19%	Swap with Parcel G
			Affordab	le Housing		***************************************
A	407	300	-107 du/36%	254	-46/15%	Approved as part of Parcel F swap
·F	165	165	0	211	+46/28%	Approved by Council (2017 parcel swap) and Approved by Planning Commission as part of Parcel F approval
Total	3,100	3,100	0/No change	1 2 3 4 2 4 5 1 5 1 5 1 5 1 5 1 5 1 5 1 5 1 5 1 5		

#### Oak to 9th Brooklyn Basin Design Guidelines

- Urban Design Principles:
  - Create walkable and lively public streets, open spaces and pedestrian ways that provide strong visual and pedestrian linkages between the waterfront and inland areas.
    - The Brooklyn Basin PUD will have approximately ten new public streets. Parcel A provides ground floor residential along 9<sup>th</sup> Avenue and 8<sup>th</sup> Avenue.
  - o Introduce a mix of housing that supports a diverse population of residents and that promotes a nighttime environment along the waterfront.
    - The proposed project adds a much-needed influx of 254 affordable residential units with a variety of unit types (including one-, two, and three-bedroom models). In addition to the 254 affordable units provided with Parcel A, Parcel F is providing 211 affordable units for a total of 465 affordable units.
  - o Maintain and enhance public views of the waterfront.

- The 73-foot tall building and provides direct views to the Estuary, and will not block or impede views of the waterfront.
- Configure and design buildings to spatially define and reinforce the public character of streets and open spaces.
  - The proposed building is designed with a strong street wall and maximized ground floor transparency and landscaping to frame and enrich the character of the adjacent rights-of-way.
- o Introduce ground level activities that enliven streets and public spaces.
  - The proposed project is designed to provide ground floor lobbies and community rooms at key corners. Ground floor residential units are setback with landscaping and individual gates to the units.
- O Develop a dynamic composition of taller and shorter buildings that reinforce the spatial characteristics of the waterfront and open space system, and that dramatize this unique shoreline setting.
  - The project is a mid-rise product designed to fit the Brooklyn Basin PUD. The building provides some height variation to reduce the risk of a monolithic presence, particularly along 9<sup>th</sup> Avenue.
- Allow for a diversity of architectural expressions within the strong public framework of streets and open spaces.
  - The project is designed to fit within the desired scale of development of the site while being massed and articulated differently from the adjacent Parcel F and Parcel C projects. The intent of this approach is to provide a diversity of architectural expression within the neighborhood for visual complexity and interest.

#### • Design Concepts:

- O Podium Units: The mid-rise buildings of Brooklyn Basin will come in a full range of sizes and as such will serve a broad segment of the population including seniors, singles and young couples. Many of these units will enjoy direct views to the waterfront and/or internal courtyard open spaces with resident-serving amenities.
  - The proposed Parcel A project will serve low-income population with affordable housing. These units will enjoy views to the Estuary and Shoreline Park.
- Multiplicity of Architectural Expressions: Buildings within Brooklyn Basin are not restricted to any specific architectural style. Rather, a variety of architectural expressions are encouraged as a means of enhancing the diverse mixed-use, urban character of the community.
  - The proposed Parcel A project provides a highly-articulated exterior with a combination of projecting elements and deep recesses. The 9<sup>th</sup> Avenue façade is broken by courtyards at the third floor and the 8<sup>th</sup> Avenue face is animated by a curving façade. The curved theme provides a contrast to the neighboring angular masses of Parcel F and B.

#### **ZONING AND RELATED ISSUES**

#### Design

Staff has worked with the applicant and architect to refine the proposed design for the Parcel A site. Parcel A is essentially an entire city block, and the proposed project consists of two separate buildings that will be built in two separate phases. Once built, the two buildings will look like a seamless, singular building. The team has worked to improve the overall design of the project to create a cohesive design. Key aspects of the building include:

- Building Orientation: The Parcel A Project is designed as two buildings, which could feasibly be constructed in two phases, but will appear as one building when completed. For the purposes of Design Review, staff has reviewed the project as one building. The building is oriented toward 9<sup>th</sup> Avenue, with direct views to Shoreline Park and the Estuary. 9<sup>th</sup> Avenue provides ground floor residential units, lobbies, and two community rooms to enhance the pedestrian environment. "Back-of-house" uses are ganged on Clinton Lane and Embarcadero, with ground floor residential on 9<sup>th</sup> Avenue and 8<sup>th</sup> Avenue.
- Building Appearance: The project differentiates the corners of the building through massing, articulation, exterior treatments, and glazing. Staff worked with the applicant to integrate the curves on the corners of Embarcadero into the balconies and other features of the building to create a more effective design.
- Ground Floor Residential: Ground floor residential units are located on all four facades of the building. The ground floor units are setback from the street with fenced patios and entries to the unit as well as landscaping to help transition from the public realm to private space.

#### Issues

In general, staff finds the project to be well-designed and much improved since the original submittal. Back-of-house uses are generally contained within the project and are minimized along the edges. That said, staff has a few remaining design concerns and asks the DRC to consider the following:

- **Ground floor residential units**. The vision for 8<sup>th</sup> Ave and Clinton Lane are urban residential streets with an urban village character with ground level activities that enliven streets and public spaces. The guidelines envision tree-lined sidewalks defined by ground level lobbies, townhouse, and loft units. The guidelines for 8<sup>th</sup> Ave and Clinton Lane recommend the following:
  - o "Frontages should include one or more of the following:
    - Residential lobbies with articulated building entries that provide a welcoming gesture to the street;
    - Common areas and/or sales or leasing offices generally flush with the elevation of the sidewalk;
    - Ground level residential units that are elevated above the grade of the adjacent sidewalk and/or that include other devices that protect the privacy of the unit (e.g., screen walls or elevated patio areas) from the street.

o Individual unit entries with stoops connecting to the public sidewalk are encouraged, provided that such entries function as a primary entrance to the unit, and that the stoop is not utilized as a rear balcony."

The proposed project includes ground floor residential units on 8<sup>th</sup> Ave and Clinton Lane that are at ground level, and therefore do not include a stoop. A setback is provided with landscaping and includes a small fenced patio area to provide privacy and to transition from public space to private space. Staff has worked with the applicant to improve the ground-floor unit's connection to the street, but staff is concerned the setback treatment performs as the back of the unit instead of appearing like a front door. Staff recommends articulating the opening gate and better connecting the gate to the sidewalk with a walkway to indicate that this is a primary entry to the unit. For the DRC consideration:

- Do the ground floor units with fenced patios and landscaping comply with the design guidelines and provide for an attractive pedestrian-oriented street?
- Waterfront/Park Edge. The elevation on 9<sup>th</sup> Ave is directly across the street from Shoreline Park with direct views to the Estuary. The guidelines call for buildings to be designed to create a strong and visually attractive edge to the parks. While ground level activities are encouraged along these edges to the maximum extent practicable, it is particularly important for the buildings to introduce high quality architectural finishes and treatments that reinforce the public and civic nature of the open spaces. The following guidelines should be followed for these frontages:
  - o Ground level common spaces such as courtyards or gardens that are accessible and visible from adjacent streets are encouraged.
  - Second level terraces and balconies that overlook the open space and provide a sense of security are also encouraged.
  - O High quality materials (stone, masonry, terra cotta, architectural pre-cast, etc.), architectural and storefront detailing, and decorative elements, should be employed on the base of the building up to a height of at least 20 feet.
  - O Articulated building entries should be provided wherever appropriate, at intervals of at least 200 feet or one per block face.
  - o Entries should have a high level of architectural finish and detailing (e.g., moldings, canopies, etc.) that is in scale with the adjacent open space.
  - o Landscaping (e.g., planting beds, hedges, etc.) should be incorporated in the setback area along public sidewalks and promenades."

Working with staff, the applicant has improved this façade, but staff believes better connections can be made with the ground floor units and the overall façade to reflect the waterfront location.

- Does the DRC think the 9<sup>th</sup> Ave elevation adequately responds to its waterfront location?
- Overall Building Design. The overall building design provides articulation and a variety of shapes, colors, and materials that break up the mass of the building. The building includes a base that is defined through color changes, inset windows and balconies that stop at the third floor. The curvilinear theme helps to distinguish the building from other buildings in Brooklyn Bass. Staff thinks the building design has improved since the initial submittal and the applicant team has responded to staff input.

Staff does recommend further integration of key design themes into the overall building design, as outlined in the following discussion. In particular, the curve and sawtooth architectural form themes could be very successful in distinguishing the proposed building from other Brooklyn Basin buildings and providing a more architecturally resolved appearance. For example, the corner curve element at the corner of Clinton Way and 8<sup>th</sup> Avenue is not integrated into all elements of the corner and does not relate to the building recesses at that location. More critically, the curve and sawtooth forms are not carried through the 9<sup>th</sup> Avenue façade, the most prominent façade of the building. Additionally, the form themes are minimally articulated, if at all, at the ground floor of the building. As such, the building does not feel fully connected to the groundplane and surrounding neighborhood.

- O Staff recommends the applicant further refine the building facades and corner treatments to:
  - 1) Detail the corner elements to both include key architectural themes and ensure those themes are carried out holistically through the entirety of the corner elements;
  - 2) Apply the key architectural themes to the 9<sup>th</sup> Avenue building façade to provide a unique and interesting building identity along the primary frontage; and
  - 3) Carry design themes to the ground floor to provide connectivity between the building and the groundplane.

#### On-going, Non-design Related Issues

- Open Space. 38,100 square feet of group useable open space is required, but 26,187 square feet is provided. A minor variance will be required. The proposed project provides high-quality, high-amenity open space with children play areas and barbeque areas with views of the water. In addition, the project is located directly across the street from Shoreline Park and is within short walking distance to the many other Brooklyn Basin open space amenities.
  - O Staff recommends that, to offset the minimal amount of usable open space, the public facing open spaces (including balconies and ground floor front yards) be designed to enrich the appearance of the building and support connectivity between public and private realms, consistent with comments above regarding the ground floor units.
- Off-street Residential Loading. Each phase of development requires one off-street loading berth. Each phase provides an off-street loading berth, but the berths do not meet the height requirements for off-street residential zoning. A minor variance will be required.

#### Case File Number DA06011, PUD06010, PUD06010-PUDF12

Page 12

#### RECOMMENDATION

Staff recommends the DRC review and comment on the proposed Brooklyn Basin Parcel A FDP, with attention to the issues raised by staff in this report.

Prepared by:

Reviewed by:

Catherine Payne, Acting Development Planning Manager

Bureau of Planning

#### Attachment:

A. Proposed Plans, dated March 7, 2019

1 (33'x12'x14' HIGH) 1 (33'x12'x11' HIGH)

TRASH + RECYCLING + COMPOST

REQUIRED FOR RESIDENTIAL USES OVER 50,000 S.F.

TYPES (TRASH + RECYCLING + COMPOST)

#### PROJECT INFORMATION - PHASE B

APN		018-0465-012	_ 2 Brooklyn Basin Parcel A
ADDRESS ZONE		101 9TH AVE	
	IT ZONE	PWD-4	
USES	PERMITTED - permanent housing		
SITE AREA	SQUARE FEET	49,782	) SE
	ACRES		ACRES
DENSITY			
SITE A	REA (S.F.) PER UNIT	401	
UEIGUT	PROPOSED DENSITY	401	S.F. / UNIT
HEIGHT		4 FLOORS TYPE IIIA	
	CONSTRUCTION	OVER 2 FLOORS TYPE 1A	
	MAX. ALLOWABLE HEIGHT (per PWD-4, Table 504.3, sect. 510.2)	86'	
	MAX TOTAL STORIES ABOVE GRADE (per Table 504.4, sect. 510.2) PROPOSED HEIGHT	73' 0"	T.O. PARAPET
		64' 6"	
	EXCEPTIONS - CHIMNEYS, MECH EQUIPMENT (17.108.030)	10'	
YARDS AN	PENTHOUSES, STAIR TOWERS (17.108.030) D COURTS (Oak to 9th Brooklyn Basin Design Guidelines)	12' REQUIRED	PROVIDED
	8TH AVE. SETBACK		VARIES (5' AVG.)
	9TH AVE. SETBACK	2' TO 8'	VARIES (5' AVG.)
COURT	EMBARCADERO SETBACK		PROPOSE 10' + BIO-SWALE AREA PROVIDED
COOKI	MIN. DIM - COURT (16' + 4'/STORY ABOVE) 17.108.120		32' MIN.
	MIN. DIM - L.R. WINDOWS (8' +2'/STORY ABOVE) 17.108.080		16' MIN.
PROJE	MIN. DIM - B.R. WINDOWS (17.108.120) CTIONS - BAYS / BALCONIES (17.108.130)		' 10' MIN. ' 2'
	N IN STREET WALL BUILDING PLANES (20% OF LENGTH/AREA)		PROVIDED (3' to 5' recesses)
	8TH AVENUE (Oak to 9th Brooklyn Basin Design Guidelines)	56' x .20 = 11'	17'
	9TH AVENUE (Oak to 9th Brooklyn Basin Design Guidelines) EMBARCADERO (Oak to 9th Brooklyn Basin Design Guidelines)	252' x .20 = 50' 357' x .20 = 71'	67' (includes deep courtyard recesses)
	Embracio (our to stri brookly) busin besign dudennes)	337 X.20 - 71	,3
OPEN SPAC			
	RED - 150 s.f. / unit per 17.160 (PWD-4) REQUIRED GROUP OPEN SPACE = 150 X 124	18,600	SE
	MIN. DIMENSION		Private on ground, 10', above ground 5'
	DED - COMMON		
	MAIN COURTYARD (FLOOR 3) TOTAL PROVIDED	12,966 12,966	
	DED - PRIVATE		SF -
	SUBSTITUTION FOR COMMON OPEN SPACE 2:1	0	
	OPEN SPACE PROVIDED (COMMON + 2X PRIVATE) SPACE PROVIDED/UNIT	12,966 105	
OI EII S	STACET NOTIBED/ONLY	103	3F
UNITS			
	ONE BEDROOM TWO BEDROOM		33% 32%
	THREE BEDROOM	The second secon	35%
	TOTAL	124	
ACCESSIBLE	MOBILITY (10%)	12	
	COMMUNICATION (4%)	5	
DI III DINC A	AREA (S.F.) - GROSS AREAS		
FLOOR			
	CONDITIONED AREA	13,098	
FLOOR	UNCONDITIONED (GARAGE/UTILITY) AREA	29,758	SF
	CONDITIONED AREA	20,035	SF
	UNCONDITIONED (GARAGE/UTILITY) AREA	22,851	
FLOOR FLOOR		30,304	
FLOOR		30,433 30,061	
FLOOR		30,061	SF
	TOTAL GROSS AREA TOTAL GROSS AREA - CONDITIONED ONLY	206,601 153,992	
		133,332	3
PARKING			
REQUIR	BASE PARKING RATIO: 1 SPACE/DU (17.180)	141	STALLS
	AFFORD HSG RATIO: 0.75/DU FOR NON TRANSIT ACCESS		STALLS
	MISC. REQUIRED ( ELECTRIC VEHICLE, CARPOOL, CARSHARE, ETC.)		
	(15.04.3.1110)	14	10% OF PARKING SPACES (ROUNDED UP) UP TO 50%, PROVIDED <50% OF THE REQ'I
	ALLOWABLE COMPACT (17.94060 B.)	71	SPACES ARE REGULAR AND/OR HANDICAP
			SPACES
	STALL DIMENSIONS - REGULAR (17.940.060) STALL DIMENSIONS - INTERMEDIATE (17.940.060)		PARALLEL = 22' X 8'
	STALL DIMENSIONS - INTERMEDIATE (17.940.060) STALL DIMENSIONS - COMPACT (17.940.060)		PARALLEL = 20.5' X 7.5' PARALLEL = 19' X 7'
,	AISLE WIDTH (17.94.070 - ANGLE OF 90 DEGREES)	21'	
PROVID	DED TOTAL PROVIDED	4	Porcent provided:
	ACCESSIBLE / REGULAR PROVIDED		Percent provided: 18%
(	COMPACT PROVIDED	24	17%
	INTERMEDIATE PROVIDED MIN. STALL DIMENSIONS	The same of the sa	65%
	MIN. STALL DIMENSIONS PROVIDED STALL TYPES		MEDIATE: 8' X 16.5'; COMPACT: 7.5' X 15' ANDARD + 17% COMPACT
	AISLE	MINIMUM 21'	
PICYCLE	CC (DED 17 117 000 DED ID PICYCLE DARVINGS	BEGUNDE	DROVIDED
	ES (PER 17.117.090 REQ'D BICYCLE PARKING) SHORT TERM (1 PER 20 UNITS)	REQUIRED 6	
	LONG TERM (1 PER 4 UNITS)	31	
OADING	DECLINDED EOD DESIDENTIAL LISES OVER EO MOS E	1 (22/212/24/11/01)	1 /22/-12/-11/ UICU\
OADING	REQUIRED FOR RESIDENTIAL USES OVER 50,000 S.F. CYCLING	1 (33'x12'x14' HIGH)	1 (33'x12'x11' HIGH)

## BROOKLYN BASIN PARCEL A

### OAKLAND, CA 94608

#### SUMMARY SCOPE OF WORK

CONSTRUCTION OF NEW 6-STORY TYPE Y-A OVER TYPE 1-A BUILDINGS TO ACCOMMODATE 254 UNITS (130 UNITS (PHASE A) AND 124 UNITS (PHASE B)) OF AFFORDABLE HOUSING FAMILY APARTMENTS. THE BUILDING SHALL INCLUDE STRUCTURED PARKING, OFFICE, COMMUNITY SPACE, LAUNDRY ROOMS, AND OTHER SUPPORT SPACES. ALSO INCLUDES THE CONSTRUCTION OF OUTDOOR PLAY AREAS, LANDSCAPE, BICYCLE PARKING, AND OTHER

#### PROJECT TEAM

#### **DEVELOPER**

MIDPEN HOUSING CORP. 1970 BROADWAY SUITE 440 OAKLAND, CA 94612 Phone: 510-426-5672 CONTACT: JENNIFER LIU

SHEET INDEX

CML

LANDSCAPE SHEETS

ARCHITECTURAL SHEETS

PROJECT INFORMATION

EXISTING CONDITIONS AND BOUNDARY PROPOSED PLAN

LANDSCAPE PLAN - STREET LEVEL

SITE & 1ST FLOOR PLAN

2ND FLOOR PLAN 3RD FLOOR PLAN 4TH FLOOR PLAN

5TH FLOOR PLAN 6TH FLOOR PLAN

EXTERIOR FLEVATIONS EXTERIOR ELEVATIONS
EXTERIOR ELEVATIONS

EXTERIOR ELEVATIONS EXTERIOR ELEVATIONS

PERSPECTIVES SIGNAGE DESIGN (PHASE A)

SIGNAGE DESIGN (PHASE B) COLOR AND MATERIAL BOARD EXTERIOR WINDOW JAMB DETAILS

AERIAL VIEW 9TH AND EMBARCADERO

PERSPECTIVES

ROOF PLAN EXTERIOR ELEVATIONS EXTERIOR ELEVATIONS

LANDSCAPE STREET LEVEL ELEMENTS

LANDSCAPE PLAN - LEVEL 3
PODIUM LEVEL PLANTER WALLS & SITE FURNISHINGS

PODIUM LEVEL PLANT PALETTE & PLANTING GUIDELINES

BKF ENGINEERS 300 FRANK H. OGAWA PLAZA #380 OAKLAND, CA 94612 Phone: 650-482-6458 CONTACT: ASHLEY STANLEY

#### **ARCHITECT**

HKIT ARCHITECTS 538 NINTH ST SUITE 240 OAKLAND, CA 94607 Phone: 510-625-9800 CONTACT: PAUL MCELWEE

#### **LANDSCAPE**

PGA DESIGN LANDSCAPE ARCHITECTS 444 17TH STREET OAKLAND, CA 94612 Phone: 510-550-8858 CONTACT: KAREN KROLEWSKI

## VICINITY MAP



#### Parcel A, Brooklyn Basin

#### **BROOKLYN BASIN** PARCEL A

ARCHITE

OAKLAND, CALIFORNIA

11/19/18 PLANNING SUBMISSION 02/15/19 DESIGN REVIEW 02/27/19 PLANNING REVIEW 03/07/19 PLANNING RESUBMITTAL

DRAWING TITLE

AS NOTED

TYPES (TRASH + RECYCLING + COMPOST)

TRASH + RECYCLING + COMPOST

STRUCTURAL IDA STRUCTURAL ENGINEERS 1629 TELEGRAPH AVENUE, SUITE 300 OAKLAND, CA 94612

Phone: 510-834-1629

CONTACT: STEPHEN DEJESSE

MP / E EMERALD CITY ENGINEERS, INC. 6505 216TH ST SW SUITE 200

MOUNTLAKE TERRACE, WA 98043 Phone: 425-741-1200

00275 JOB NO. DRAWN OM/VB CHECKED

JOB CAPTAIN OM

DATE

**PROJECT** INFORMATION

SCALE

FACING SOUTH AT EMBARCADERO + 7TH AVENUE



FACING SOUTH AT EMBARCADERO



FACING SOUTH AT EMBARCADERO + 8TH AVENUE



FACING WEST AT PARCEL A



7 AERIAL OF EXISTING CONDITIONS



5 FACING NORTH AT PARCEL G



6 FACING WEST THROUGH EMBARCADERO

#### BROOKLYN BASIN PARCEL A

OAKLAND, CALIFORNIA

JOB NO. 00275 DRAWN 0M

CHECKED -JOB CAPTAIN PM


11/19/18 PLANNING SUBMISSION 02/15/19 DESIGN REVIEW 02/27/19 PLANNING REVIEW 03/07/19 PLANNING RESUBMITTAL

DRAWING TITLE

**EXISTING CONTEXT** 

SCALE NO

G1.0

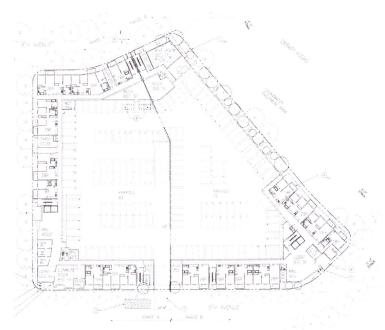

1ST FLOOR PLAN



2ND FLOOR PLAN



3RD FLOOR PLAN



4TH FLOOR PLAN



5TH FLOOR PLAN



**6TH FLOOR PLAN** 

#### PHASE A (130 UNITS)

	Common open space (SF)	Private open space (SF)
1st	0	0
2nd	0	0
3rd	13,221	0
4th	0	0
5th	0	0
6th	0	0
Subtotal	13,221	0
Area / Unit	102	0

PHASE B (124 UNITS)

	Common open space (SF)	Private open space (SF)
1st	0	0
2nd	0	0
3rd	12,966	0
4th	0	0
5th	0	0
6th	0	0
Subtotal	12,966	0
Area / Unit	105	0

PHASE A COMMON OPEN SPACE

PHASE B COMMON OPEN SPACE

SCALE AS NO

**OPEN SPACE** 


**DIAGRAMS** 

**BROOKLYN BASIN** 

11/19/18 PLANNING SUBMISSION 02/15/19 DESIGN REVIEW 02/27/19 PLANNING REVIEW 03/07/19 PLANNING RESUBMITTAL

PARCEL A

G2.0

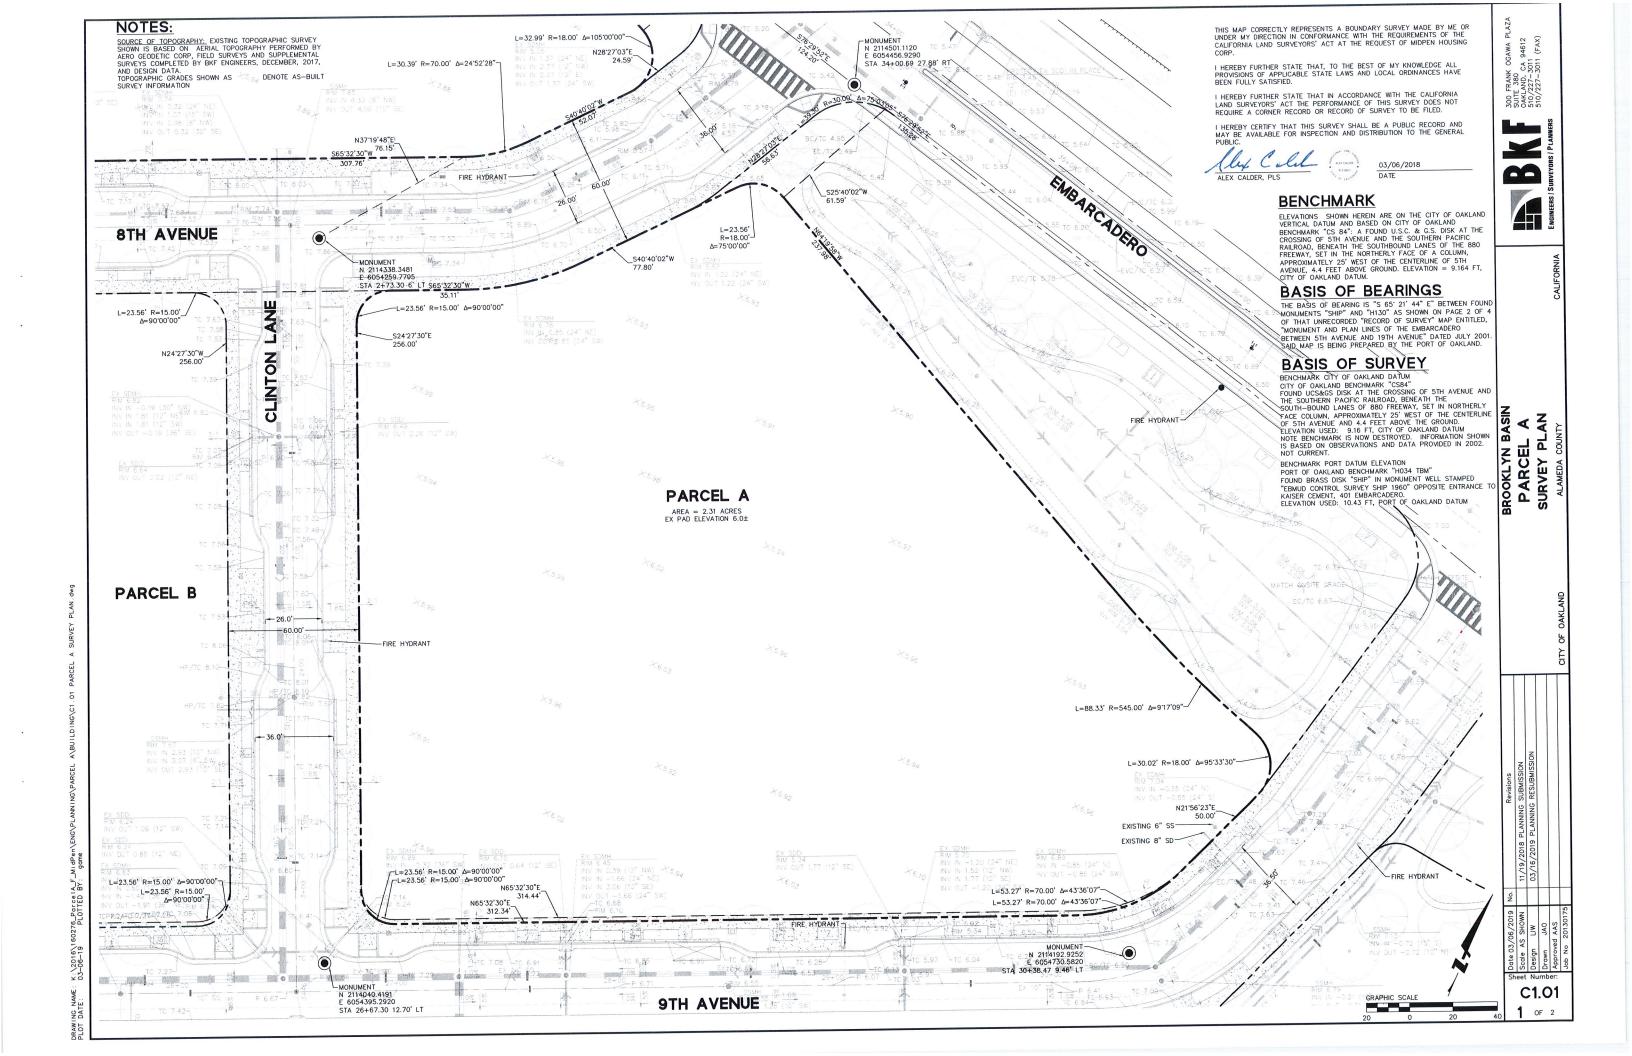



HKIT ARCHITECTS
338 NINTH STREET SUITE 240 • OAKLAND, CA 94607

**PGAdesign** 

NDSCAPE ARCHITECT

tel 510.465.1284 url PGAdesign.com

Brooklyn Basin

JOB NO. 00275
DRAWN DC,KK
CHECKED KK

DATE
03/08/19 PLANNING SUBMISSION


DRAWING TITLE

Landscape Plan - Street Level

CALE 1" = 20'-0

L1.01

## street level entry elements

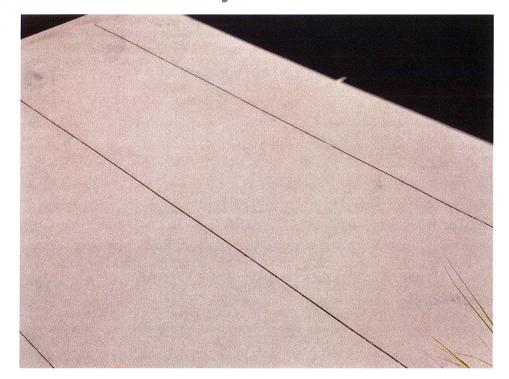

COLORED CONCRETE & SCORING AT ENTRY PLAZAS



ENTRY AREA SEAT WALL: GROUND FACE CMU BLOCKS



BIKE RACK: RIDE BY LANDSCAPE FORMS, www.landscapeforms.com

# S38 NINTH STREET SUITE 240 · OAKLAND, CA 94607 T S10 625 9800 · F S10 625 9801 · WWW.HKT.COM

**PGAdesign** 

INDSCAPE ARCHITECT

tel 510,465,1284 url PGAdesign.co

## street level trees

LARGE SHADE TREE



ULMUS PARVIFOLIA 'DRAKE' (DRAKE CHINESE ELM)

MEDIUM SIZED TREES



ACER RUBRUM 'ARMSTRONG' (RED MAPLE)



GINKGO BILOBA 'PRINCETON SENTRY' (GINKGO)

#### ACCENT TREES



CERCIS CANADENSIS 'FOREST PANSY' (FOREST PANSY REDBUD)



CERCIS OCCIDENTALIS (WESTERN REDBUD)

#### Brooklyn Basin

Parcel A

JOB NO. 00275
DRAWN DC,KK
CHECKED KK
JOB CAPTAIN KK

03/08/19 PLANNING SUBMISSION

Landscape Street Level Elements

SCALE

L1.02

## HKIT ARCHITECTS NINTH STREET SUITE 240 • OAKLAND, CA 94607

**PGAdesign** 

LANDSCAPE ARCHITECTS

tel 510.465.1284 url PGAdesign.com 444.17th Street Oakland CA 94612

#### Brooklyn Basin

Parcel A

JOB NO. 00275
DRAWN DC,KK
CHECKED KK
JOB CAPTAIN KK
DATE

03/08/19 PLANNING SUBMISSION

DRAWING TITLE

Landscape Plan - Level
3

SCALE 1" = 20'

L2.01



CMU BLOCK WALLS: 6" WIDE WITH GROUND FACE FINISH, DOUBLE WIDE AT SEAT WALL AREAS 16" WIDE

site furnishings



TABLES & CHAIRS: 21 CHAIR & TABLE BY LANDSCAPE FORMS, WWW.LANDSCAPEFORMS.COM




BENCH: SANTA COLE HARPO LOUNGE CHAIR BY LANDSCAPE FORMS, WWW.LANDSCAPEFORMS.COM



SEAT: SANTA COLE NEOLIVIANO SLIDER BY LANDSCAPE FORMS, WWW.LANDSCAPEFORMS.COM

## pavers

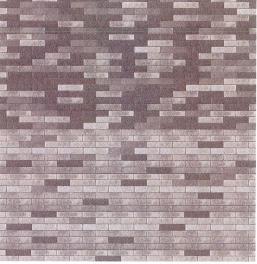



BELGARD MODULINE PAVERS: 2 COLORS, BELNDED AT DIFFERENT RATIOS, MANUFACTURER'S STANDARD PALETTE: COLORS TO BE SOLID COLORS, SIZES: 60 MM THICKNESS; 6X1 & 6X9, WWW.BELGARD.COM

## play area elements



MOUNDED RUBBER SAFETY SURFACING



SENSORY TENT



PLAY CUBES

## KIT ARCHITECTS

#### **PGAdesign**

LANDSCAPE ARCHITECTS

#### Brooklyn Basin

Parcel A

DRAWN DC,KK
CHECKED KK

JOB CAPTAIN DATE

03/08/19 PLANNING SUBMISSI

DRAWING TITLE

Podium Level Planter Walls & Site Furnishings

SCALE

L2.02

















#### **PLANTING DESIGN INTENT & NOTES**

- 1. THE PROJECT PLANTING AND IRRIGATION DESIGN WILL BE DESIGNED WITH LOW WATER USE PLANTS AND EFFICIENT IRRIGATION SYSTEM WHICH WILL MEET THE STATE'S MODEL WATER EFFICIENT LANDSCAPE ORDINANCE. COMPLETED CALCULATIONS AND WORKSHEETS WILL BE PROVIDED DURING BUILDING PERMIT PHASE.
- DUILDING PERMIT PHASE.

  PLANTS SELECTED WILL BE PRIMARILY LOW WATER USE AND IRRIGATION WILL CONSIST OF SUBSURFACE DRIP WITH A SMART IRRIGATION CONTROLLER.

  ALL SHRUBS, GROUNDCOVERS, TREES AND VINES SELECTED FOR PLANTING
- ARE LOW WATER USE. ALL SHRUBS AND GROUNDCOVER AREAS (NON-TURF AREAS) TO BE IRRIGATED WITH DRIP IRRIGATION. ALL TURF AREAS IRRIGATED WITH HIGH-EFFICIENCY SPRAY.

  NON-TURF AREAS: AT LEAST 75% OF THE PLANT SELECTION IS NATIVE OR
- CLIMATE APPROPRIATE LOW WATER USE SPECIES AND REQUIRE MINIMAL WATER ONCE ESTABLISHED. UP TO 25% OF THE PLANTS MAY BE NON-DROUGHT TOLERANT VARIETY AS LONG AS THEY ARE APPROPRIATELY GROUPED TOGETHER AND IRRIGATED SEPARATELY AND EFFICIENTLY AS
- NO PLANTED SPECIES CAN BE LISTED BY CAL-IPC (CALIFORNIA INVASIVE PLANT COUNCIL) AS INVASIVE IN THE SAN FRANCISCO BAY AREA, AND PLANT RIGHT, KEEP INVASIVE PLANTS IN CHECK BY CALIFORNIA HORTICULTURAL INVASIVE'S PREVENTION (CAL-HIP).

#### **IRRIGATION DESIGN INTENT &MWELO** CONFORMANCE

- IRRIGATION SYSTEM IS DESIGNED TO PROVIDE THE MINIMUM AMOUNT OF WATER NECESSARY TO SUSTAIN GOOD PLANT HEALTH. ALL SELECTED COMPONENTS ARE COMMERCIAL GRADE, SELECTED FOR DURABILITY, VANDAL RESISTANCE AND MINIMUM MAINTENANCE REQUIREMENT.
- RESISTANCE AND MINIMUM MAINTENANCE REQUIREMENT.
  2. THE SYSTEM IS A COMBINATION OF OVERHEAD SPRINKLER AND SUBSURFACE IRRIGATION AS APPROPRIATE TO PLANT TYPE, EXPOSURE AND SLOPE
- 3. CONTROL OF THE SYSTEM IS VIA A WEATHER-ENABLED CONTROLLER CAPABLE OF DAILY SELF-ADJUSTMENT BASED ON REAL-TIME WEATHER CONDITIONS AS MEASURED BY AN ON-SITE WEATHER SENSOR.
- MICHAGINED BY AN OUTSILE WEATHER SENON.

  4. THE SYSTEM INCLUDES A MASTER CONTROL VALVE AND FLOW SENSING
  CAPABILITY WHICH WILL SHUT DOWN ALL OR PART OF THE SYSTEM IF LEAKS
- ARE DETECTED.

  5. THE LANDSCAPE IS OVER 2,500 SQUARE FEET OF NEW LANDSCAPING AND WILL MEET THE REQUIRMENTS OF THE WATER EFFICIENCY LANDSCAPE ORDINANCE (WELO): HTTPS://WATER.CA.GOV/LEGACYFILES/WATERUSEEFFICIENCY/DOCS/MWEL009-1

#### **MWELO CONFORMANCE STATEMENT**

I HAVE COMPLIED WITH THE CRITERIA OF ARTICLE 19 OF THE ZONING CODE, INCLUDING ALL DESIGN STANDARDS OF SECTION 4-1908, AND APPLIED THEM FOR THE EFFICIENT USE OF WATER IN THE LANDSCAPE DESIGN PLAN.

AS ATTESTED BY PROJECT LANDSCAPE ARCHITECT

#### **BAY-FRIENDLY LANDSCAPE PRACTICES NOTES**

LANDSCAPE DESIGN TO COMPLY WITH CITY OF OAKLAND BAY-FREINDLY ORDINANCE, IN ADDITION THE NINE REQUIRED PRACTICES ARE SUMMARIZED

- 1 MULCH ALL SHRUB AREAS WITH 3 INCH THICK LAYER OF MULCH, ALL SOIL ON SITE IS PROTECTED WITH A MINIMUM OF 3 INCHES OF MULCH AFTER CONSTRUCTION ALL MULCH IS ARBOR WASTE MATERIAL
- 2. AMEND SOIL WITH COMPOST BEFORE PLANTING. COMPOST IS SPECIFIED AS THE SOIL AMENDMENT, AT THE RATES INDICATED BY A SOIL ANALYSIS TO BRING THE SOIL ORGANIC MATTER CONTENT TO A MINIMUM OF 3.5% BY DRY WEIGHT OR 1 INCH OF COMPOST, OPTION 1: REQUIRE IMPORT TOPSOIL TO MEET ORGANIC MATTER CONTENT OF A MINIMUM 3.5% BY DRY WEIGHT. OPTION 2: SUBMIT SOILS REPORT THAT IDENTIFIES EXISTING TOPSOIL MEETS ORGANIC MATTER CONTENT OF 3.5% BY DRY WEIGHT OR GREATER.
  REDUCE AND RECYCLE LANDSCAPE CONSTRUCTION WASTE. DIVERT 50% OF
- LANDSCAPE CONSTRUCTION AND DEMOLITION WASTE BY VOLUME OR WEIGHT 4. CHOOSE AND LOCATE PLANTS THAT GROW TO NATURAL SIZE AND AVOID
- SHEARING, NO PLANT SPECIES WILL REQUIRE SHEARING, SELECT SPECIES AND SPACING TO ALLOW PLANTS TO GROW TO NATURAL SIZE AND SHAPE WITHOUT SHEARING AT ANY POINT IN THE LIFESPAN OF THE PLANT, EXCLUDING STRUCTURAL AND REGULAR MAINTENANCE.

  5. DO NOT PLANT INVASIVE SPECIES, NONE OF THE PLANT SPECIES LISTED BY
- CAS-IPC AS INVASIVE IN THE SAN FRANCISCO, BAY AREA ARE INCLUDED IN THE PLANTING DESIGN.
- GROW DROUGHT TOLERANT CALIFORNIA NATIVE, MEDITERRANEAN OR CLIMATE ADAPTED PLANTS. A MINIMUM OF 75% OF THE TOTAL NUMBER OF PLANTS IN THE NON-TURF AREAS MUST BE SPECIES THAT REQUIRE NO OR LITTLE SUMMER WATERING ONCE ESTABLISHED. SPECIES SHOULD BE ADAPTED TO THE CLIMATE IN WHICH THEY WILL BE PLANTED, AS REFERENCED BY A THIRD PARTY SOURCE. PLANT SHALL BE RATED FOR MODERATE OR OCCASIONAL WATER USE FOR THIS REGION AND CLIMATE.
- MINIMIZE TURF.A MAXIMUM OF 25% OF TOTAL IRRIGATED AREA IS SPECIFIED AS TURF. WITH SPORTS OR MULTI-USE FIELDS EXEMPTED.
- SPECIFY AUTOMATIC WEATHER-BASED CONTROLLER WITH SOIL MOISTURE AND/OR RAIN SENSOR A WEATHER-BASED IRRIGATION CONTROLLERS, SOIL MOISTURE BASED CONTROLLERS, OR OTHER SELF-ADJUSTING IRRIGATION CONTROLLERS, SHALL BE REQUIRED FOR ENTIRE IRRIGATION SYSTEM.
- SPRINKLER AND SPRAY HEADS ARE NOT SPECIFIED IN AREAS LESS THAN 8 FEET WIDE.SPRINKLER AND SPRAY HEADS ARE NOT SPECIFIED IN AREAS LESS THAN OR EQUAL TO 8 FEET WIDE TO PREVENT OVERSPRAY AND RUNOFF.
  ACCEPTABLE ALTERNATIVES INCLUDE BUBBLER OR DRIP WITH SUBSURFACE RIGID LATERAL PIPES. BUBBLERS SHALL NOT EXCEED 1.5 GALLONS PER MINUTE PER BUBBLER.

## ARCHITEC

#### **PGAdesign**

Parcel A


JOB NO. 00275 DRAWN DC,KK CHECKED KK KK JOB CAPTAIN

DATE PLANNING SUBMISSION 03/08/19

DRAWING TITLE

Podium Level Plant Palette & Planting Guidelines

1" = 10'-0"

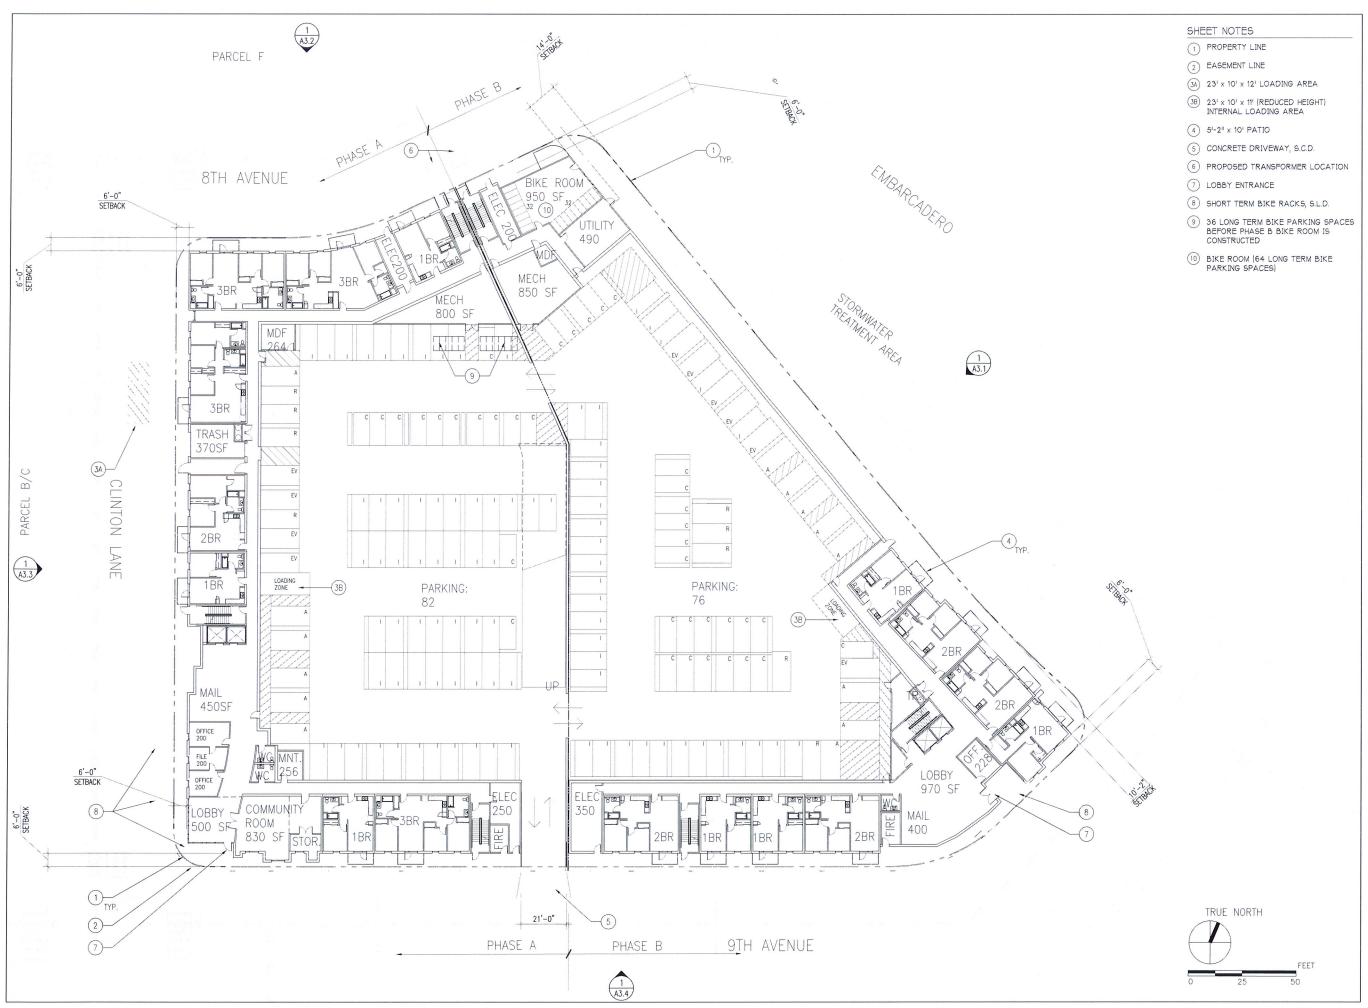

#### BROOKLYN BASIN PARCEL A

OAKLAND, CALIFORNIA

JOB NO. 00275 DRAWN 0M

CHECKED


JOB CAPTAIN PM

11/19/18 PLANNING SUBMISSION 02/15/19 DESIGN REVIEW 02/27/19 PLANNING REVIEW 03/07/19 PLANNING RESUBMITTAL

DRAWING TITLE

SITE & 1ST FLOOR PLAN

LE 1" = 20' - 0"

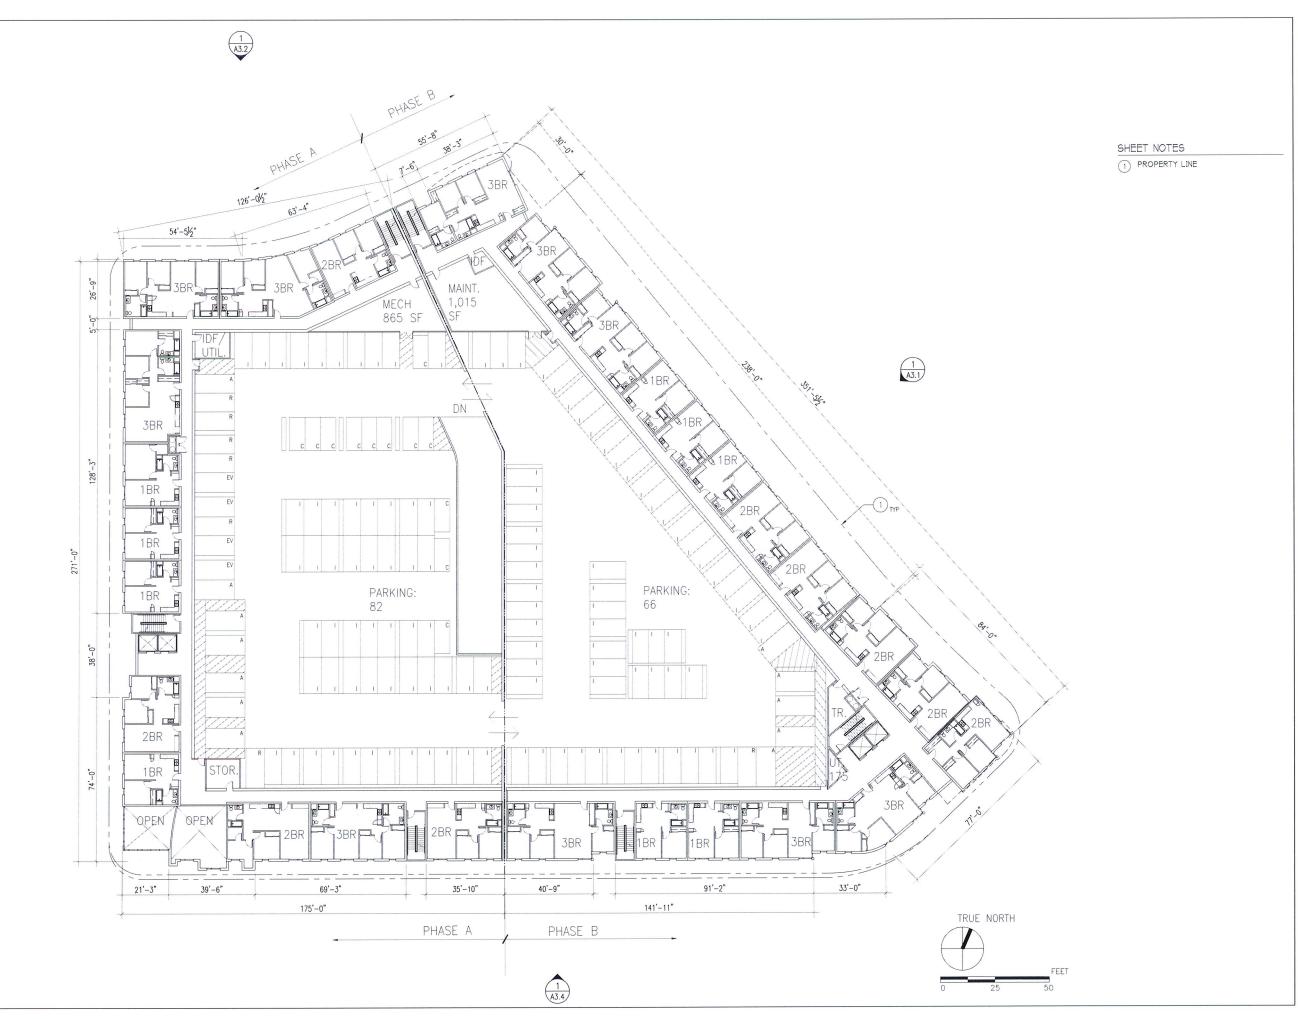

#### BROOKLYN BASIN PARCEL A

OAKLAND, CALIFORNIA

JOB NO. 002 DRAWN 0M

CHECKED PM
JOB CAPTAIN PM

DATE

11/19/18 PLANNING SUBMISSION 02/15/19 DESIGN REVIEW 02/27/19 PLANNING REVIEW 03/07/19 PLANNING RESUBMITTAL

DRAWING TITLE

2ND FLOOR PLAN

LE 1'' = 20' - 0''

#### BROOKLYN BASIN PARCEL A

OAKLAND, CALIFORNIA

JOB NO. 00275

DRAWN OM CHECKED PM

JOB CAPTAIN PM


11/19/18 PLANNING SUBMISSION 02/15/19 DESIGN REVIEW 02/27/19 PLANNING REVIEW 03/07/19 PLANNING RESUBMITTAL

DRAWING TITLE

3RD FLOOR PLAN

CALE 1" = 20' -



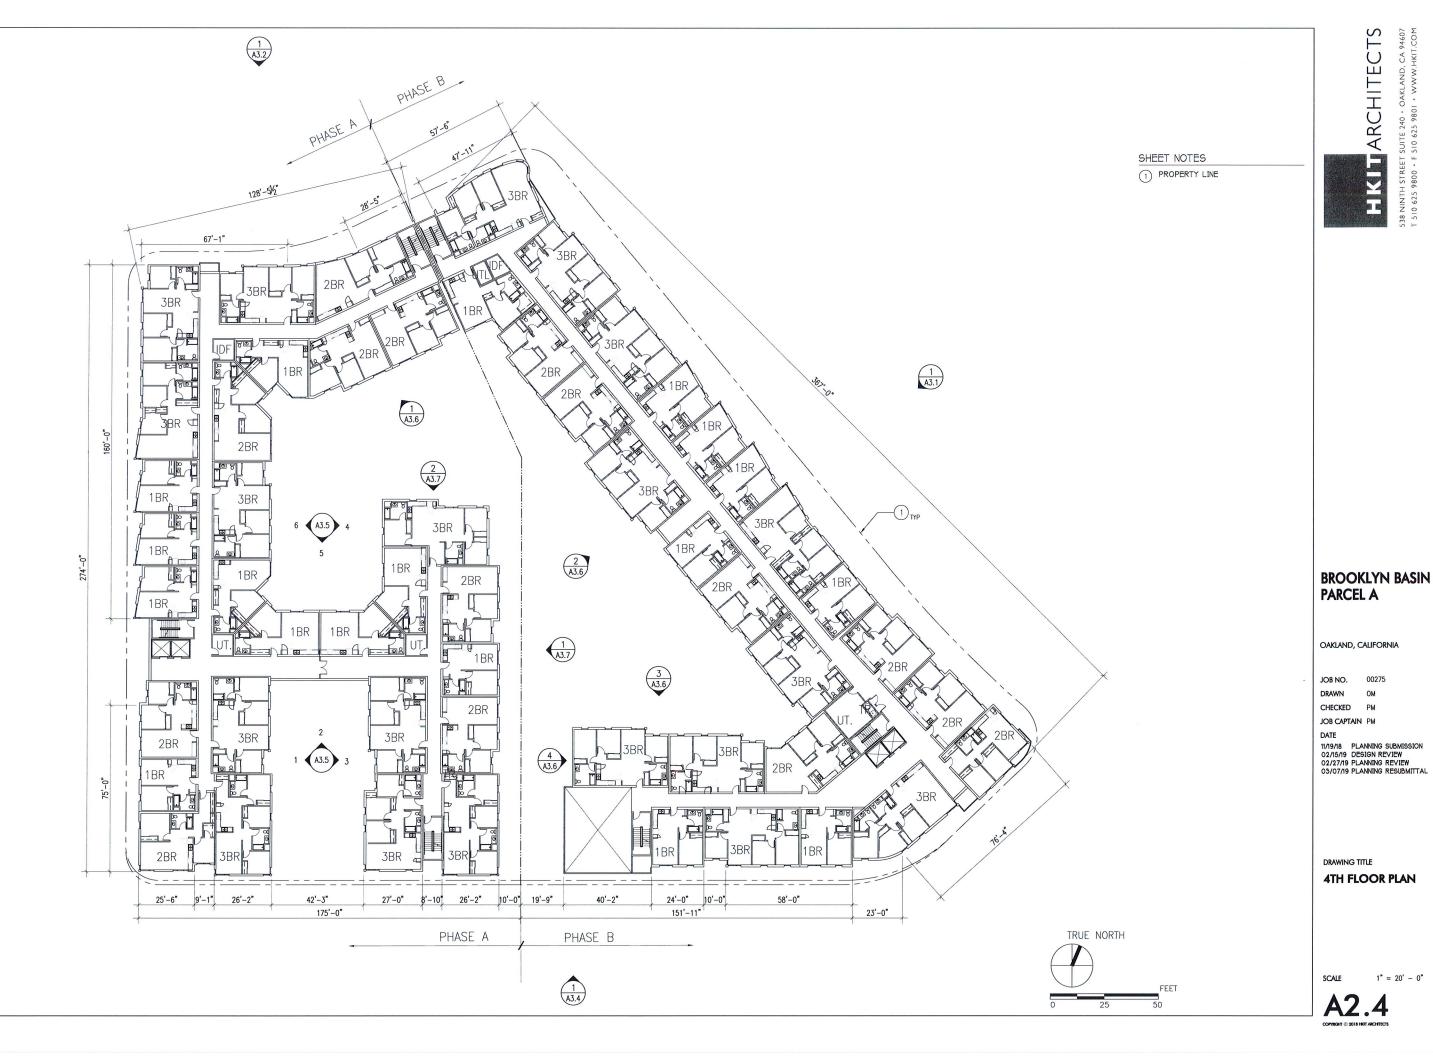


DRAWING TITLE

4TH FLOOR PLAN

1" = 20' - 0"



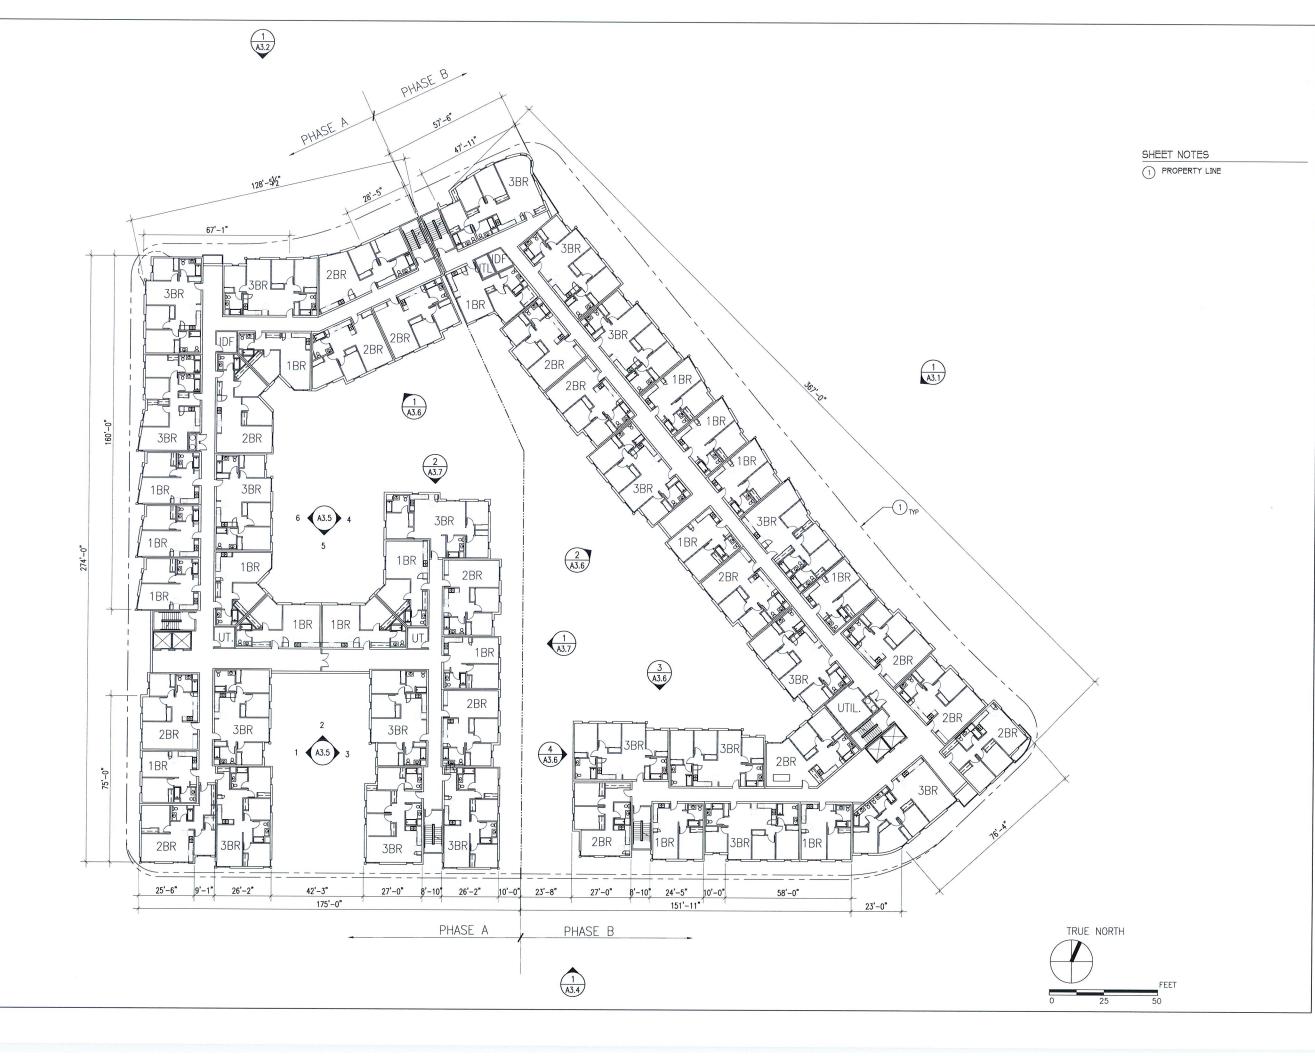

#### BROOKLYN BASIN PARCEL A

OAKLAND, CALIFORNIA

JOB NO. 0027

CHECKED PM


JOB CAPTAIN PM

11/19/18 PLANNING SUBMISSION 02/15/19 DESIGN REVIEW 02/27/19 PLANNING REVIEW 03/07/19 PLANNING RESUBMITTAL

DRAWING TITLE

5TH FLOOR PLAN

ALE 1" = 20' -

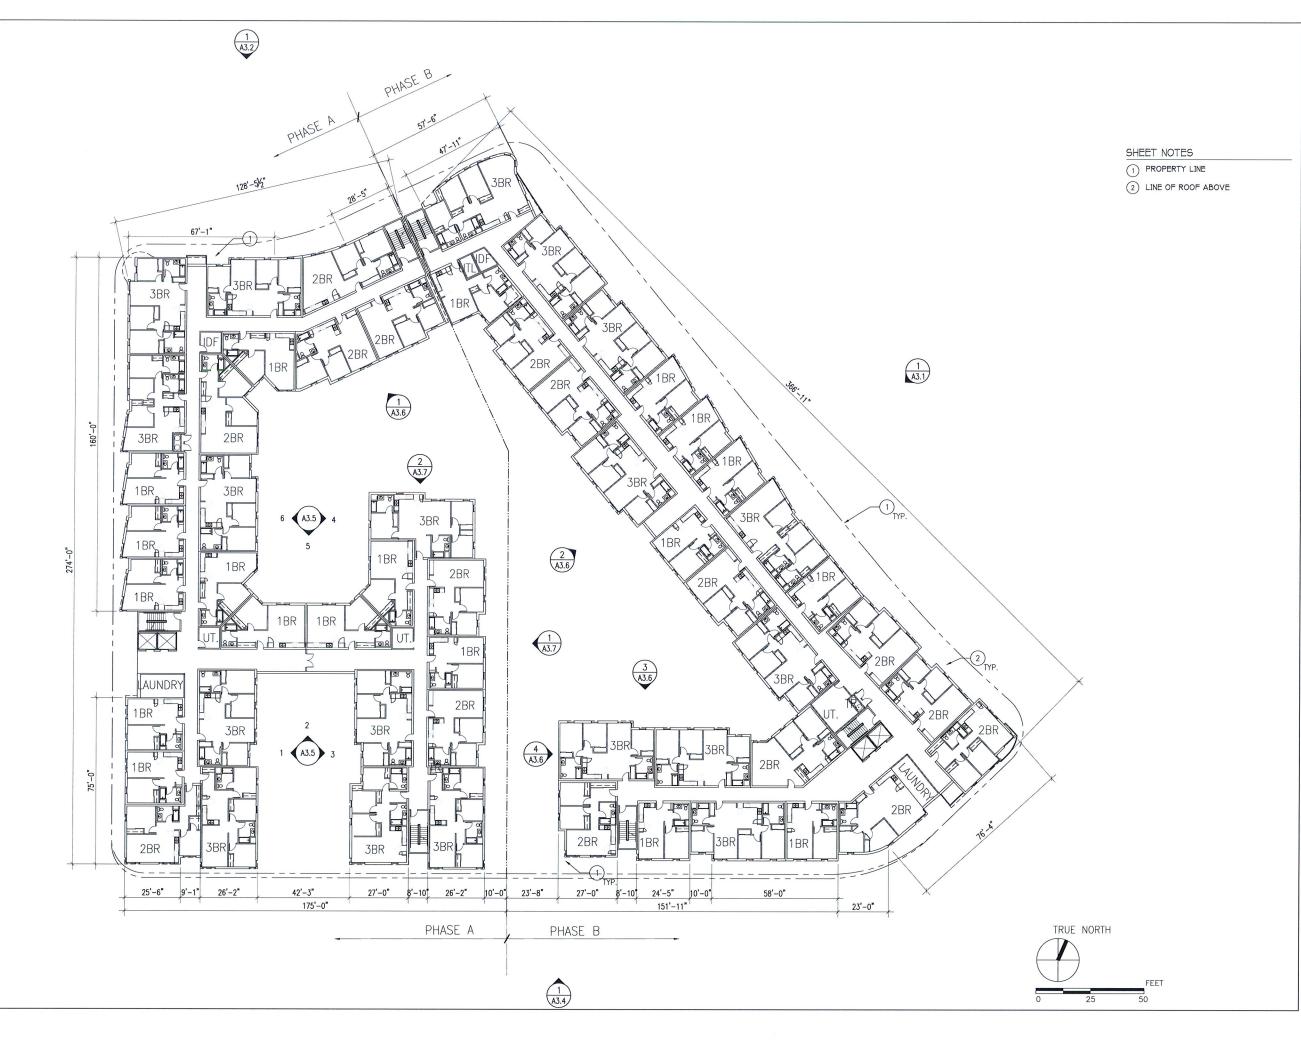

#### BROOKLYN BASIN PARCEL A

OAKLAND, CALIFORNIA

JOB NO. 00

CHECKED PM


JOB CAPTAIN PM DATE

11/19/18 PLANNING SUBMISSION
02/15/19 DESIGN REVIEW
02/27/19 PLANNING REVIEW
03/07/19 PLANNING RESUBMITTAL

DRAWING TITLE

6TH FLOOR PLAN

SCALE 1" = 20' - 0"

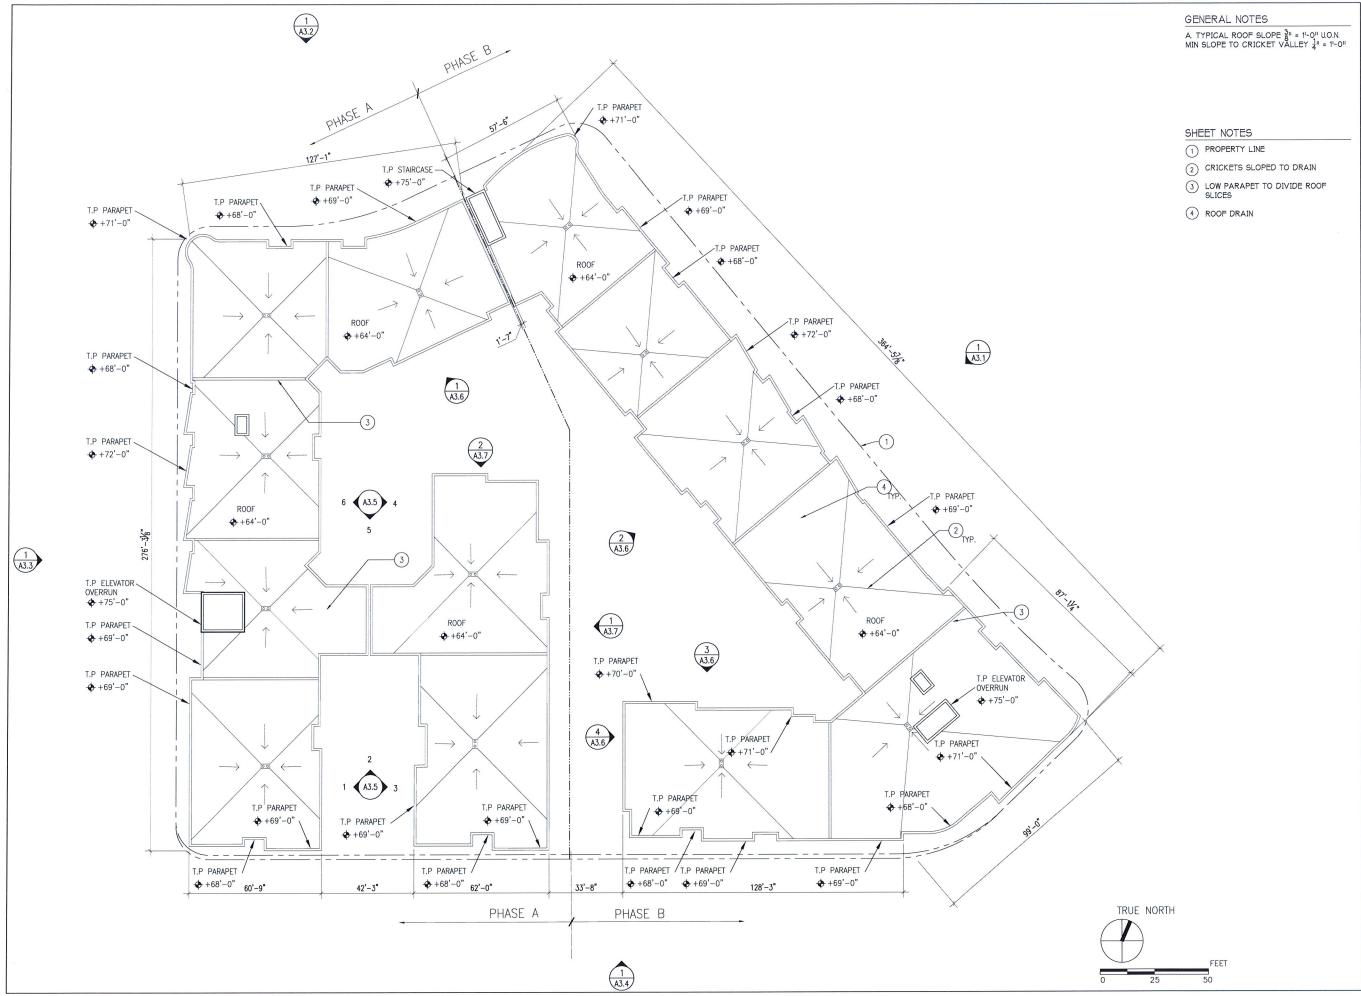

#### BROOKLYN BASIN PARCEL A

OAKLAND, CALIFORNIA

JOB NO. 00275

DRAWN (CHECKED

JOB CAPTAIN PM DATE

11/19/18 PLANNING SUBMISSION 02/15/19 DESIGN REVIEW 02/27/19 PLANNING REVIEW 03/07/19 PLANNING RESUBMITTAL

DRAWING TITLE

**ROOF PLAN** 

ALE 1" = 20' -



#### **ELEVATION NOTES**

- (1) GRADE, S.C.D.
- (2A) PATIO LIGHT FIXTURE
- 2B BUILDING LIGHT FIXTURE
- 3 CONTINUOUS ALUMINUM EXPANSION JOINT COVER FINISH TO MATCH ADJACENT WALL
- 4 ENTRY SIGNAGE. 11 HIGH BRUSHED CLEAR ANODIZED ALUMINUM LETTERS
- (5) ALUMINUM HORIZONTAL SUNSHADE
- 6 ELEVATOR PENTHOUSE
- 7 JULIET BALCONY
- 8 DECORATIVE PERFORATED METAL SCREENS AT GARAGE OPENINGS
- (9) METAL CANOPY OVER ENTRANCE

<b>EXTERIOR</b>	FINISH	LEGEN

MARK	MATERIAL	LOCATION	FINISH/COLOR (REFER TO COLOR/MATERIAL BOARD)
AL-10	ALUMINUM STOREFRONT	LOBBY AND COMMUNITY ROOM	DARK BRONZE
(AL-11)	ALUMINUM	HORIZONTAL SUN SHADE	POWDER COATED PERFORATED PANEL - (BOK OR SIMILAR, SHADOW GRAY)
AL-12)	ALUMINUM	GARAGE DOOR AND OPENING SCREENS	POWDER COATED PERFORATED PANEL - (BOK OR SIMILAR, DARK BRONZE)
AL-13	ALUMINUM	BALCONY RAILINGS AND PATIO FENCES	POWDER COATED PERFORATED PANEL - (BOK OR SIMILAR, SHADOW GRAY)
AL-14	ALUMINUM	ENTRY AWNINGS	DARK BRONZE
(W-10)	VINYL WINDOWS	UNIT WINDOWS	WHITE
(VW-11)	VINYL WINDOWS	UNIT WINDOWS	BLACK
FC-10	FIBER CEMENT PANEL	EXTERIOR WALLS @ ENTRY SIGNAGE WALL & COMMUNITY ROOM	COLOR 4
FC-11	FIBER CEMENT PANEL	EXTERIOR WALLS @ BAYS	COLOR 5
(FC-12)	FIBER CEMENT PANEL	EXTERIOR WALLS @ CORNERS	COLOR 6
(FC-13)	FIBER CEMENT PANEL	EXTERIOR WALLS @ CORNERS	COLOR 5
FC-14	FIBER CEMENT PANEL	EXTERIOR WALLS @ CORNER	COLOR 7
(P-11)	CEMENT PLASTER	EXTERIOR WALLS - MAIN BODY	COLOR 1
(CP-12)	CEMENT PLASTER	EXTERIOR WALLS - BASE	COLOR 2
(CP-13)	CEMENT PLASTER	EXTERIOR WALLS - BASE ACCENTS & RECESSES	COLOR 3
(P-14)	CEMENT PLASTER	EXTERIOR WALLS - BASE ACCENTS & PATIO DOORS	COLOR 4
(P-15)	CEMENT PLASTER	EXTERIOR WALLS - COURTYARD ACCENTS	COLOR 5

#### **BROOKLYN BASIN** PARCEL A

OAKLAND, CALIFORNIA

JOB NO. 00275 DRAWN OM / VB / HC CHECKED

JOB CAPTAIN PM

DATE 11/19/18 PLANNING SUBMISSION 02/15/19 DESIGN REVIEW 02/27/19 PLANNING REVIEW 03/07/19 PLANNING RESUBMITTAL 03/28/19 DRC HEARING

DRAWING TITLE

**EXTERIOR ELEVATIONS** 

1/16" = 1' - 0"



LOCATION

## 8TH AVENUE ELEVATION SCALE: 1/16" = 1'-0"

#### **ELEVATION NOTES**

1 GRADE, S.C.D.

(2A) PATIO LIGHT FIXTURE

(2B) BUILDING LIGHT FIXTURE

3 CONTINUOUS ALUMINUM EXPANSION JOINT COVER FINISH TO MATCH ADJACENT WALL

4 ENTRY SIGNAGE. 11 HIGH BRUSHED CLEAR ANODIZED ALUMINUM LETTERS

5 ALUMINUM HORIZONTAL SUNSHADE

6 ELEVATOR PENTHOUSE

7 JULIET BALCONY

8 DECORATIVE PERFORATED METAL SCREENS AT GARAGE OPENINGS

9 METAL CANOPY OVER ENTRANCE

#### EXTERIOR FINISH LEGEND

MATERIAL

AL-10	ALUMINUM STOREFRONT	LOBBY AND COMMUNITY ROOM	DARK BRONZE
AL-11)	ALUMINUM	HORIZONTAL SUN SHADE	POWDER COATED PERFORATED PANEL - (BOK OR SIMILAR, SHADOW GRAY)
AL-12)	ALUMINUM	GARAGE DOOR AND OPENING SCREENS	POWDER COATED PERFORATED PANEL - (BOK OR SIMILAR, DARK BRONZE)
AL-13)	ALUMINUM	BALCONY RAILINGS AND PATIO FENCES	POWDER COATED PERFORATED PANEL - (BOK OR SIMILAR, SHADOW GRAY)
AL-14)	ALUMINUM	ENTRY AWNINGS	DARK BRONZE
(W-10)	VINYL WINDOWS	UNIT WINDOWS	WHITE
(W-11)	VINYL WINDOWS	UNIT WINDOWS	BLACK
FC-10	FIBER CEMENT PANEL	EXTERIOR WALLS @ ENTRY SIGNAGE WALL & COMMUNITY ROOM	COLOR 4
FC-11)	FIBER CEMENT PANEL	EXTERIOR WALLS @ BAYS	COLOR 5
(FC-12)	FIBER CEMENT PANEL	EXTERIOR WALLS @ CORNERS	COLOR 6
(FC-13)	FIBER CEMENT PANEL	EXTERIOR WALLS @ CORNERS	COLOR 5
FC-14	FIBER CEMENT PANEL	EXTERIOR WALLS @ CORNER	COLOR 7
(CP-11)	CEMENT PLASTER	EXTERIOR WALLS - MAIN BODY	COLOR 1
(CP-12)	CEMENT PLASTER	EXTERIOR WALLS - BASE	COLOR 2
(P-13)	CEMENT PLASTER	EXTERIOR WALLS - BASE ACCENTS & RECESSES	COLOR 3
(CP-14)	CEMENT PLASTER	EXTERIOR WALLS - BASE ACCENTS & PATIO DOORS	COLOR 4
(CP-15)	CEMENT PLASTER	EXTERIOR WALLS - COURTYARD ACCENTS	COLOR 5

FINISH/COLOR (REFER TO COLOR/MATERIAL BOARD)

#### BROOKLYN BASIN PARCEL A

OAKLAND, CALIFORNIA

200,407.5

JOB NO. 00275

DRAWN OM / VB / HC

CHECKED

JOB CAPTAIN PM DATE

1/19/18 PLANNING SUBMISSION 02/15/19 DESIGN REVIEW 02/27/19 PLANNING REVIEW 03/07/19 PLANNING RESUBMITTAL 03/28/19 DRC HEARING

DRAWING TITLE

EXTERIOR ELEVATIONS

CALE

1/16" = 1' - 0"



LOCATION

**CLINTON LANE ELEVATION** 

#### **ELEVATION NOTES**

- (1) GRADE, S.C.D.
- (2A) PATIO LIGHT FIXTURE
- (2B) BUILDING LIGHT FIXTURE
- 3 CONTINUOUS ALUMINUM EXPANSION JOINT COVER FINISH TO MATCH ADJACENT WALL
- 4 ENTRY SIGNAGE. 11 HIGH BRUSHED CLEAR ANODIZED ALUMINUM LETTERS
- 5 ALUMINUM HORIZONTAL SUNSHADE
- 6 ELEVATOR PENTHOUSE
- 7 JULIET BALCONY
- 8 DECORATIVE PERFORATED METAL SCREENS AT GARAGE OPENINGS
- 9 METAL CANOPY OVER ENTRANCE

#### EXTERIOR FINISH LEGEND

MATERIAL

(AL-10)	ALUMINUM STOREFRONT	LOBBY AND COMMUNITY ROOM	DARK BRONZE
AL-11)	ALUMINUM	HORIZONTAL SUN SHADE	POWDER COATED PERFORATED PANEL - (BOK OR SIMILAR, SHADOW GRAY)
AL-12)	ALUMINUM	GARAGE DOOR AND OPENING SCREENS	POWDER COATED PERFORATED PANEL - (BOK OR SIMILAR, DARK BRONZE)
(AL-13)	ALUMINUM	BALCONY RAILINGS AND PATIO FENCES	POWDER COATED PERFORATED PANEL - (BOK OR SIMILAR, SHADOW GRAY)
(AL-14)	ALUMINUM	ENTRY AWNINGS	DARK BRONZE
(W-10)	VINYL WINDOWS	UNIT WINDOWS	WHITE
(VW-11)	VINYL WINDOWS	UNIT WINDOWS	BLACK
(FC-10)	FIBER CEMENT PANEL	EXTERIOR WALLS @ ENTRY SIGNAGE WALL & COMMUNITY ROOM	COLOR 4
(FC-11)	FIBER CEMENT PANEL	EXTERIOR WALLS @ BAYS	COLOR 5
FC-12)	FIBER CEMENT PANEL	EXTERIOR WALLS @ CORNERS	COLOR 6
FC-13)	FIBER CEMENT PANEL	EXTERIOR WALLS @ CORNERS	COLOR 5
FC-14	FIBER CEMENT PANEL	EXTERIOR WALLS @ CORNER	COLOR 7
(P-11)	CEMENT PLASTER	EXTERIOR WALLS - MAIN BODY	COLOR 1
(CP-12)	CEMENT PLASTER	EXTERIOR WALLS - BASE	COLOR 2
(P-13)	CEMENT PLASTER	EXTERIOR WALLS - BASE ACCENTS & RECESSES	COLOR 3
(P-14)	CEMENT PLASTER	EXTERIOR WALLS - BASE ACCENTS & PATIO DOORS	COLOR 4
(P-15)	CEMENT PLASTER	EXTERIOR WALLS - COURTYARD ACCENTS	COLOR 5

FINISH/COLOR (REFER TO COLOR/MATERIAL BOARD)

#### **BROOKLYN BASIN** PARCEL A

OAKLAND, CALIFORNIA

JOB NO. 00275 DRAWN OM / VB

CHECKED

JOB CAPTAIN PM

1/19/18 PLANNING SUBMISSION 02/15/19 DESIGN REVIEW 02/27/19 PLANNING REVIEW 03/07/19 PLANNING RESUBMITTAL 03/28/19 DRC HEARING

DRAWING TITLE

**EXTERIOR ELEVATIONS** 

1/16'' = 1' - 0''



LOCATION

**ELEVATION NOTES** 

(1) GRADE, S.C.D.

(2A) PATIO LIGHT FIXTURE

(2B) BUILDING LIGHT FIXTURE

CONTINUOUS ALUMINUM EXPANSION
 JOINT COVER FINISH TO MATCH
 ADJACENT WALL

4 ENTRY SIGNAGE. 11 HIGH BRUSHED CLEAR ANODIZED ALUMINUM LETTERS

(5) ALUMINUM HORIZONTAL SUNSHADE

6 ELEVATOR PENTHOUSE

7 JULIET BALCONY

8 DECORATIVE PERFORATED METAL SCREENS AT GARAGE OPENINGS

9 METAL CANOPY OVER ENTRANCE

<b>EXTERIOR</b>	FINISH	LEGE

MARK

MATERIAL

(AL-10)	ALUMINUM STOREFRONT	LOBBY AND COMMUNITY ROOM	DARK BRONZE
(AL-11)	ALUMINUM	HORIZONTAL SUN SHADE	POWDER COATED PERFORATED PANEL - (BOK OR SIMILAR, SHADOW GRAY)
AL-12)	ALUMINUM	GARAGE DOOR AND OPENING SCREENS	POWDER COATED PERFORATED PANEL - (BOK OR SIMILAR, DARK BRONZE)
AL-13	ALUMINUM	BALCONY RAILINGS AND PATIO FENCES	POWDER COATED PERFORATED PANEL - [BOK OR SIMILAR, SHADOW GRAY]
(AL-14)	ALUMINUM	ENTRY AWNINGS	DARK BRONZE
(W-10)	VINYL WINDOWS	UNIT WINDOWS	WHITE
(VW-11)	VINYL WINDOWS	UNIT WINDOWS	BLACK
(FC-10)	FIBER CEMENT PANEL	EXTERIOR WALLS @ ENTRY SIGNAGE WALL & COMMUNITY ROOM	COLOR 4
(FC-11)	FIBER CEMENT PANEL	EXTERIOR WALLS @ BAYS	COLOR 5
(FC-12)	FIBER CEMENT PANEL	EXTERIOR WALLS @ CORNERS	COLOR 6
(FC-13)	FIBER CEMENT PANEL	EXTERIOR WALLS @ CORNERS	COLOR 5
FC-14)	FIBER CEMENT PANEL	EXTERIOR WALLS @ CORNER	COLOR 7
(P-11)	CEMENT PLASTER	EXTERIOR WALLS - MAIN BODY	COLOR 1
(CP-12)	CEMENT PLASTER	EXTERIOR WALLS - BASE	COLOR 2
(P-13)	CEMENT PLASTER	EXTERIOR WALLS - BASE ACCENTS & RECESSES	COLOR 3
(P-14)	CEMENT PLASTER	EXTERIOR WALLS - BASE ACCENTS & PATIO DOORS	COLOR 4
(CP-15)	CEMENT PLASTER	EXTERIOR WALLS - COURTYARD ACCENTS	COLOR 5

FINISH/COLOR (REFER TO COLOR/MATERIAL BOARD)

#### BROOKLYN BASIN PARCEL A

OAKLAND, CALIFORNIA

JOB NO. 00275

DRAWN OM / VB

CHECKED .

JOB CAPTAIN PM DATE


1/19/18 PLANNING SUBMISSION 02/15/19 DESIGN REVIEW 02/27/19 PLANNING REVIEW 03/07/19 PLANNING RESUBMITTAL 03/28/19 DRC HEARING


DRAWING TITLE

**EXTERIOR ELEVATIONS** 

CALE 1/16" = 1' - 0"



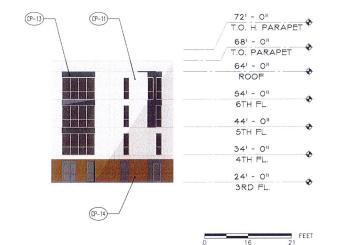

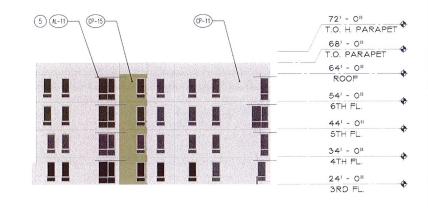



## 3 COURTYARD ELEVATION - SCALE: 1/16" = 1'-0"


SCALE : 1/16" = 1'-0'

FINISH/COLOR (REFER TO COLOR/MATERIAL BOARD)

## COURTYARD ELEVATION SCALE: 1/16" = 1'-0"

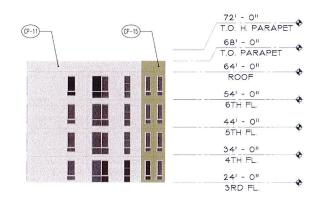

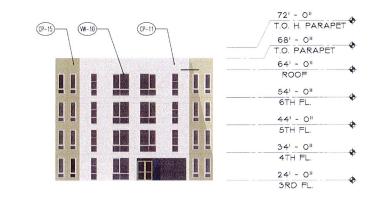

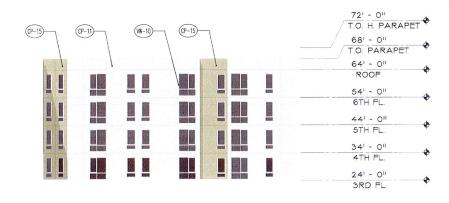

## COURTYARD ELEVATION

## 4 COURTYARD ELEVATION SCALE: 1/16" = 1'-0"

#### **ELEVATION NOTES**

(1) GRADE, S.C.D.

2A PATIO LIGHT FIXTURE

2B) BUILDING LIGHT FIXTURE

3 CONTINUOUS ALUMINUM EXPANSION JOINT COVER FINISH TO MATCH ADJACENT WALL

4 ENTRY SIGNAGE. 11 HIGH BRUSHED CLEAR ANODIZED ALUMINUM LETTERS

5 ALUMINUM HORIZONTAL SUNSHADE

6 ELEVATOR PENTHOUSE

(7) JULIET BALCONY

8 DECORATIVE PERFORATED METAL SCREENS AT GARAGE OPENINGS

(9) METAL CANOPY OVER ENTRANCE

## 5 COURTYARD ELEVATION SCALE: 1/16" = 1'-0"

LOCATION

**COURTYARD ELEVATION** 

SCALE : 1/16" = 1'-0'

EXTERIOR FIN	ISH LEGEND	

MATERIAL

MARK

(AL-10)	ALUMINUM STOREFRONT	LOBBY AND COMMUNITY ROOM	DARK BRONZE
(AL-11)	ALUMINUM	HORIZONTAL SUN SHADE	POWDER COATED PERFORATED PANEL - (BOK OR SIMILAR, SHADOW GRAY)
AL-12)	ALUMINUM	GARAGE DOOR AND OPENING SCREENS	POWDER COATED PERFORATED PANEL - (BOK OR SIMILAR, DARK BRONZE)
AL-13)	ALUMINUM	BALCONY RAILINGS AND PATIO FENCES	POWDER COATED PERFORATED PANEL - (BOK OR SIMILAR, SHADOW GRAY)
(AL-14)	ALUMINUM	ENTRY AWNINGS	DARK BRONZE
(W-10)	VINYL WINDOWS	UNIT WINDOWS	WHITE
(W-11)	VINYL WINDOWS	UNIT WINDOWS	BLACK
(FC-10)	FIBER CEMENT PANEL	EXTERIOR WALLS @ ENTRY SIGNAGE WALL & COMMUNITY ROOM	COLOR 4
(FC-11)	FIBER CEMENT PANEL	EXTERIOR WALLS @ BAYS	COLOR 5
(FC-12)	FIBER CEMENT PANEL	EXTERIOR WALLS @ CORNERS	COLOR 6
FC-13	FIBER CEMENT PANEL	EXTERIOR WALLS @ CORNERS	COLOR 5
FC-14	FIBER CEMENT PANEL	EXTERIOR WALLS @ CORNER	COLOR 7
(CP-11)	CEMENT PLASTER	EXTERIOR WALLS - MAIN BODY	COLOR 1
(CP-12)	CEMENT PLASTER	EXTERIOR WALLS - BASE	COLOR 2
(P-13)	CEMENT PLASTER	EXTERIOR WALLS - BASE ACCENTS & RECESSES	COLOR 3
(P-14)	CEMENT PLASTER	EXTERIOR WALLS - BASE ACCENTS & PATIO DOORS	COLOR 4
(CP-15)	CEMENT PLASTER	EXTERIOR WALLS - COURTYARD ACCENTS	COLOR 5

## PARCEL A

OAKLAND, CALIFORNIA

JOB NO. 00275

DRAWN OM / VB

CHECKED .

JOB CAPTAIN PM

JOB CAPTAIN DATE


11/19/18 PLANNING SUBMISSION 02/15/19 DESIGN REVIEW 02/27/19 PLANNING REVIEW 03/07/19 PLANNING RESUBMITTAL 03/28/19 DRC HEARING


**BROOKLYN BASIN** 

DRAWING TITLE

**EXTERIOR ELEVATIONS** 


SCALE 1/16" = 1' - 0"

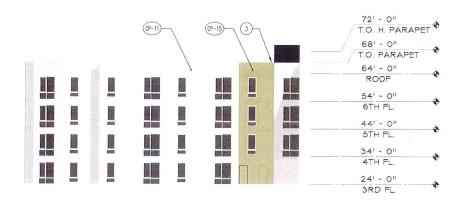


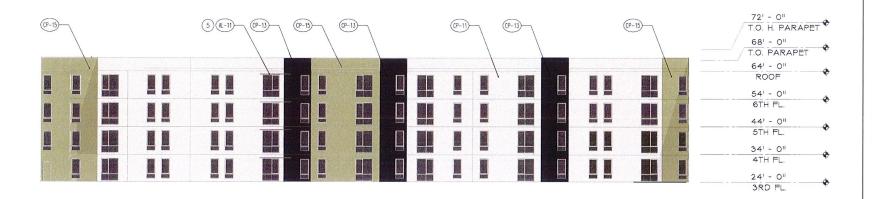

COURTYARD ELEVATION
SCALE: 1/16" = 1'-0"

2 COURTYARD ELEVATION

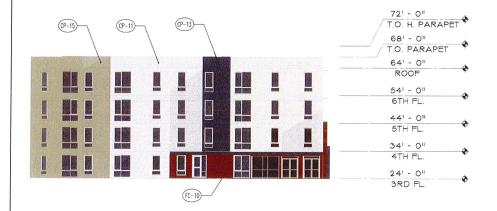

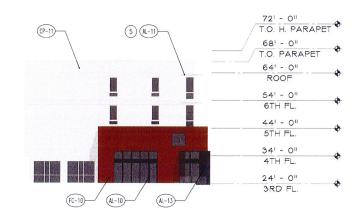

COURTYARD ELEVATION

SCALE: 1/16" = 1'-0"

COURTYARD ELEVATION
SCALE: 1/16" = 1'-0"

#### **ELEVATION NOTES**

- 1 GRADE, S.C.D.
- (2A) PATIO LIGHT FIXTURE
- (2B) BUILDING LIGHT FIXTURE
- 3 CONTINUOUS ALUMINUM EXPANSION JOINT COVER FINISH TO MATCH ADJACENT WALL
- 4 ENTRY SIGNAGE. 11 HIGH BRUSHED CLEAR ANODIZED ALUMINUM LETTERS
- (5) ALUMINUM HORIZONTAL SUNSHADE
- 6 ELEVATOR PENTHOUSE
- 7 JULIET BALCONY
- 8 DECORATIVE PERFORATED METAL SCREENS AT GARAGE OPENINGS
- 9 METAL CANOPY OVER ENTRANCE

#### EXTERIOR FINISH LEGEND

MARK	MATERIAL	LOCATION	FINISH/COLOR (REFER TO COLOR/MATERIAL BOARD)
AL-10	ALUMINUM STOREFRONT	LOBBY AND COMMUNITY ROOM	DARK BRONZE
(AL-11)	ALUMINUM	HORIZONTAL SUN SHADE	POWDER COATED PERFORATED PANEL - (BOK OR SIMILAR, SHADOW GRAY)
AL-12)	ALUMINUM	GARAGE DOOR AND OPENING SCREENS	POWDER COATED PERFORATED PANEL - [BOK OR SIMILAR, DARK BRONZE]
(AL-13)	ALUMINUM	BALCONY RAILINGS AND PATIO FENCES	POWDER COATED PERFORATED PANEL - (BOK OR SIMILAR, SHADOW GRAY)
AL-14	ALUMINUM	ENTRY AWNINGS	DARK BRONZE
(VW-10)	VINYL WINDOWS	UNIT WINDOWS	WHITE
(W-11)	VINYL WINDOWS	UNIT WINDOWS	BLACK
(FC-10)	FIBER CEMENT PANEL	EXTERIOR WALLS @ ENTRY SIGNAGE WALL & COMMUNITY ROOM	COLOR 4
(FC-11)	FIBER CEMENT PANEL	EXTERIOR WALLS @ BAYS	COLOR 5
FC-12)	FIBER CEMENT PANEL	EXTERIOR WALLS @ CORNERS	COLOR 6
FC-13)	FIBER CEMENT PANEL	EXTERIOR WALLS @ CORNERS	COLOR 5
FC-14)	FIBER CEMENT PANEL	EXTERIOR WALLS @ CORNER	COLOR 7
(CP-11)	CEMENT PLASTER	EXTERIOR WALLS - MAIN BODY	COLOR 1
(CP-12)	CEMENT PLASTER	EXTERIOR WALLS - BASE	COLOR 2
(P-13)	CEMENT PLASTER	EXTERIOR WALLS - BASE ACCENTS & RECESSES	COLOR 3
(CP-14)	CEMENT PLASTER	EXTERIOR WALLS - BASE ACCENTS & PATIO DOORS	COLOR 4
(P-15)	CEMENT PLASTER	EXTERIOR WALLS - COURTYARD ACCENTS	COLOR 5

#### BROOKLYN BASIN PARCEL A

OAKLAND, CALIFORNIA

JOB NO. 00275

DRAWN ON CHECKED .

JOB CAPTAIN PM


DATE

11/19/18 PLANNING SUBMISSION 02/15/19 DESIGN REVIEW 02/27/19 PLANNING REVIEW 03/07/19 PLANNING RESUBMITTAL 03/28/19 DRC HEARING

DRAWING TITLE


**EXTERIOR ELEVATIONS** 

E 1/16" = 1' - 0"

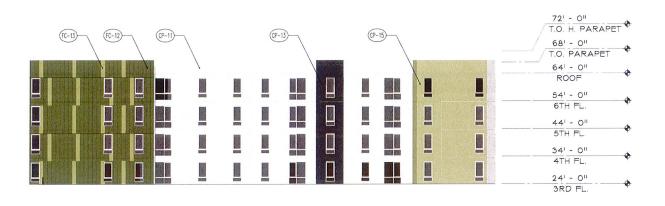

FEET

#### **COURTYARD ELEVATION** SCALE : 1/16" = 1'-0'

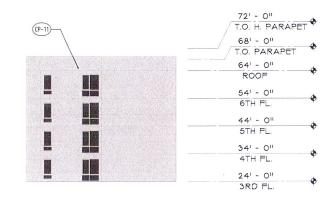



LOCATION

### COURTYARD ELEVATION

#### **ELEVATION NOTES**

- 1 GRADE, S.C.D.
- (2A) PATIO LIGHT FIXTURE
- (2B) BUILDING LIGHT FIXTURE
- 3 CONTINUOUS ALUMINUM EXPANSION JOINT COVER FINISH TO MATCH ADJACENT WALL
- 4 ENTRY SIGNAGE. 11 HIGH BRUSHED CLEAR ANODIZED ALUMINUM LETTERS
- 5 ALUMINUM HORIZONTAL SUNSHADE
- 6 ELEVATOR PENTHOUSE
- 7 JULIET BALCONY
- 8 DECORATIVE PERFORATED METAL SCREENS AT GARAGE OPENINGS
- (9) METAL CANOPY OVER ENTRANCE

#### EXTERIOR FINISH LEGEND

MARK MATERIAL

AL-10)	ALUMINUM STOREFRONT	LOBBY AND COMMUNITY ROOM	DARK BRONZE
(AL-11)	ALUMINUM	HORIZONTAL SUN SHADE	POWDER COATED PERFORATED PANEL - (BOK OR SIMILAR, SHADOW GRAY)
AL-12)	ALUMINUM	GARAGE DOOR AND OPENING SCREENS	POWDER COATED PERFORATED PANEL - (BOK OR SIMILAR, DARK BRONZE)
(AL-13)	ALUMINUM	BALCONY RAILINGS AND PATIO FENCES	POWDER COATED PERFORATED PANEL - (BOK OR SIMILAR, SHADOW GRAY)
(AL-14)	ALUMINUM	ENTRY AWNINGS	DARK BRONZE
(W-10)	VINYL WINDOWS	UNIT WINDOWS	WHITE
(W-11)	VINYL WINDOWS	UNIT WINDOWS	BLACK
(FC-10)	FIBER CEMENT PANEL	EXTERIOR WALLS @ ENTRY SIGNAGE WALL & COMMUNITY ROOM	COLOR 4
(FC-11)	FIBER CEMENT PANEL	EXTERIOR WALLS @ BAYS	COLOR 5
(FC-12)	FIBER CEMENT PANEL	EXTERIOR WALLS @ CORNERS	COLOR 6
(FC-13)	FIBER CEMENT PANEL	EXTERIOR WALLS @ CORNERS	COLOR 5
FC-14	FIBER CEMENT PANEL	EXTERIOR WALLS @ CORNER	COLOR 7
(P-11)	CEMENT PLASTER	EXTERIOR WALLS - MAIN BODY	COLOR 1
(CP-12)	CEMENT PLASTER	EXTERIOR WALLS - BASE	COLOR 2
(CP-13)	CEMENT PLASTER	EXTERIOR WALLS - BASE ACCENTS & RECESSES	COLOR 3
(P-14)	CEMENT PLASTER	EXTERIOR WALLS - BASE ACCENTS & PATIO DOORS	COLOR 4
(P-15)	CEMENT PLASTER	EXTERIOR WALLS - COURTYARD ACCENTS	COLOR 5

FINISH/COLOR (REFER TO COLOR/MATERIAL BOARD)

#### **BROOKLYN BASIN** PARCEL A

OAKLAND, CALIFORNIA

JOB NO. 00275

DRAWN OM / VB

CHECKED

JOB CAPTAIN PM

DATE 1/19/18 PLANNING SUBMISSION 02/15/19 DESIGN REVIEW 02/27/19 PLANNING REVIEW 03/07/19 PLANNING RESUBMITTAL 03/28/19 DRC HEARING

DRAWING TITLE

**EXTERIOR ELEVATIONS** 

1/16" = 1' - 0"



VIEW ALONG EMBARCADERO AND NINTH AVENUE



VIEW ALONG EMBARCADERO AND EIGHTH AVENUE

#### BROOKLYN BASIN PARCEL A

OAKLAND, CALIFORNIA

JOB NO. 00275
DRAWN OM /
CHECKED .

JOB CAPTAIN PM

11/19/18 PLANNING SUBMISSION 02/15/19 DESIGN REVIEW 02/27/19 PLANNING REVIEW 03/07/19 PLANNING RESUBMITTAL

DRAWING TITLE

**PERSPECTIVES** 

E AS N



VIEW ALONG CLINTON LANE AND NINTH AVENUE



VIEW ALONG CLINTON LANE AND EIGHTH AVENUE

#### BROOKLYN BASIN PARCEL A

OAKLAND, CALIFORNIA

JOB NO. 0027 DRAWN OM ,

CHECKED .

JOB CAPTAIN PM

1/1/1/18 PLANNING SUBMISSION 02/15/19 DESIGN REVIEW 02/27/19 PLANNING REVIEW 03/07/19 PLANNING RESUBMITTAL

DRAWING TITLE

**PERSPECTIVES** 

ALE AS I



LOBBY ENTRY PERSPECTIVE (PHASE A)



LOBBY ENTRY AWNING SIGNAGE (PHASE A)



LOBBY ENTRY BLADE SIGNAGE (PHASE A)

AWNING SIGNAGE AREA: 10 SF BLADE SIGNAGE AREA: 10 SF

**TOTAL LOBBY ENTRY SIGNAGE AREA: 20 SF** 

#### BROOKLYN BASIN PARCEL A

OAKLAND, CALIFORNIA

JOB NO. 00237 DRAWN OM CHECKED

JOB CAPTAIN OM

1/1/9/18 PLANNING SUBMISSION 02/15/19 DESIGN REVIEW 02/27/19 PLANNING REVIEW 03/07/19 PLANNING RESUBMITTAL

DRAWING TITLE

SIGNAGE DESIGN (PHASE A)

ALE



LOBBY ENTRY PERSPECTIVE (PHASE B)



LOBBY ENTRY AWNING SIGNAGE (PHASE B)



LOBBY ENTRY BLADE SIGNAGE (PHASE B)

AWNING SIGNAGE AREA: 10 SF **BLADE SIGNAGE AREA:** 10 SF

**TOTAL LOBBY ENTRY SIGNAGE AREA: 20 SF** 

#### **BROOKLYN BASIN** PARCEL A

OAKLAND, CALIFORNIA

JOB NO. 00237 DRAWN

CHECKED JOB CAPTAIN OM


DATE

11/19/18 PLANNING SUBMISSION 02/15/19 DESIGN REVIEW 02/27/19 PLANNING REVIEW 03/07/19 PLANNING RESUBMITTAL

DRAWING TITLE

SIGNAGE DESIGN (PHASE B)



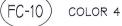

FIBER CEMENT PANEL COLOR: "MARS"



COLOR 5

COLOR 5

FIBER CEMENT PANEL COLOR: "TERRA"




COLOR 6

FIBER CEMENT PANEL COLOR: "MOUNTAIN SAGE"



FC-14 COLOR 7

FIBER CEMENT PANEL COLOR: "CALLISTO"

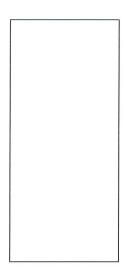


(VW-10)

VINYL WINDOW COLOR: WHITE



VW-11

VINYL WINDOW COLOR: BLACK

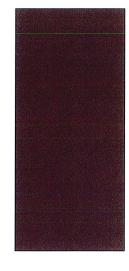


(AL-10)

ALUMINUM STOREFRONT FINISH: DARK BRONZE

AL-14


ENTRY AWNING FINISH: DARK BRONZE

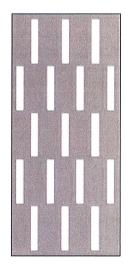

AL-11


AL-13

PERFORATED ALUMINUM FINISH: POWDER COATED SHADOW GRAY

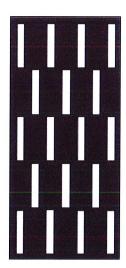

( AL-12 )

PERFORATED <u>ALUMINUM</u> FINISH: POWDER COATED DARK BRONZE

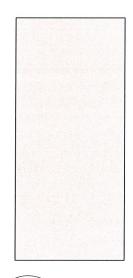

CP-11 COLOR 1

CEMENT PLASTER

FINISH: MEDIUM SAND FINISH COLOR: SHERWIN WILLIAMS COLOR: KELLY MOORE SW6001 GRAYISH



COLOR 2

CEMENT PLASTER

MEDIUM SAND FINISH KM5825 NOT MY FAULT



(CP-13) COLOR 3

CEMENT PLASTER FINISH: MEDIUM SAND FINISH COLOR: KELLY-MOORE KM4890 AFTER MIDNIGHT



CP-14 COLOR 4

CEMENT PLASTER FINISH: MEDIUM SAND FINISH COLOR: "MARS"



CP-15 COLOR 5

CEMENT PLASTER FINISH: MEDIUM SAND FINISH COLOR: "TERRA"



(LF-11

EXTERIOR LIGHTING FIXTURE PIERRE - 11" 11W LED OUTDOOR WALL SCONCE

FINISH: TEXTURED MATTE METAL FINISH COLOR: BLACK

2B - BUILDING LIGHT



LF-10

EXTERIOR LIGHTING FIXTURE CRYSTAL - 11" 120W TBX

LAMP FLUORESCENT WALL WEDGE SCONCE

> FINISH: POWDER COAT COLOR: PEWTER

2A -PATIO LIGHT

#### **BROOKLYN BASIN** PARCEL A

OAKLAND, CALIFORNIA

00237 JOB NO. DRAWN ОМ

CHECKED JOB CAPTAIN OM

11/19/18 PLANNING SUBMISSION 02/15/19 DESIGN REVIEW 02/27/19 PLANNING REVIEW 03/07/19 PLANNING RESUBMITTAL 03/28/19 DRC HEARING

DRAWING TITLE


**COLOR AND MATERIAL BOARD** 

SCALE


COPYRIGHT © 2018 HIJT ARCHITECTS

COLOR AND MATERIAL BOARD


NOTE: ALL COLORS DESCRIBED ARE SUBJECT TO CHANGE TO MAINTAIN DESIGN INTENT ILLUSTRATED.

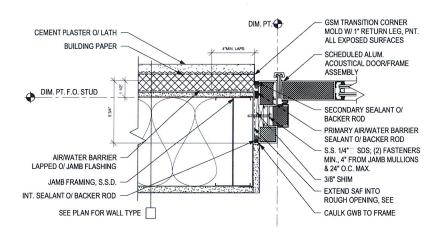

## 1 DOOR - ACOUSTICAL STOREFRONT JAMB

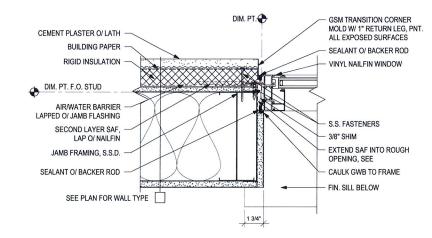

## 

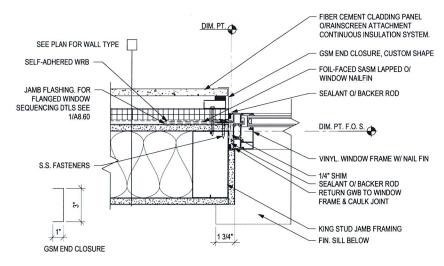

## (3) WINDOW JAMB - FIBER CEMENT PANEL (METAL STUD)

#### BROOKLYN BASIN PARCEL A

OAKLAND, CALIFORNIA

JOB NO. 00275

DRAWN OM

CHECKED PM
JOB CAPTAIN PM

DATE

11/19/18 PLANNING SUBMISSION 02/15/19 DESIGN REVIEW 02/27/19 PLANNING REVIEW 03/07/19 PLANNING RESUBMITTAL

DRAWING TITLE

EXTERIOR WINDOW JAMB DETAILS

SCALE AS NOTED

A8.0