

**Oakland City Planning Commission  
Design Review Committee**

**STAFF REPORT**

**Case File Number: PLN 19070**


**April 24, 2019**

<b>Location:</b>	0 Oakport St.
<b>Assessor's Parcel Number(s):</b>	041-3904-001-05, 041-3903-002-08
<b>Proposal:</b>	Proposed office (160,000 sf) and warehouse (133,000 sf) development on 16.42 acres (715,125 square feet), relocation of EBMUD corporation yard, master sign program, and relocation of temporary group assembly (circus and similar temporary events).
<b>Applicant:</b>	K to College DBA Supply Bank Org.
<b>Contact Person/ Phone Number:</b>	Benito Delgado-Olson (510) 967-8978
<b>Owner:</b>	East Bay Municipal Utility District (EBMUD)
<b>Case File Number:</b>	<b>PLN19070</b>
<b>Planning Permits Required:</b>	Design Review; Conditional Use Permits for project over 100,000 square feet in the D-CO zone, civic extensive impact activity/facility (EBMUD corporation yard), group assembly, and master sign program; Parcel Map Waiver for Lot Line Adjustment; Creek Permit
<b>General Plan:</b>	Business Mix
<b>Zoning:</b>	D-CO-6
<b>Environmental Determination:</b>	To Be Determined
<b>Historic Status:</b>	Vacant lot, not historic
<b>City Council District:</b>	7
<b>Finality of Decision:</b>	N/A
<b>For Further Information:</b>	Contact Case Planner Rebecca Lind, Planner III at (510) 238-3472 or by email at <a href="mailto:rlind@oaklandca.gov">rlind@oaklandca.gov</a> .

**SUMMARY**

The purpose of this report is to provide design review analysis for a new mixed-use office and warehouse development located on two existing parcels in the Opportunity Area of the Coliseum Specific Plan. The proposed project includes: a lot line adjustment between the two parcels; development of a regional non-profit headquarters for Supply Bank.Org (including office and warehouse facilities); and relocation of a portion of an existing East Bay Municipal Utilities District (EBMUD) corporation yard from one parcel to the other (See Figure 1 and Attachment A: Plan Sheet C7.0). The purpose of this meeting is to solicit early review of the three new proposed buildings, the site plan, signage and the landscape concept for Parcel 1 and for conceptual review of the site planning for Parcel 2.

# CITY OF OAKLAND PLANNING COMMISSION

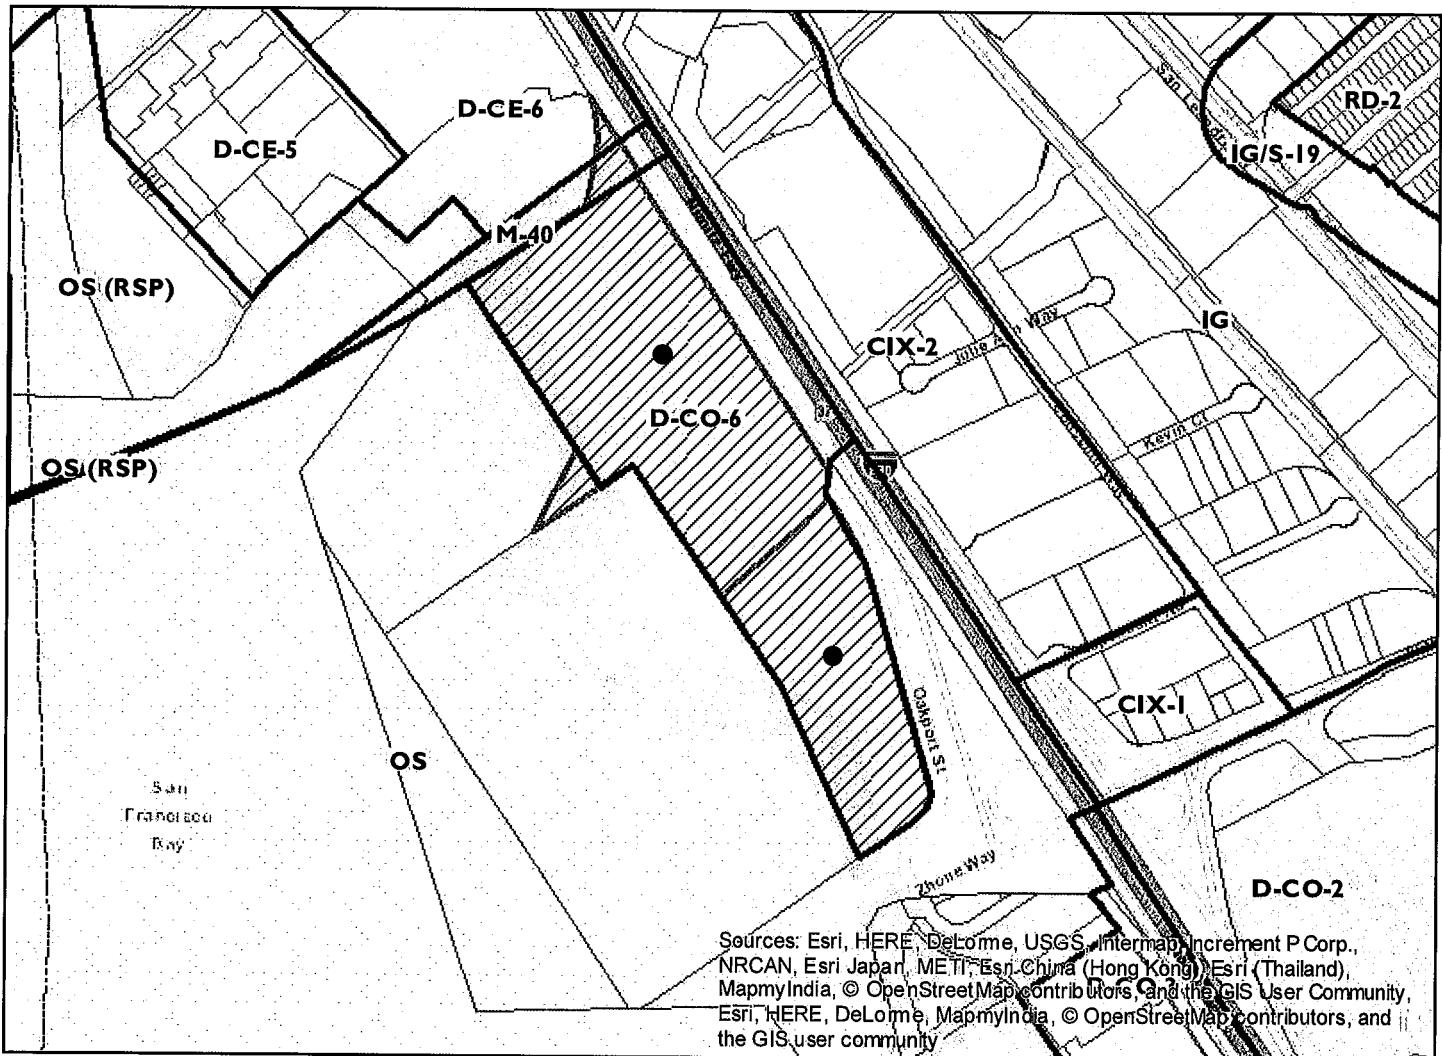

0 250 500 1,000 1,500 2,000 Feet



Case File: ZP180118  
Applicant: K to College DBA Supply Bank Org.  
Address: 0 Oakport St  
Zone: D-CO-6

## **PROJECT SITE AND SURROUNDING AREA**

The site is located in east Oakland, on Oakport Street and includes two parcels, both owned by EBMUD. Parcel 1 is currently undeveloped but is used on a short-term basis for short-term seasonal events such as circuses, Christmas tree sales and overflow parking for the Coliseum. Parcel 2 is the current location of the EBMUD corporation yard, Oakport Wet Weather Treatment Plant, and Oakport Storage Center building which serves the corporation yard. Adjacent uses include open space parcels owned by the East Bay Regional Park District (EBRPD), the San Francisco Bay Trail (Bay Trail) located on EBRPD property, Oakport Soccer Field, Garretson Point Trail, surface parking, and industrial activity on Oakport Street. The site is within 100 feet of the ordinary high water mark and includes areas with estuary characteristics.

## **PROJECT BACKGROUND**

The applicant, Supply Bank.Org (Supply Bank), is a local nonprofit organization providing collection and distribution services of non-food household items (such as diapers) to partner organizations for eventual distribution to low-income families.

Supply Bank is under contract to EBMUD to develop Parcel 1 and a portion of Parcel 2 with a new office, new shared warehouse facility and a relocated corporation yard facility. The proposed office would be Supply Bank's headquarters, and would also provide leased office space to other non-profit organizations.

The warehouse facility would be shared between Supply Bank and EBMUD and used for distribution and storage activities by both organizations. The new corporation yard would include a workshop building, outdoor work/training areas and re-located and upgraded outdoor storage, fleet parking, and employee parking.

The seasonal event area now on Parcel 1 would be re-located to Parcel 2. The Oakport Wet Weather Treatment Plant will remain on Parcel 2. The existing storage structures on Parcel 2 would remain after relocation of the corporation yard and could be leased by EBMUD for use as staging areas for seasonal events.

The site plan for Parcel 1 is shown on **Sheet A1.0** and an aerial map labeled to show changes to Parcel 2 is shown on page **C7.0**

A lot line adjustment between the two parcels is required to provide sufficient land area to accommodate the various activities proposed on each portion of the site. The lot line adjustment would result in a larger Parcel 1 and a smaller Parcel 2. This proposal is shown on the Parcel Map Waiver Map in Figure 2.

Development will require a City Creek Permit. Review of the project also falls within the Bay Conservation & Development Commission (BCDC) jurisdiction because it is within 100 feet of a slough that is subject to tidal action.

## **PROJECT DESCRIPTION**

In summary, the proposed project includes six components:

- Lot Line Adjustment.
- A 5-story, 160,000 square-foot (sf) office building to be used at the headquarters of Supply Bank.Org, including potential lease space of other local non-profit organizations, and proposed surface parking spaces.
- A one-story, 123,000 sf warehouse building divided into 2 occupancies:
  - Unit 1: 63,000 sf of warehouse for EBMUD; and
  - Unit 2: 60,000 sf of storage and distribution functions for the Supply Bank.
- A relocated EBMUD corporation yard including truck fleet parking, covered pipe and materials and scraps bins, and a 10,000 sf workshop which will house welding.
- Relocation of the circus and other event activities from Parcel 1 to Parcel 2.
- Signage.

## **GENERAL PLAN ANALYSIS**

The General Plan Land Use designation for this property is Business Mix. The site is located in the Coliseum Specific Plan Sub-Area E.

The Specific Plan envisions waterfront open space and EBMUD operations within sub-Area E. The plan provides 1) *“that the EBMUD Wet Weather Treatment Facility would continue operations 2) that the existing vacant lot at 66<sup>th</sup> Ave would be utilized in a manner that creates and maintains an attractive frontage along Oakport Street”* and *“that the waterfront parcels facing East Creek slough and the San Leandro Bay would be improved to include a combination of open space, wetland and habitat restoration as well as space for potential future expansion of the existing corporation yard”*. (Coliseum Specific Plan p. 73).

The portion of this Sub-area with access off Oakport St. was designated Business Mix which allows a mix of commercial, industrial and institutional uses. The **Desired Character** Section of policy adopted for the Business Mix Land Use category includes warehouse and distribution, and offices. (Oakland General Plan Land Use Diagram p. 152)

The General Plan also identifies several industry and Commerce Objectives for this area, including Policy I/C1.1 Attracting New Business, Policy I/C 1.2 Retaining Existing Business, and Policy I/C4.1 Protecting Existing Activities. There were no sub-area specific design guidelines adopted for this Sub-Area of the Coliseum Specific Plan.

The project complies with the General Plan and Specific Plan, by 1) providing a new location for Supply Bank, 2) allowing expansion of the office business opportunity to other businesses, 3) retaining elements of the EBMUD operation, and 4) providing for expansion and upgrading of the EBMUD storage function and corporation yard.

## ZONING ANALYSIS

The site is zoned DCO-6. The DCO-6 zone “*is intended to apply to commercial, industrial and institutional areas with strong locational advantages that make possible the attraction of higher intensity commercial and light industrial land uses and development types.*”

The following table compares the proposed project with the DCO-6 development standards.

**Zoning Analysis Table (includes only applicable regulations):**

Development Standard	Applicable Regulations		Compliance Analysis
	DCO-6 Zone Standards	Proposed Project	
<b>Land Use Activities</b>			
1.	Non-Profit Administrative Office 17.10.	Office 160,000 sq. ft. Supply Bank	Complies
2.	Warehouse Distribution 17.10.583 Accessory welding/workshop in a separate building	63000 sq. ft. EBMUD 60,000 sq. Supply Bank	Requires CUP
3.	Extensive Impact Civic Public and public utility corporation or truck yards	Pipe Layout 57,000 sf Materials Bin 18,000 sf Scrap Bins 10,800 sf PTA Training 13,300 Truck Fleet Parking Area	Requires CUP
4.	Group Assembly Circus and similar activities	Proposed by EBMUD on Parcel 2	Requires CUP
<b>Land Use Facilities</b>			
1.	1. Sign Facilities Master CUP under consideration	Enclosed Non-Residential Open Non-Residential Sign Facility	Requires CUP
2.	Enclosed Non-Residential	Enclosed Office Warehouse	Complies
3.	Open Non-Residential	Outdoor Corporation yard	Complies
<b>Development Standards</b>			
1. Non-Residential FAR	4.0 Maximum	Major buildings are at 4.1 Pipe Layout and Materials Bin Add 75,000 sf	Requires variance for covered pipe layout area and bins
2. Site landscaping 721, 180 sf site	5% overall 36,059 sf required	110,724 sf submitted	Complies
3. Shade trees	1/10 spaces through the parking lot	Tristaniopsis Laurina Water Gum Number is not called out	Incomplete; to be discussed May 22
4. Surface parking area	Minimum of 10% of to be landscaped with permanent irrigation	Surface of parking area is not called out	Incomplete; to be discussed May 22
5. Street trees	One 15-gallon tree/20 feet of street frontage if curbside planting exists the ratio is 1/25'	Plan indicates 1.25 feet 1442 ft. of street frontage 58 15 gallon trees.	Complies when combined with curbside planting

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6. Buffering Open parking areas > 3 spaces,  Open loading, storage, sales, display, service, and processing area	Landscaping 3½ feet high and 3 feet wide to screen from all abutting streets, alleys, paths, and private streets or other ways, and/or decorative screening fence or wall (3½) feet high, except where a driveway is located for access	Plan indicates 3' perimeter of planting on Oakport and 5' of planting on the Bay (interior) property line in a stormwater planter. Height of plant material is not indicated	Incomplete to be discussed May 22
7. Setbacks Front, Interior and side Interior corner lot Rear	Zero 10 feet Zero	Site is linear along Oakport St with no interior corner lot.	Complies
8. Maximum Height	85 feet	85feet	Complies
9. Fence Height	8 feet adjacent to Open Space Zones	3-4' retaining wall 8' fence around the property perimeter. Site plan and detail sheet Plan set p. A6.2 S show both "chain link" and "wrought iron" fence Applicant to clarify location of each on site plan.	Complies but design review issue
10. Lot Coverage	No standard; separate from FAR		Review as part of CUP; and Creek Permit
<b>Parking</b>			
1. Supply Bank Office	No Minimum Maximum 367 1/300 sf ground floor 99 max 1/500 sf maximum 268 max	274 spaces proposed for Supply Bank office	Review as part of CUP Less than maximum
2. Supply Bank Warehouse	1/1,500 sf building area Supply Bank 42	Shared with office	Complies; Meets minimum
3. EBMUD Warehouse	EBMUD 40	Plan shows 50 spaces adjacent to the warehouse for EBMUD use	Complies
4. EBMUD Yard	Number of spaces determined by the Planning Director	28 automobile parking spaces 18 medium truck 12 large truck	Review as part of CUP
<b>Loading</b>			
Admin office	3 berths 2/. 159,000 sf+ 1	Supply Bank: 8 at warehouse	
Warehouse	4 berths 3/99,000sf+1	EBMUD: 4 at warehouse	Warehouse Complies None designated for Office
EBMUD yard	None		
<b>Other</b>			
Bicycle Parking	Long Term Office 16 spaces Warehouse 4 spaces	Short Term Office 8 spaces	Not yet identified. Bike parking will likely be at the Bay side of the office building. This issue is part of the discussion with BCDC about public access to the Bay Trail
Public Art	Required		Proposed on site. The location and concept are not yet developed
Open Space	N/A		TBD
<b>Special Regulations for Large-Scale Developments</b>			
	No development which involves more than 100,000 square feet of new floor area shall be permitted except upon the granting of a conditional use permit. As such, the project is subject to a major CUP.		

## DESIGN AND RELATED ISSUES

The overall building complex design integrates the three buildings by using consistent colors and providing some overlap in materials despite the three very different building functions. The total site development provides an integrated approach that meets the intent of the Coliseum Specific Plan policies for this area. The following numbered sections are analyses of each individual building:

### **1. 10,000 sf Workshop (See Plan Sheet AO.1a Perspective, Plan Sheet A3.1-1 Elevations)**

This building is proposed as a welding center and instruction area for employees. It is a pre-engineered metal structure with one story and height of 34' maximum at the roof and 26' at the roof edge. Roof materials are not indicated.

The dominant color treatment for the building is Sherman Williams Cityscape a medium grey with a darker Peppercorn accent around door and windows, and with light gray Sherman Williams SW 7064 is indicated for the roll up doors building walls providing additional contrast.

#### Elevations

Roll-up metal doors are proposed on both the South and West elevations so that the building opens on to an 80' wide paved area that can easily accommodate welding and fabrication activity. The roll-up doors are presented in 2 sizes: 14' x 16' and 14' x 20'. The larger doors provide access to the training area and the parts warehouse while the smaller doors open the welding area.

The west elevation also has clerestory windows providing additional fenestration, and two storefront entry doors separated by 9 solid metal siding panels. A bank of 5 of the smaller roll-up door are shown on this side of the building so that the welding shop can expand outside as needed. The Oakport Street side of the building (north) will have metal panels and windows and no entry. The glazing is identified as "vision glass" but the tint is not indicated. The east elevation facing the parking area has 4 storefront entries separated by metal panel siding and windows. There is no dominant entry to the building.

This combination of windows, doors and panels provides visual interest and variety to the building and increases its functionality.

### **2. Warehouse Plan (See Sheet A4.1-2 and A4.12-2 Elevations)**

This building is designed to accommodate the programmatic needs of two organizations. EBMUD requires a higher height and volume to accommodate storage of pipes and a larger accessory office/ employee area, while Supply Bank requires less height and a smaller floor area. The building is 53' high on the EBMUD half and 43' high setback on the Supply Bank portion. In addition, the building is stepped back at the South elevation creating a recessed area that provides loading docks for Supply Bank. The change in height creates more variety in the urban form.

Otherwise the building is presented with a typical design for a warehouse. Materials are concrete, metal and glass. There is a major entry for each business with glass above the entry. The EBMUD warehouse will have 5 truck loading docks with roll up doors and 3 larger roll up doors at grade. Supply Bank will have 8 smaller truck docks and one large bay.

Additional visual interest is created with color. The building uses the same color palette proposed for the small workshop with the darker gray at the base. Blue is added as an accent around the windows and as a repeating pattern on the walls. A trellis is projects from the building at the Supply Bank entry that relates to a walkway to the new office building.

Future mural treatment of the east wall of the warehouse building is also proposed. This concept is shown on the Perspective drawings submittal p. 3 (Attachment D.). Proposed murals would be in addition to public art.

### **3. Office Building Plan (See Sheet A4.1-3A4.2-3)**

This building is a contemporary office building with 5 stories and a maximum of 85' height at the highest point. The building design overall meets the City's design criteria in that there is a defined base middle and top and the building uses various building modulations and transparency to create visual interest. The building concept is open and light with large window walls on the upper floors that extend around the corners of the building on three sides. The design is organized around a mid-building core on the front that highlights the entry. The core element is set apart visually by a combination of rectangular painted glass panels that show 3 randomly arranged blue color tones and a frame composed of white porcelain tile over concrete that forms a large rectangular element.

#### Front Elevation (North) Lobby Element

The front elevation base building and lobby elements need further clarification. The front lobby element extends beyond the building wall on the first floor. On the second floor, there is a patio above this first floor projection. This portion of the building is shown in the perspective drawings on page AO.1 and AO.1b. and on the building first and second floor plan on pages A2.1-3 and A2.1-3. It is not clear why this element is needed and what it adds to the overall design. The front entry area is already defined by a) first two floors of the building that are recessed on either side of the core and b) the columns which terminate at the ground on one side of the entry, and end in a horizontal band above the entry. A tile wall is shown in perspective and elevation at approximate size of the entry storefront window system. These elements would adequately define the entry of the building. The addition of the projecting lobby element detracts from the appearance of the front façade and seems inappropriate for an office building.

#### Building Middle

The middle of the building is defined by a horizontal band of tile separating the top window elements. Above the base the building wall is transparent.

### Top

The top of the building is defined by a roof edge composed of white ceramic tile. The north (front) and east elevations have a narrow band of light blue glass panels. On the west elevation, the top element uses recessed window and a roof supported by dark gray pillars (peppercorn). This combination creates the feeling that the roof is projecting and adds visual interest. The underside of this roof is finished with the white paint matching the tile. Half of the building on this elevation is recessed.

### Building Back (South Elevation)

The back of the building (south elevation) is also organized around a mid building core but on this side the core is recessed and defined by the same rectangular painted glass panels that with blue color tones used on the front.

The south and west elevation use horizontal bands of the white tile between windows at each floor line and at the top of the building. These elevations also have an open parapet finished with what appears to be the same white tile material further defining the top. On these sides of the building it is open and presumably screens utility equipment.

### Other Accessory Structures (See Plan sheets A2.1-4 A4.1-5 and A4.2-5)

The plan includes covered materials and scrap bins and a covered pipe laydown area in the EBMUD corporation yard. These accessory buildings are pre-engineered structures with concrete wall and simple rooflines. The pipe laydown shed is 36' high at the highest point of the roof with a 28' wall height. The materials bins shed has a shed roof that is 32' at the highest point. Both sheds will be painted in gray tones using the color palate proposed for the other buildings. The plan also shows a walkway connecting the back of the office building to the warehouse. The walkway is design with a simple roof and metal pillars.

### Site planning

The office building is pushed back on the site with a large surface parking lot in the front. This layout is atypical of what we see in other parts of Oakland, but is permitted in this location because the DCO-6 zone does not include a maximum setback standard or any special design criteria intended to create activated street front. The warehouse and workshop buildings and work The Specific Plan Goal for this property is to use the site *in a manner that creates and maintains an attractive frontage along Oakport Street*. The proposed complex of buildings proposed for this site and the landscape plan will accomplish that goal.

### **Issues**

1. Office Building Lobby: Staff requests that DRC provide direction on this design element. Staff recommends modification to both the size and shape of this entry feature.

2. Several elements of the proposal are still under development. Staff recommends that these issues be held to the May DRC meeting to give staff and the applicant time to work with other departments and agencies and/or refine current proposals.
1. Bay Trail. The Bay Trail is adjacent to the property and within the jurisdiction of Bay Conservation & Development Commission (BCDC). The applicant has initiated review with BCDC and at this point it is unclear whether additional improvements enhancing public access to the trail will be included in the proposal.
2. Drainage/Landscaping The proposal includes a bio-swale design that is integrated into the landscape plan. The plan shows two drainage swales draining across the property line onto city property. The parcel receiving these waters is not part of the city drainage system and while labeled an existing infiltration pond on the plans, it is not a designed city facility. The issue of whether the drainage can be channeled on to city property will need to be reviewed by other city departments, and the outcome could potentially alter the landscape plan.
3. Signage The application includes a request for approval of three signs: one for each organization on the warehouse and one for Supply Bank on the office building. Staff previously discussed the potential of developing a Master Sign Program with the applicant to accommodate the needs of the future office building tenants, however the sign submittal is not yet at the appropriate level for consideration. Staff requests initial feedback on the primary business identification signs but recommends that this portion of the application be continued.
4. Frontage improvement on Parcel 2. A site plan and frontage improvements are not proposed as part of this project; however, since the proposal includes the relocation of the group assembly activities (circus, temporary Christmas tree sales and other events) staff initiated discussion of this issue with the applicant and property owner. The Coliseum Specific Plan Policies envision *creating and maintains an attractive frontage along Oakport Street.*

## **CONCLUSION**

Staff requests the DRC to conduct design review of the proposal. Specifically, staff requests the DRC to:

1. Review and comment on the proposed building design and site planning of the office, warehouse and workshop buildings.
2. Continue to the May 2019 meeting to review and discuss:
  - Bay Trail
  - Drainage/Landscaping
  - Master Sign Program
  - Potential site improvements needed to accommodate the public assembly activity to be relocated on for Parcel 2 (still under discussion).

Prepared by:

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Rebecca Lind  
Planner III

Approved for forwarding to the  
Design Review Committee:

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Catherine Payne  
Acting Development Planning Manager

Attachments:


- A. Figure One Parcels 1 and 2
- B. Parcel Map Waiver
- C. Proposed Project Plans
- D. Perspectives
- E. Signage

Prepared by:



Rebecca Lind  
Planner III


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Catherine Payne  
Acting Development Planning Manager

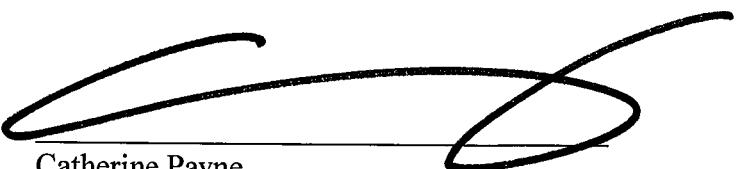Attachments:

- A. Figure One Parcels 1 and 2
- B. Parcel Map Waiver
- C. Proposed Project Plans
- D. Perspectives
- E. Signage

**Attachment A – Figure 1, Parcels 1 and 2 \*\*NOT TO SCALE – FOR REFERENCE PURPOSES ONLY\*\***

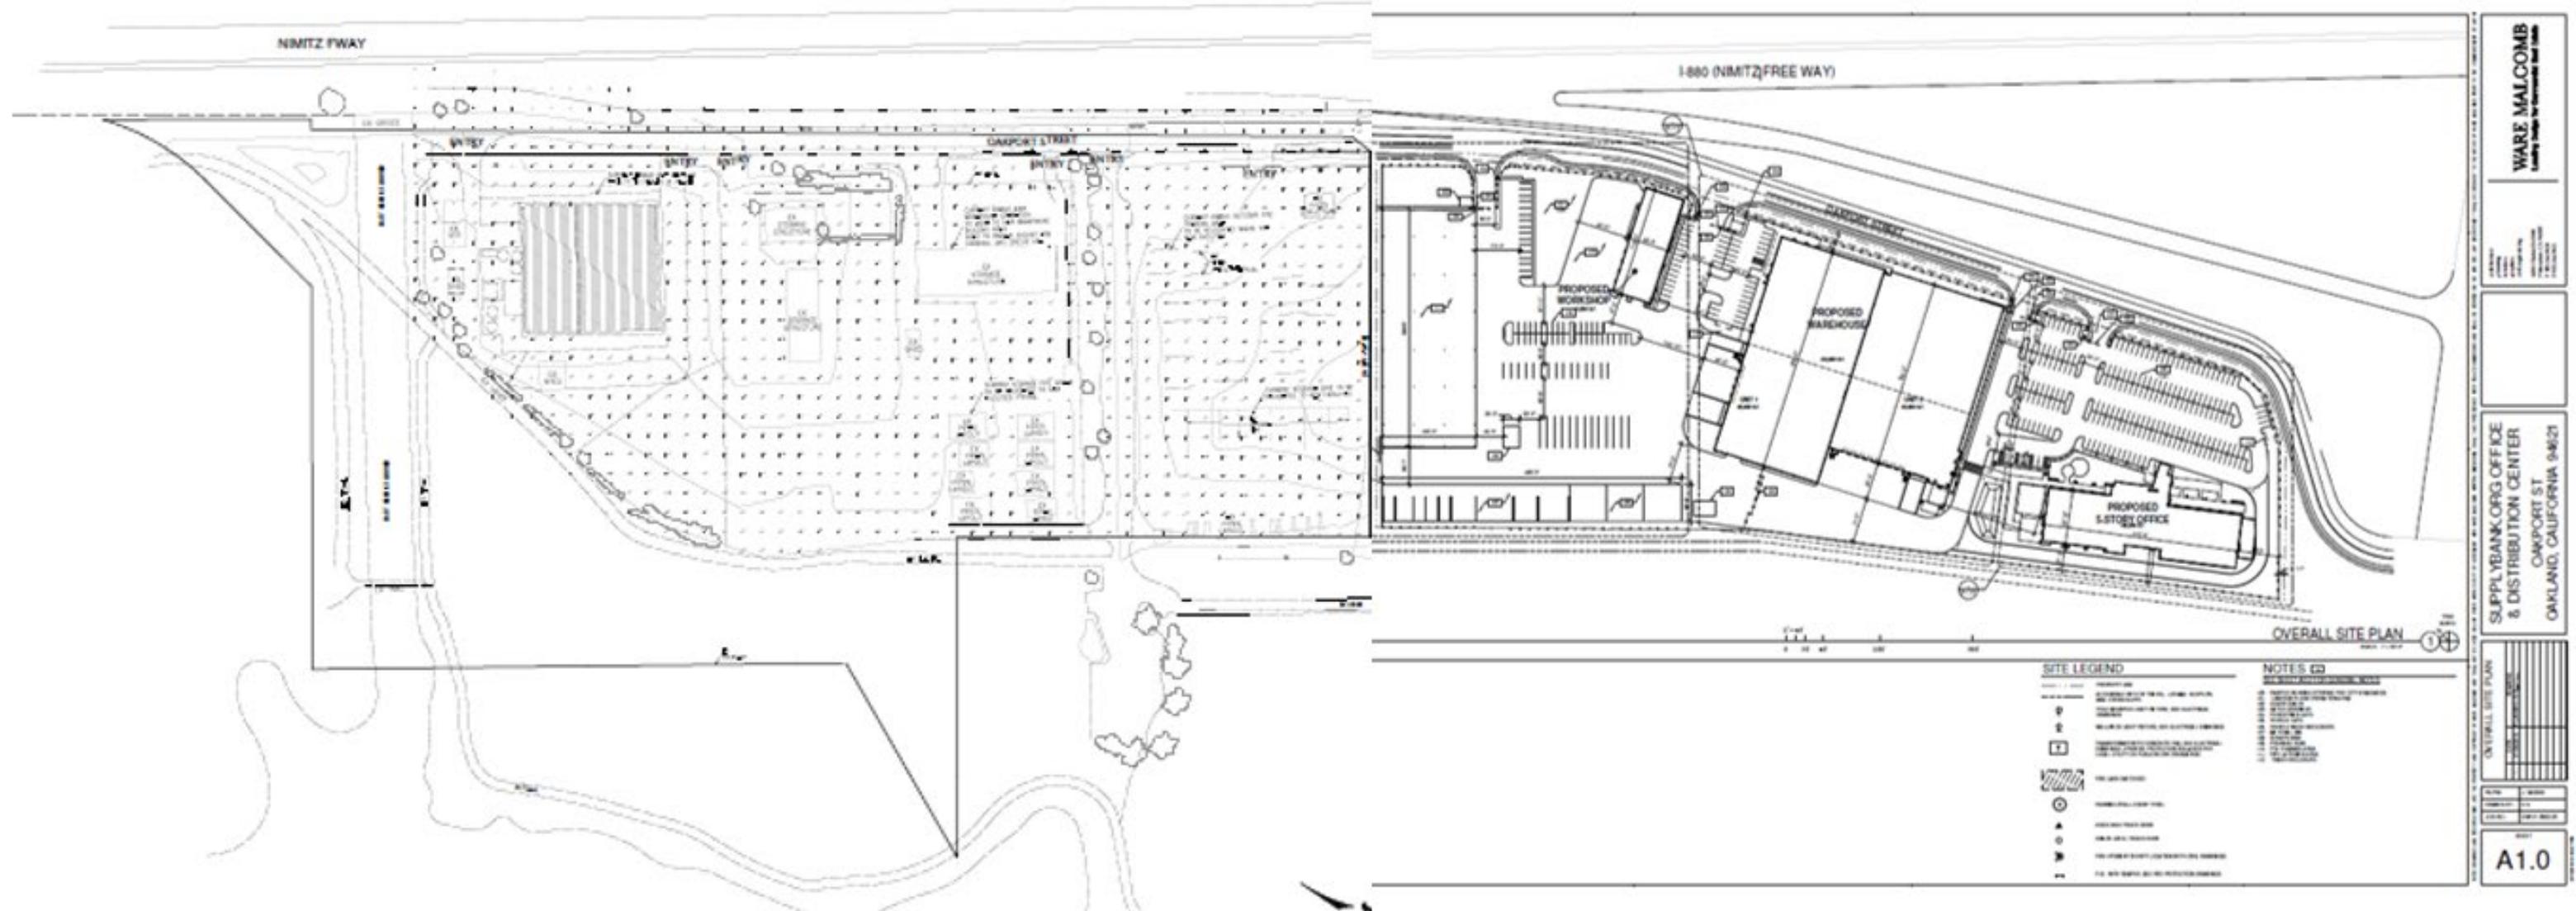

**WARE MALCOMB**  
LEADING DESIGN FOR COMMERCIAL REAL ESTATE

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FOR AND ON BEHALF  
OF WARE MALCOMB

**SUPPLY BANK .ORG OFFICES  
& DISTRIBUTION FACILITY**  
OAKPORT STREET  
OAKLAND, CALIFORNIA

LOT LINE ADJUSTMENT EXHIBIT
REMARKS
NO.
DATE



JOB NO.: SNR17-0069  
PA / PM: GP  
DRAWN BY: SY  
DATE: JAN 15, 2019

SCALE: 1" = 120'  
ORIGINAL GRAPHIC SCALE

Sheet 2 of 11

**EX-1**

THESE DRAWINGS AND SPECIFICATIONS ARE THE PROPERTY AND COPYRIGHT OF WARE MALCOMB AND SHALL NOT BE USED ON ANY OTHER WORK EXCEPT BY AGREEMENT WITH WARE MALCOMB. WRITTEN DIMENSIONS SHALL TAKE PRECEDENCE OVER SCALED DIMENSIONS AND SHALL BE VERIFIED ON THE JOB SITE. ANY DISCREPANCY SHALL BE BROUGHT TO THE NOTICE OF WARE MALCOMB PRIOR TO THE COMMENCEMENT OF ANY WORK.

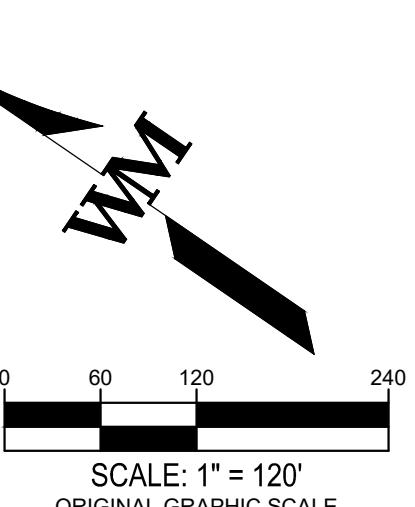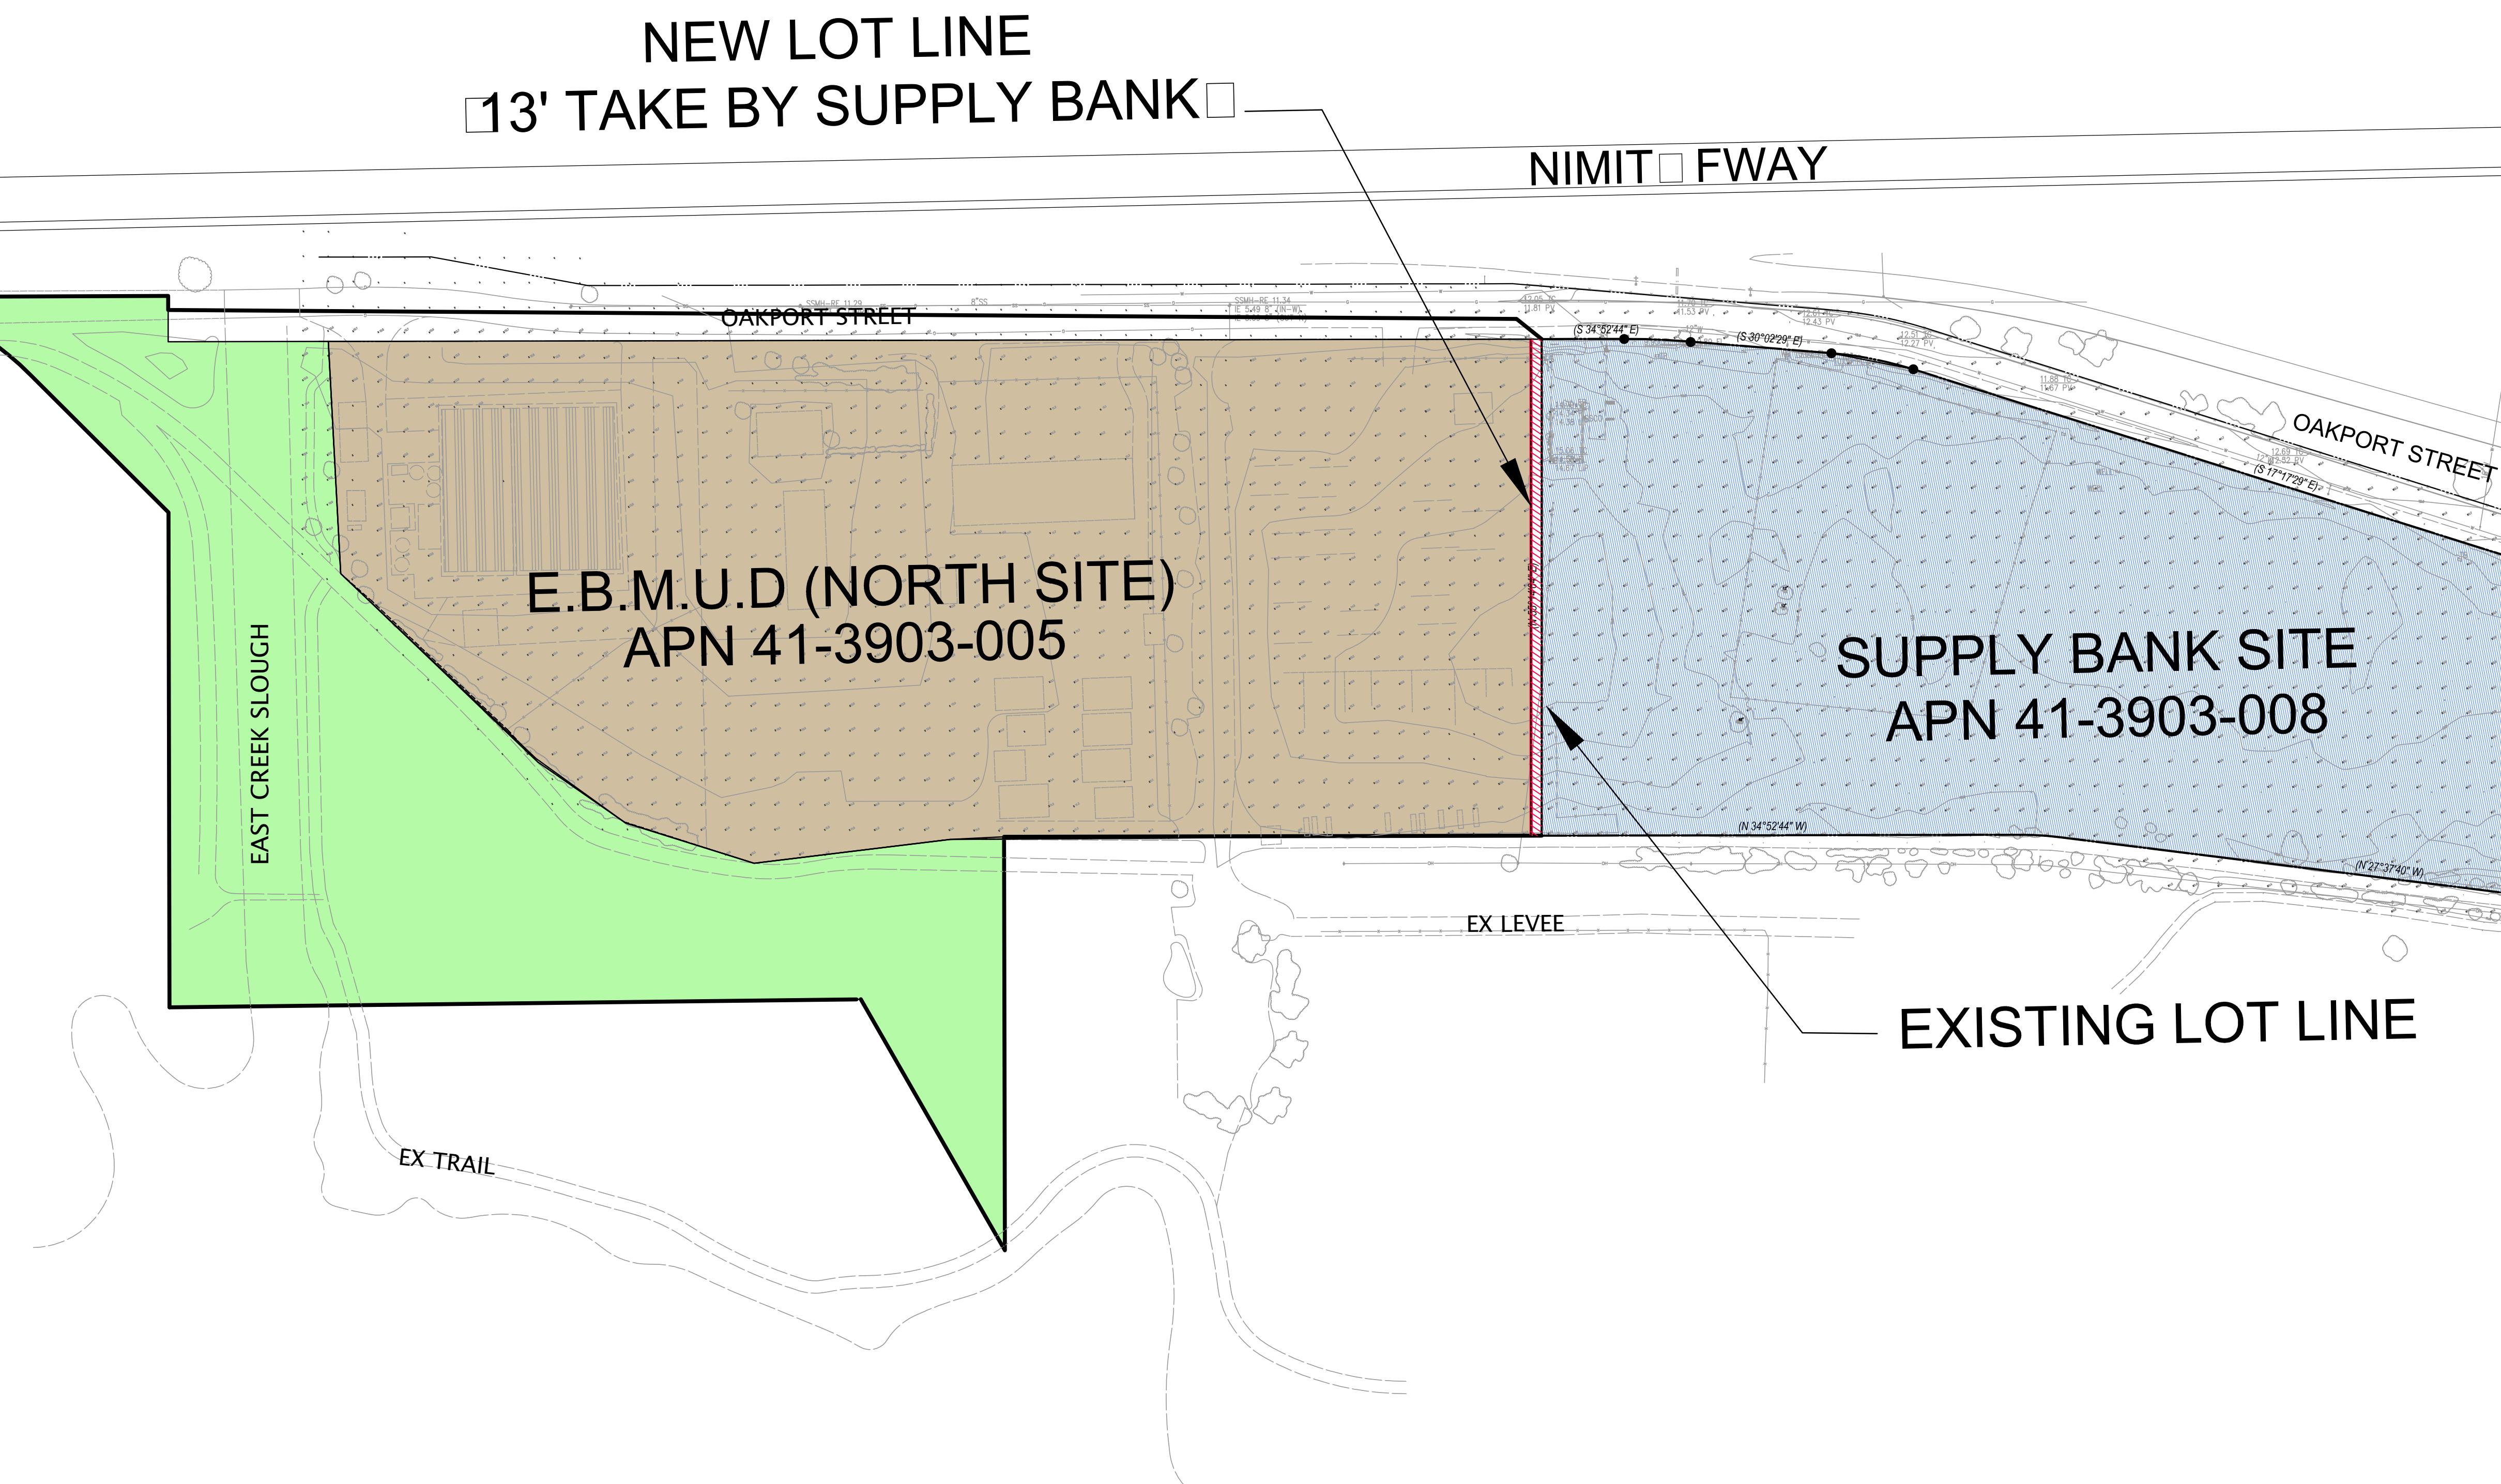


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SCALE: 1" = 120'

ORIGINAL GRAPHIC SCALE


**811**

Know what's below.  
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SCALE: 1" = 60'  
ORIGINAL GRAPHIC SCALE

EAST BAY MUNICIPAL UTILITY DISTRICT  
APN: 41-3904-001-5

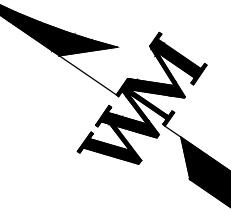

MATCH LINE SEE SHEET 2 OF 2
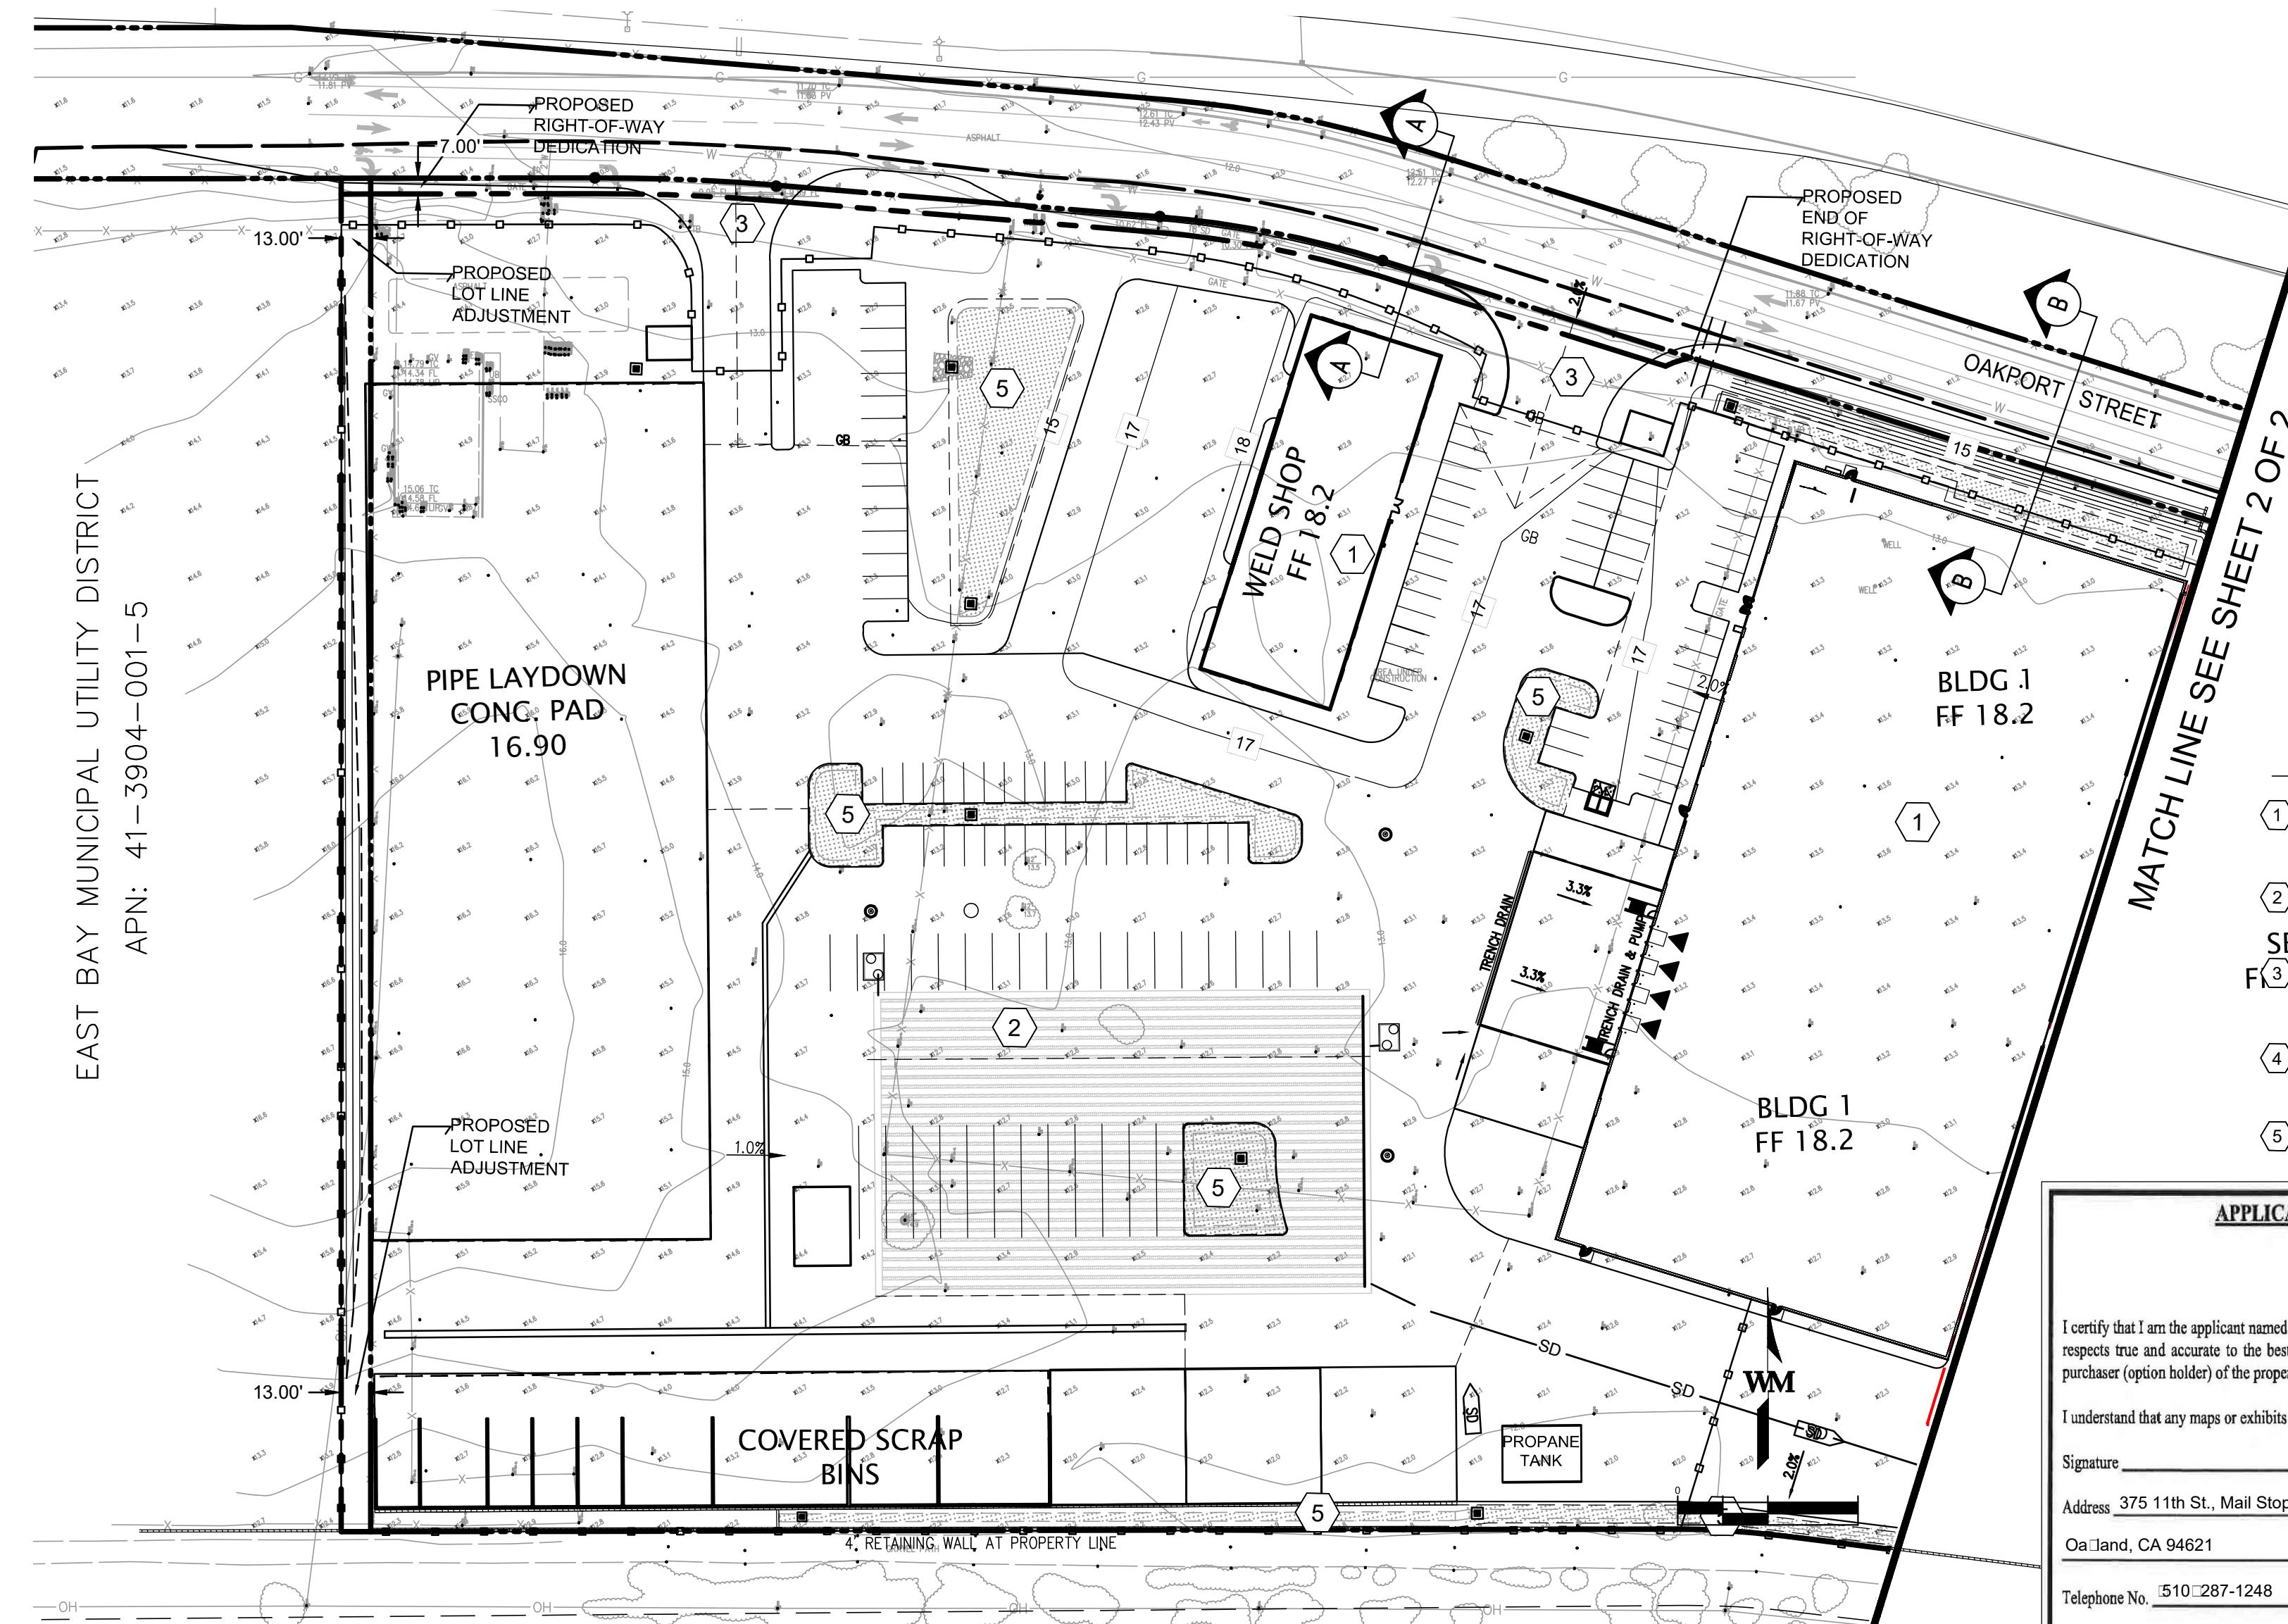
#### MAP NOTES:

- ① PROPOSED BUILDING, SEE ARCHITIURAL PLANS
- ② PROPOSED UNDERGROUND SD STORAGE PIPE SYSTEM
- ③ 8 TRUCK TRAFFIC DRIVEWAY ACCESS
- ④ AUTOMOBILE DRIVEWAY ACCESS
- ⑤ BIO-RETENTION AREA

#### APPLICATION TO WAIVE PARCEL MAP

041-3903-2-8 /  
Parcel No. 041-3904-1-5

I certify that I am the applicant named herein and that the information given on any submission herewith is in all respects true and accurate to the best of my knowledge and belief. I further certify that I am the owner or purchaser (option holder) of the property involved in this application.

I understand that any maps or exhibits filed become a permanent part of the file and may not be returned to me.

Signature \_\_\_\_\_ I am the:  Property Owner

Address 375 11th St., Mail Stop 903 Purchaser (include copy of contract)

Oakland, CA 94621

Telephone No. 510-287-1248

Owner's Name EBMUD, Matt Elawad (if other than applicant)


Owner's Address Same as above Telephone No. Same as above



713 Nacomis Court 925-344-6461  
Trac CA 95304

DATE

PREPARED BY OR UNDER THE SUPERVISION OF  
SHANE R. BARBER, L.S. 9097  
sbarber@barbersurveying.com

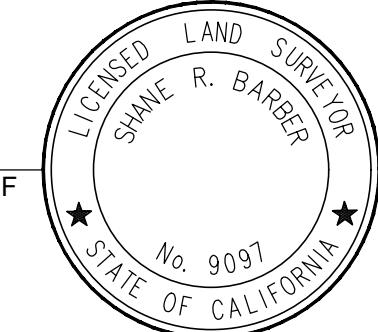

#### STATEMENT OF PURPOSE OF PARCEL MAP WAIVER:

THE PURPOSE OF THIS MAP IS TO PRESENT THE PROPOSED 13.00' LOT LINE ADJUSTMENT NORTH TO TAKE APPROXIMATELY 7,800 SF FROM THE EBMUD PROPERTY, AND TO DEDICATE A 7' WIDE BY APPROXIMATELY 608.5' AREA TO THE CITY FOR OAKPORT STREET, AT THE NORTHWEST CORNER OF THE SITE.

4683 chabot drive  
suite 300  
pleasanton, ca 94588  
p. 925.244.9620  
waremalcomb.com

#### PARCEL MAP WAIVER MAP



JOB NO. SNR17-0069-00  
DATE: APRIL 3, 2019  
SCALE: 1" = 60'  
Sheet 1 of 2

NO.	DATE	REMARKS
DRAWN BY: GP	PA/PM: GP	

**WARE MALCOMB**  
CIVIL ENGINEERING & SURVEYING



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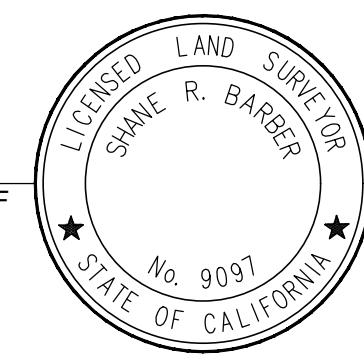


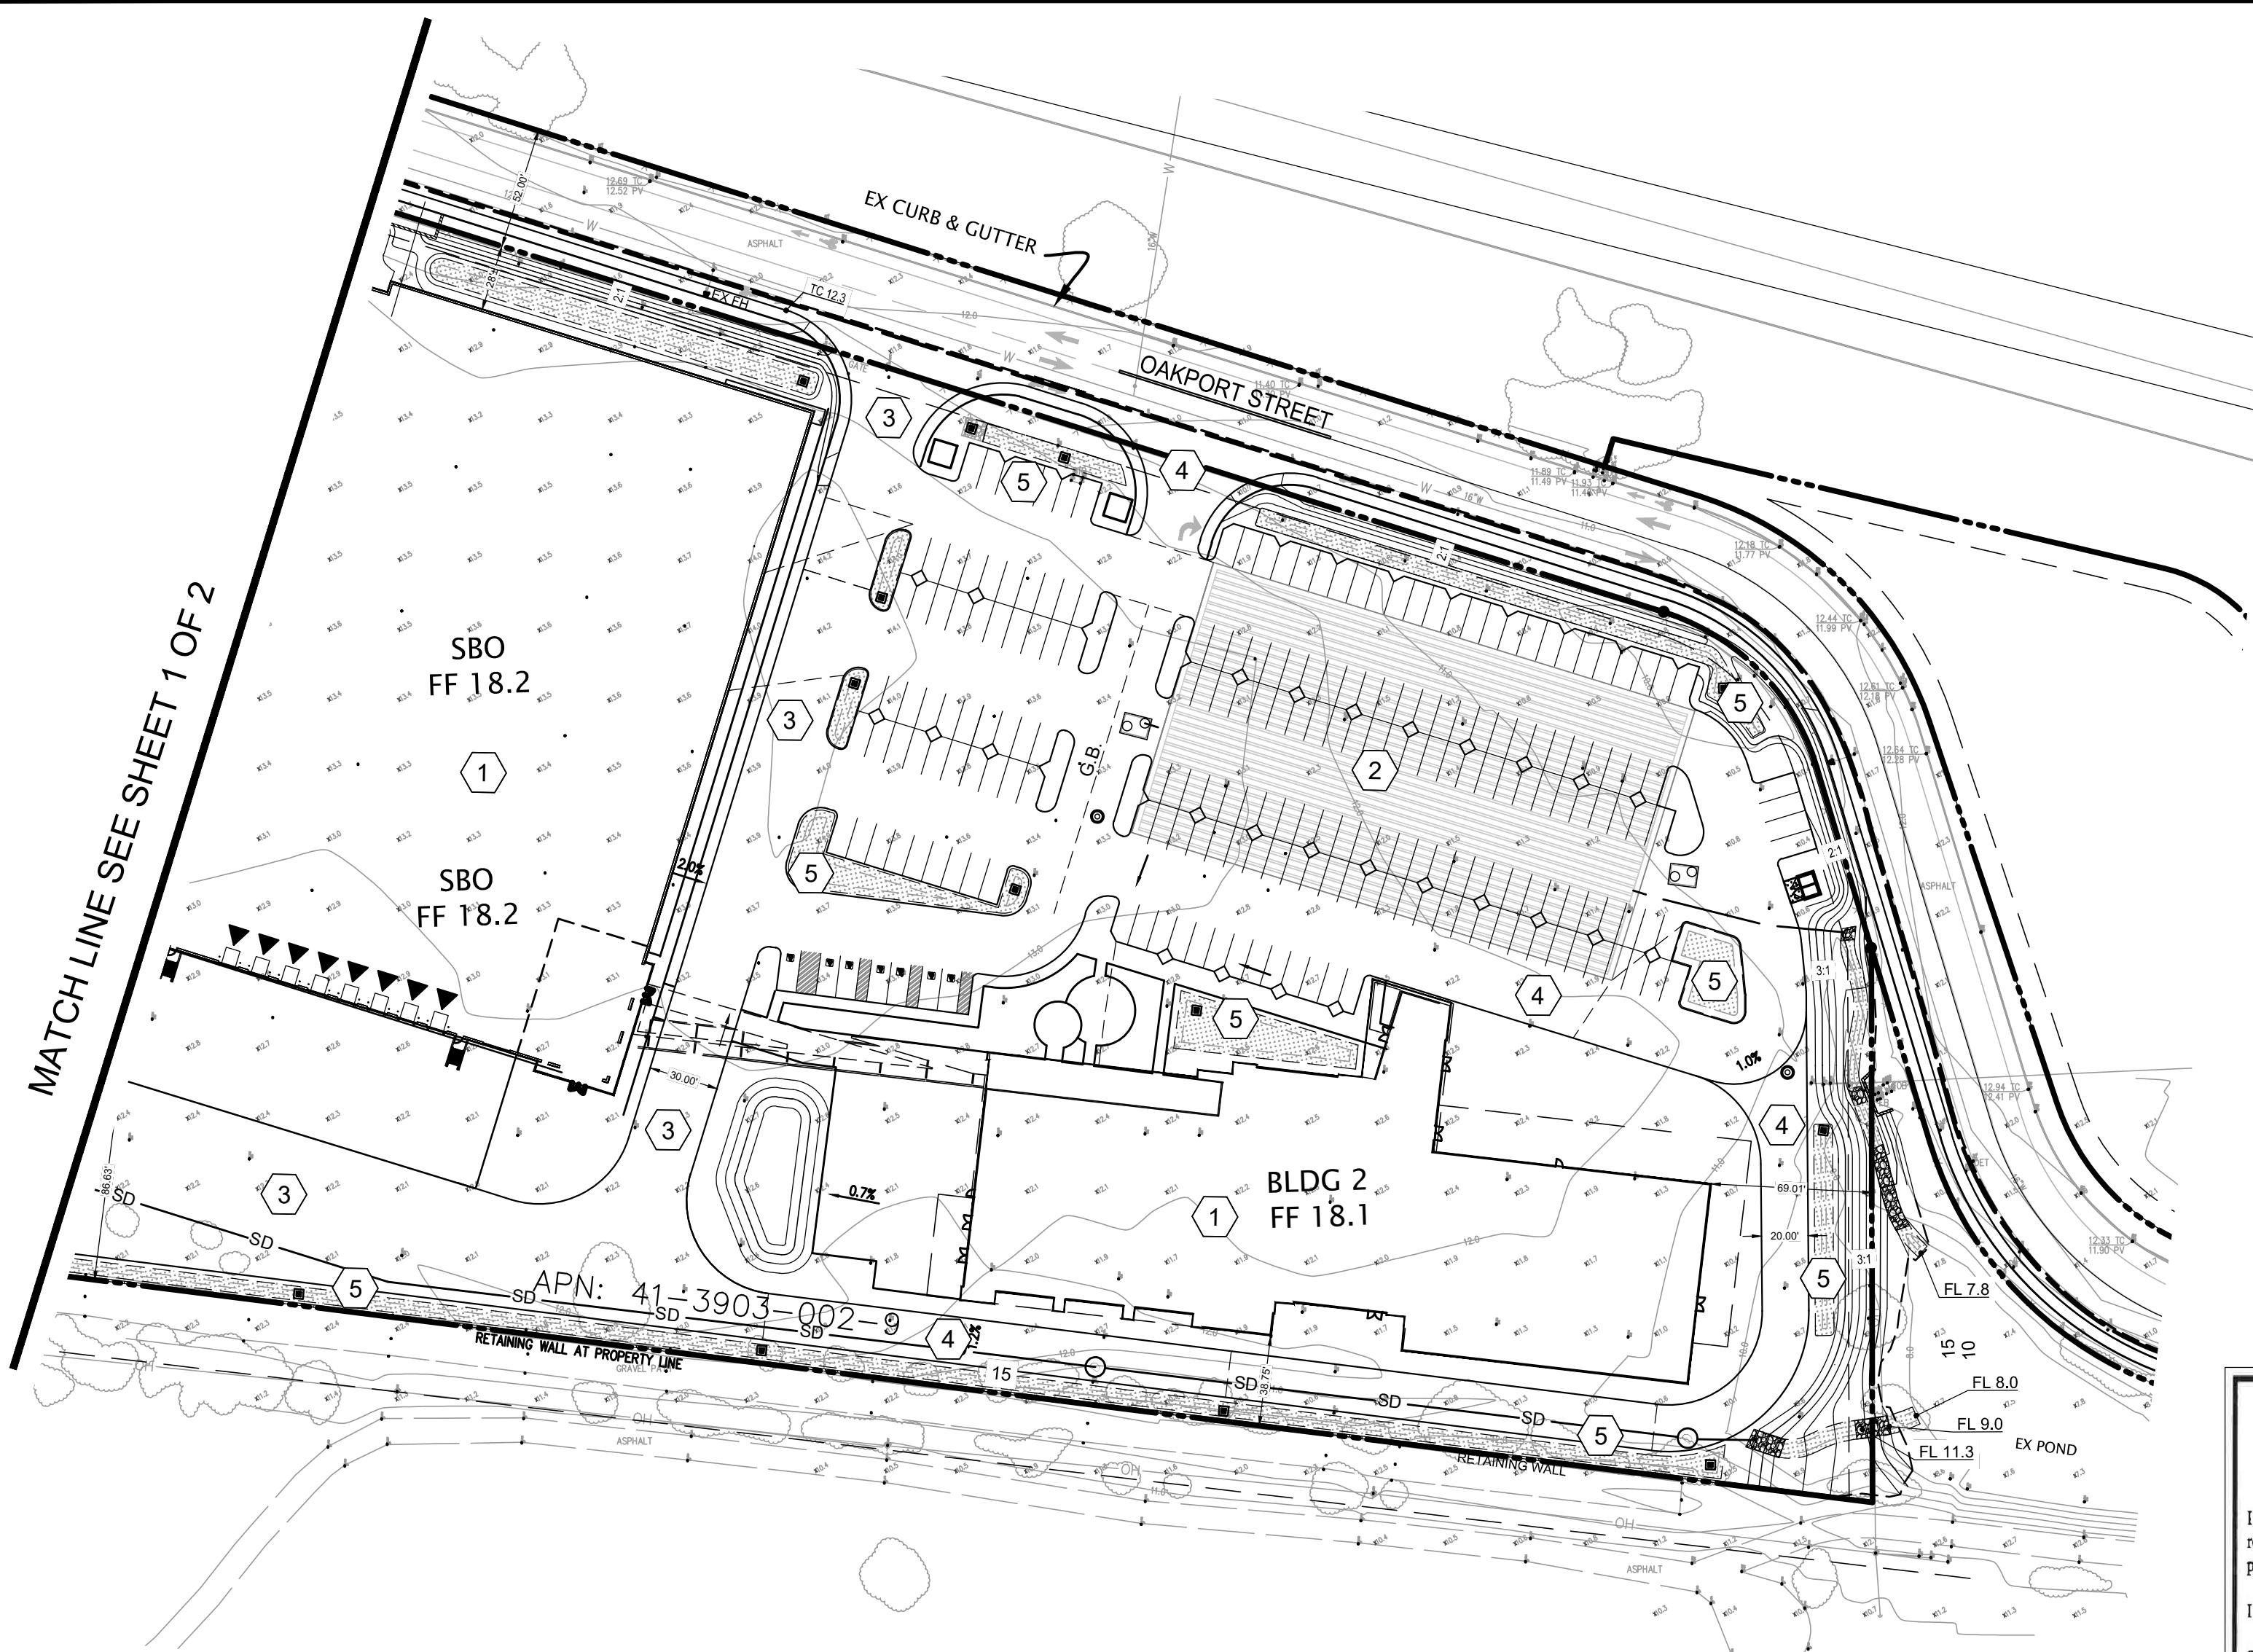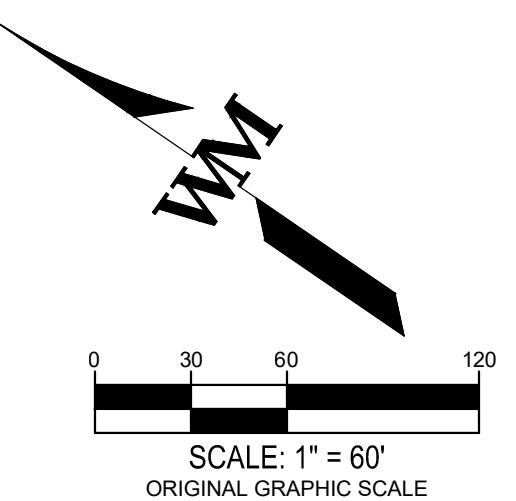713 Nacomis Court  
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**PARCEL MAP WAIVER MAP**


JOB NO.	SNR17-0069-00
DATE:	APRIL 3, 2019
SCALE:	1" = 60'
Sheet	2 of 2

NO.	DATE	REMARKS
DRAWN BY: GP	PA/PM: GP	

**WARE MALCOMB**  
CIVIL ENGINEERING & SURVEYING

# SUPPLYBANK.ORG OFFICE & DISTRIBUTION CENTER

OAKPORT ST  
OAKLAND, CALIFORNIA 94621

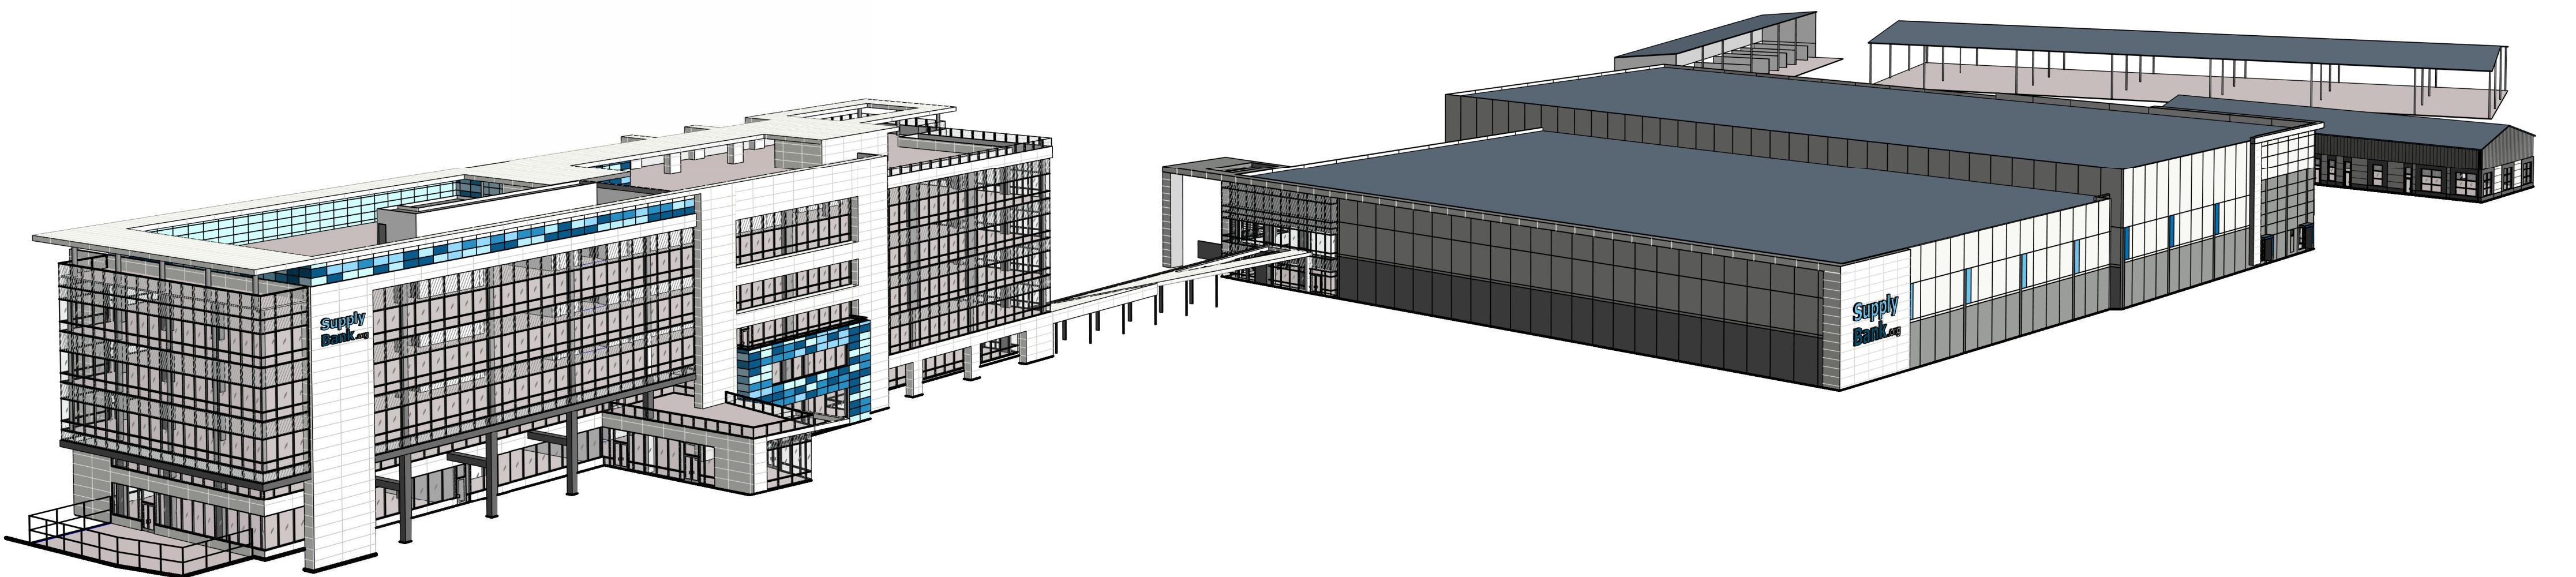

## SHEET INDEX

TOTAL  
SHEETS  
61

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  - A0.1b PROJECT RENDERINGS
  - A1.0 OVERALL SITE PLAN
  - A1.1-1 BUILDING 1 - ENLARGED SITE PLAN
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  - A1.1-3 BUILDING 3 - ENLARGED SITE PLAN
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  - A2.1-4 BUILDING 4 - FLOOR PLAN & EXT. ELEV.
  - A2.1-5 PIPE LAYDOWN & MATERIAL BINS FLOOR PLANS
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  - A5.2 EXTERIOR WINDOW TYPES
  - A5.3 EXTERIOR WINDOW TYPES
  - A6.1 DETAILS
  - A6.2 DETAILS
  - A6.3 DETAILS
  - A6.4 DETAILS
- ARCHITECTURAL SHEET COUNT: 39

### PHOTOMETRIC

- PS1.0 PHOTOMETRIC SURVEY  
PHOTOMETRIC SHEET COUNT: 1


### LANDSCAPE

- L1.1 PRELIMINARY PLAN
  - L1.2 PRELIMINARY PLAN
  - L1.3 PRELIMINARY PLAN
  - L1.4 PRELIMINARY PLAN
  - L1.5 PRELIMINARY PLAN
  - L1.6 PRELIMINARY PLAN
  - L1.7 ROOF TOP PRELIMINARY PLAN
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  - L1.9 TREE SURVEY PLAN
- LANDSCAPE SHEET COUNT: 9

### CIVIL

- C1.0 COVER SHEET
  - C2.0 EXISTING CONDITION
  - C3.0 PRELIMINARY GRADING AND DRAINAGE PLAN
  - C3.1 PRELIMINARY GRADING AND DRAINAGE PLAN
  - C3.2 PRELIMINARY GRADING AND DRAINAGE PLAN
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  - C6.1 STORMWATER CONTROL DETAILS
  - C7.0 EBMUD PRELIMINARY POST CONSTRUCTION NORTH SITE EXHIBIT
- CIVIL SHEET COUNT: 12

### VICINITY MAP

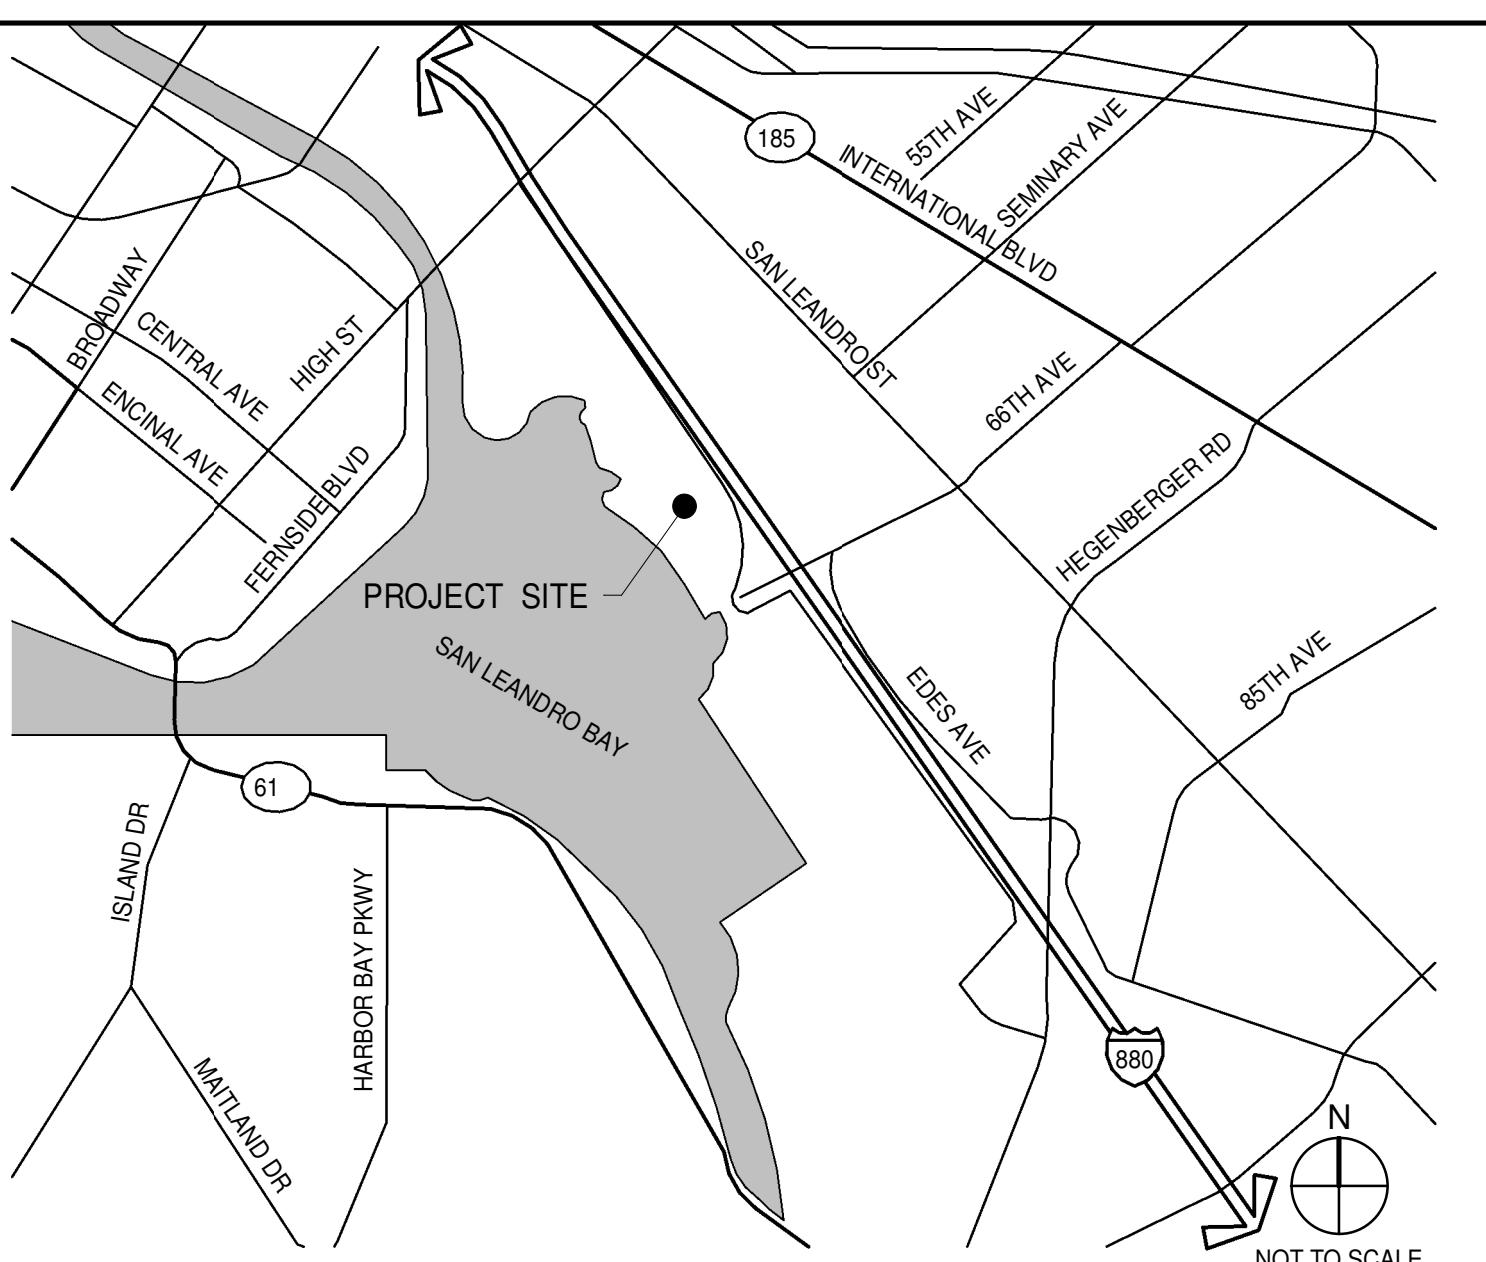

### OWNER

#### SUPPLYBANK.ORG

7730 PARDEE LANE  
OAKLAND, CALIFORNIA 94621

BENITO DELGADO-OLSON  
PH: (510) 569-5862  
CELL: (510) 967-8978

#### ARCHITECT

#### WARE MALCOMB

4683 CHABOT DR #300  
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JIM BABINE  
P 925.244.9620  
F 925.244.9621

#### OWNER'S CONSULTANTS

#### GEOTECHNICAL ENGINEER

TERRACON CONSULTANTS, INC  
5075 COMMERCIAL CIRCLE, SUITE E  
CONCORD CALIFORNIA 94520

NOAH T. SMITH  
PH: (925) 699-7224  
FAX: (925) 609-6324

### ARCHITECT'S CONSULTANTS

#### LANDSCAPE ARCHITECT

THOMAS BAAK & ASSOCIATES, LLP  
1620 N MAIN ST #4  
WALNUT CREEK, CALIFORNIA 94596

RICK STOVER  
PH: (925) 933-2583 EXT. 105  
FAX: (000) 000-0000

#### CIVIL ENGINEER

WARE MALCOMB  
4683 CHABOT DR #300  
PLEASANTON, CALIFORNIA 94588

MICHAEL MURPHY  
PH: (925) 244-9620  
FAX: (925) 244-9621

### DEFERRED SUBMITTALS

DEFERRED SUBMITTAL ITEMS SHALL BE SUBMITTED TO THE ARCHITECT AND ENGINEERS OF RECORD WHO SHALL REVIEW AND PROVIDE FEEDBACK INDICATING DOCUMENTS HAVE BEEN REVIEWED AND FOUND TO BE IN GENERAL CONFORMANCE WITH THE BUILDING DESIGN. SUBMITTAL MATERIALS SHALL INCLUDE PLANS, DETAILS AND CALCULATIONS PREPARED AND SIGNED BY A STATE REGISTERED ENGINEER.

CONTRACTOR SHALL SUBMIT ARCHITECT AND ENGINEER REVIEWED SUBMITTAL MATERIALS TO THE BUILDING OFFICIAL FOR REVIEW AND PERMIT APPROVAL. DEFERRED SUBMITTAL ITEMS SHALL NOT BE INSTALLED PRIOR TO OBTAINING THE BUILDING OFFICIAL'S APPROVAL OF THE SUBMITTAL.

1. AUTOMATIC FIRE SPRINKLER SYSTEM.
2. FIRE ALARM SYSTEM.
3. STEEL JOISTS, TRUSSES AND GIRDERS CONFORMING TO SJI STANDARDS SPECIFICATIONS.
4. STEEL STAIRS, HANDRAILS AND GUARDS.
5. HIGH PILED STORAGE RACKING.
6. EXTERIOR BUILDING SIGNAGE.
7. ANCHORAGE DESIGN FOR ALL ELECTRICAL EQUIPMENT REQUIRED.
8. STOREFRONT AND CURTAIN WALL GLAZING SYSTEMS.
9. MECHANICAL EQUIPMENT, VENTS, DUCTS AND UTILITY BOXES.
10. GUARD SHACKS.
11. VEHICLE WASH ENCLOSURE.
12. BUILDING SIGNAGE.

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### TITLE SHEET

REMARKS

PAPM: J. BABINE  
DRAWN BY: E.S.  
JOB NO.: SNR17-0069-00

### SHEET

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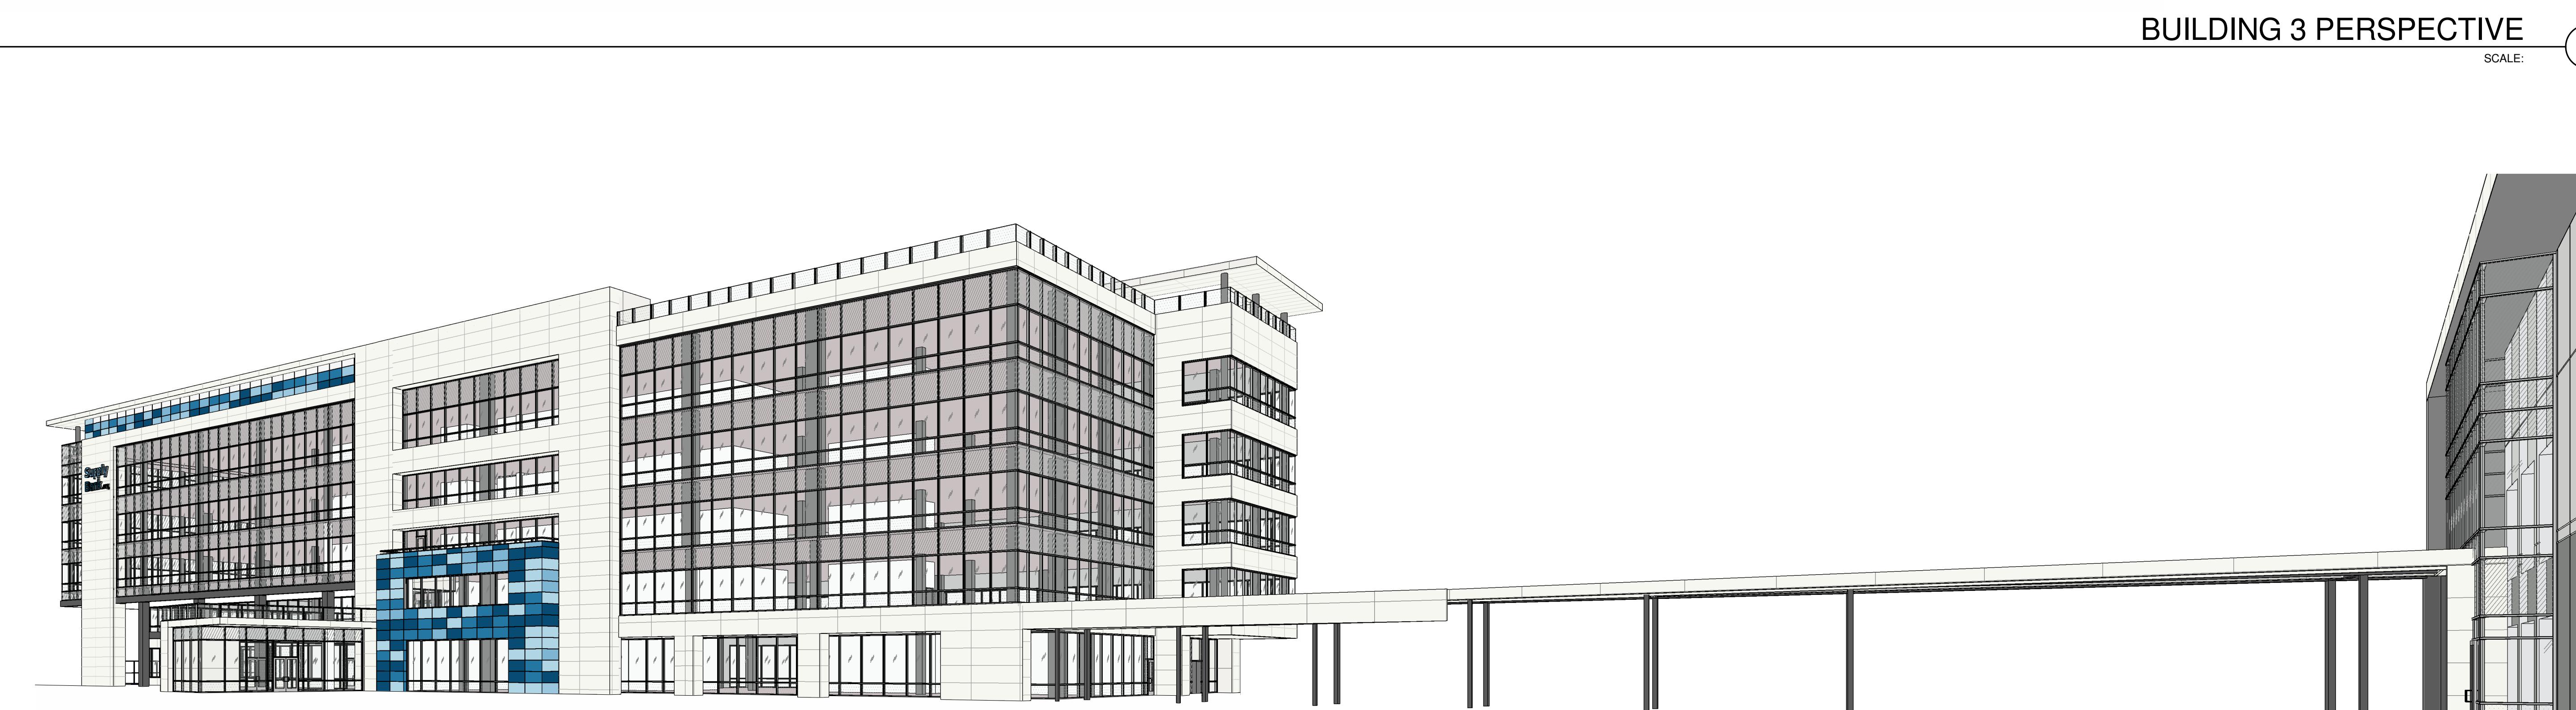
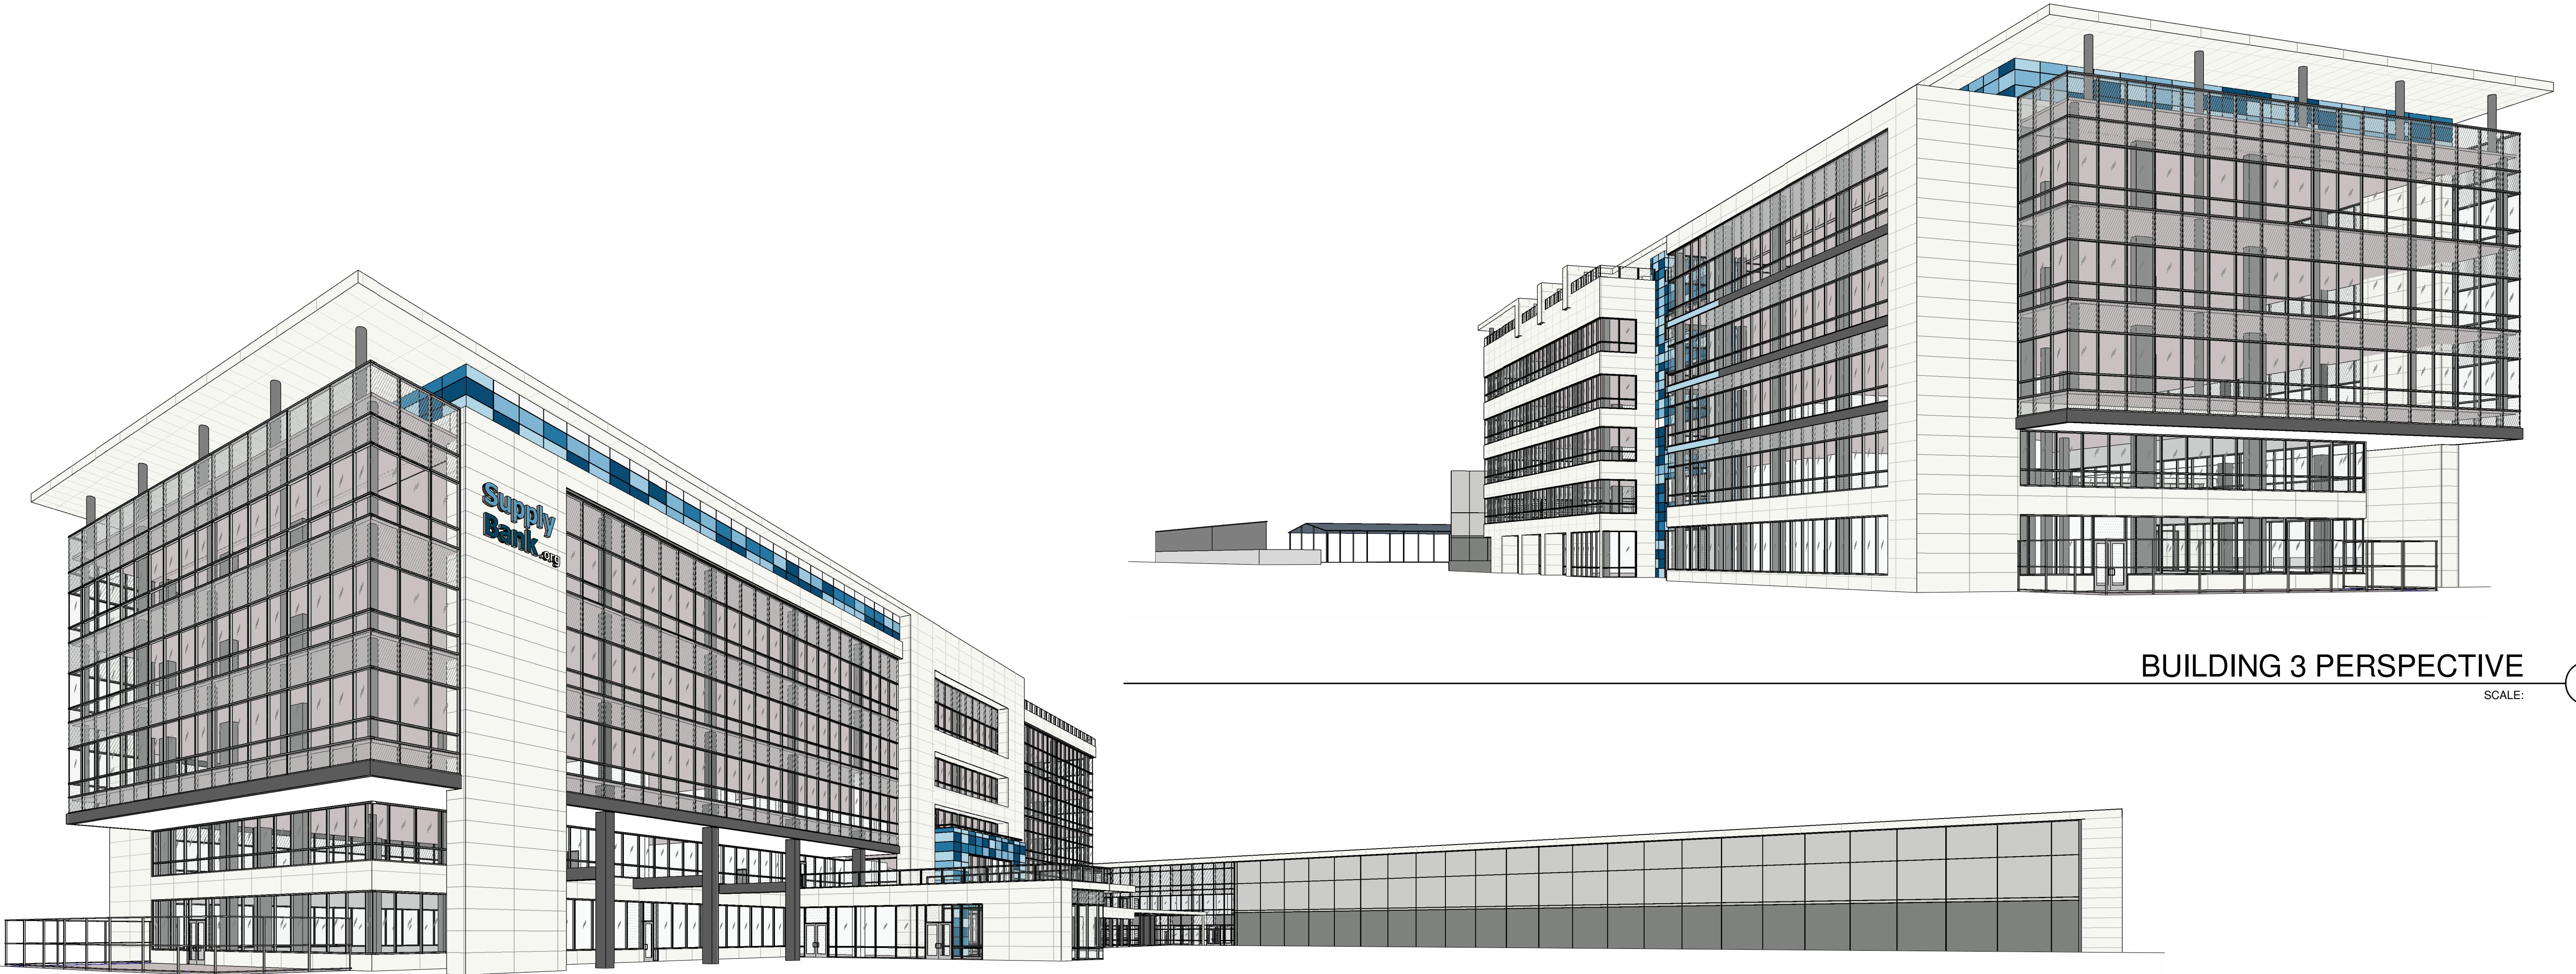
**PROJECT RENDERINGS**

DATE	REMARKS
04/03/2019	


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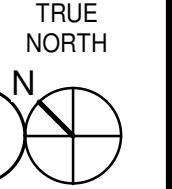
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## I-880 (NIMITZ FREE WAY)



OVERALL SITE PLAN



SCALE: 1" = 60'-0"
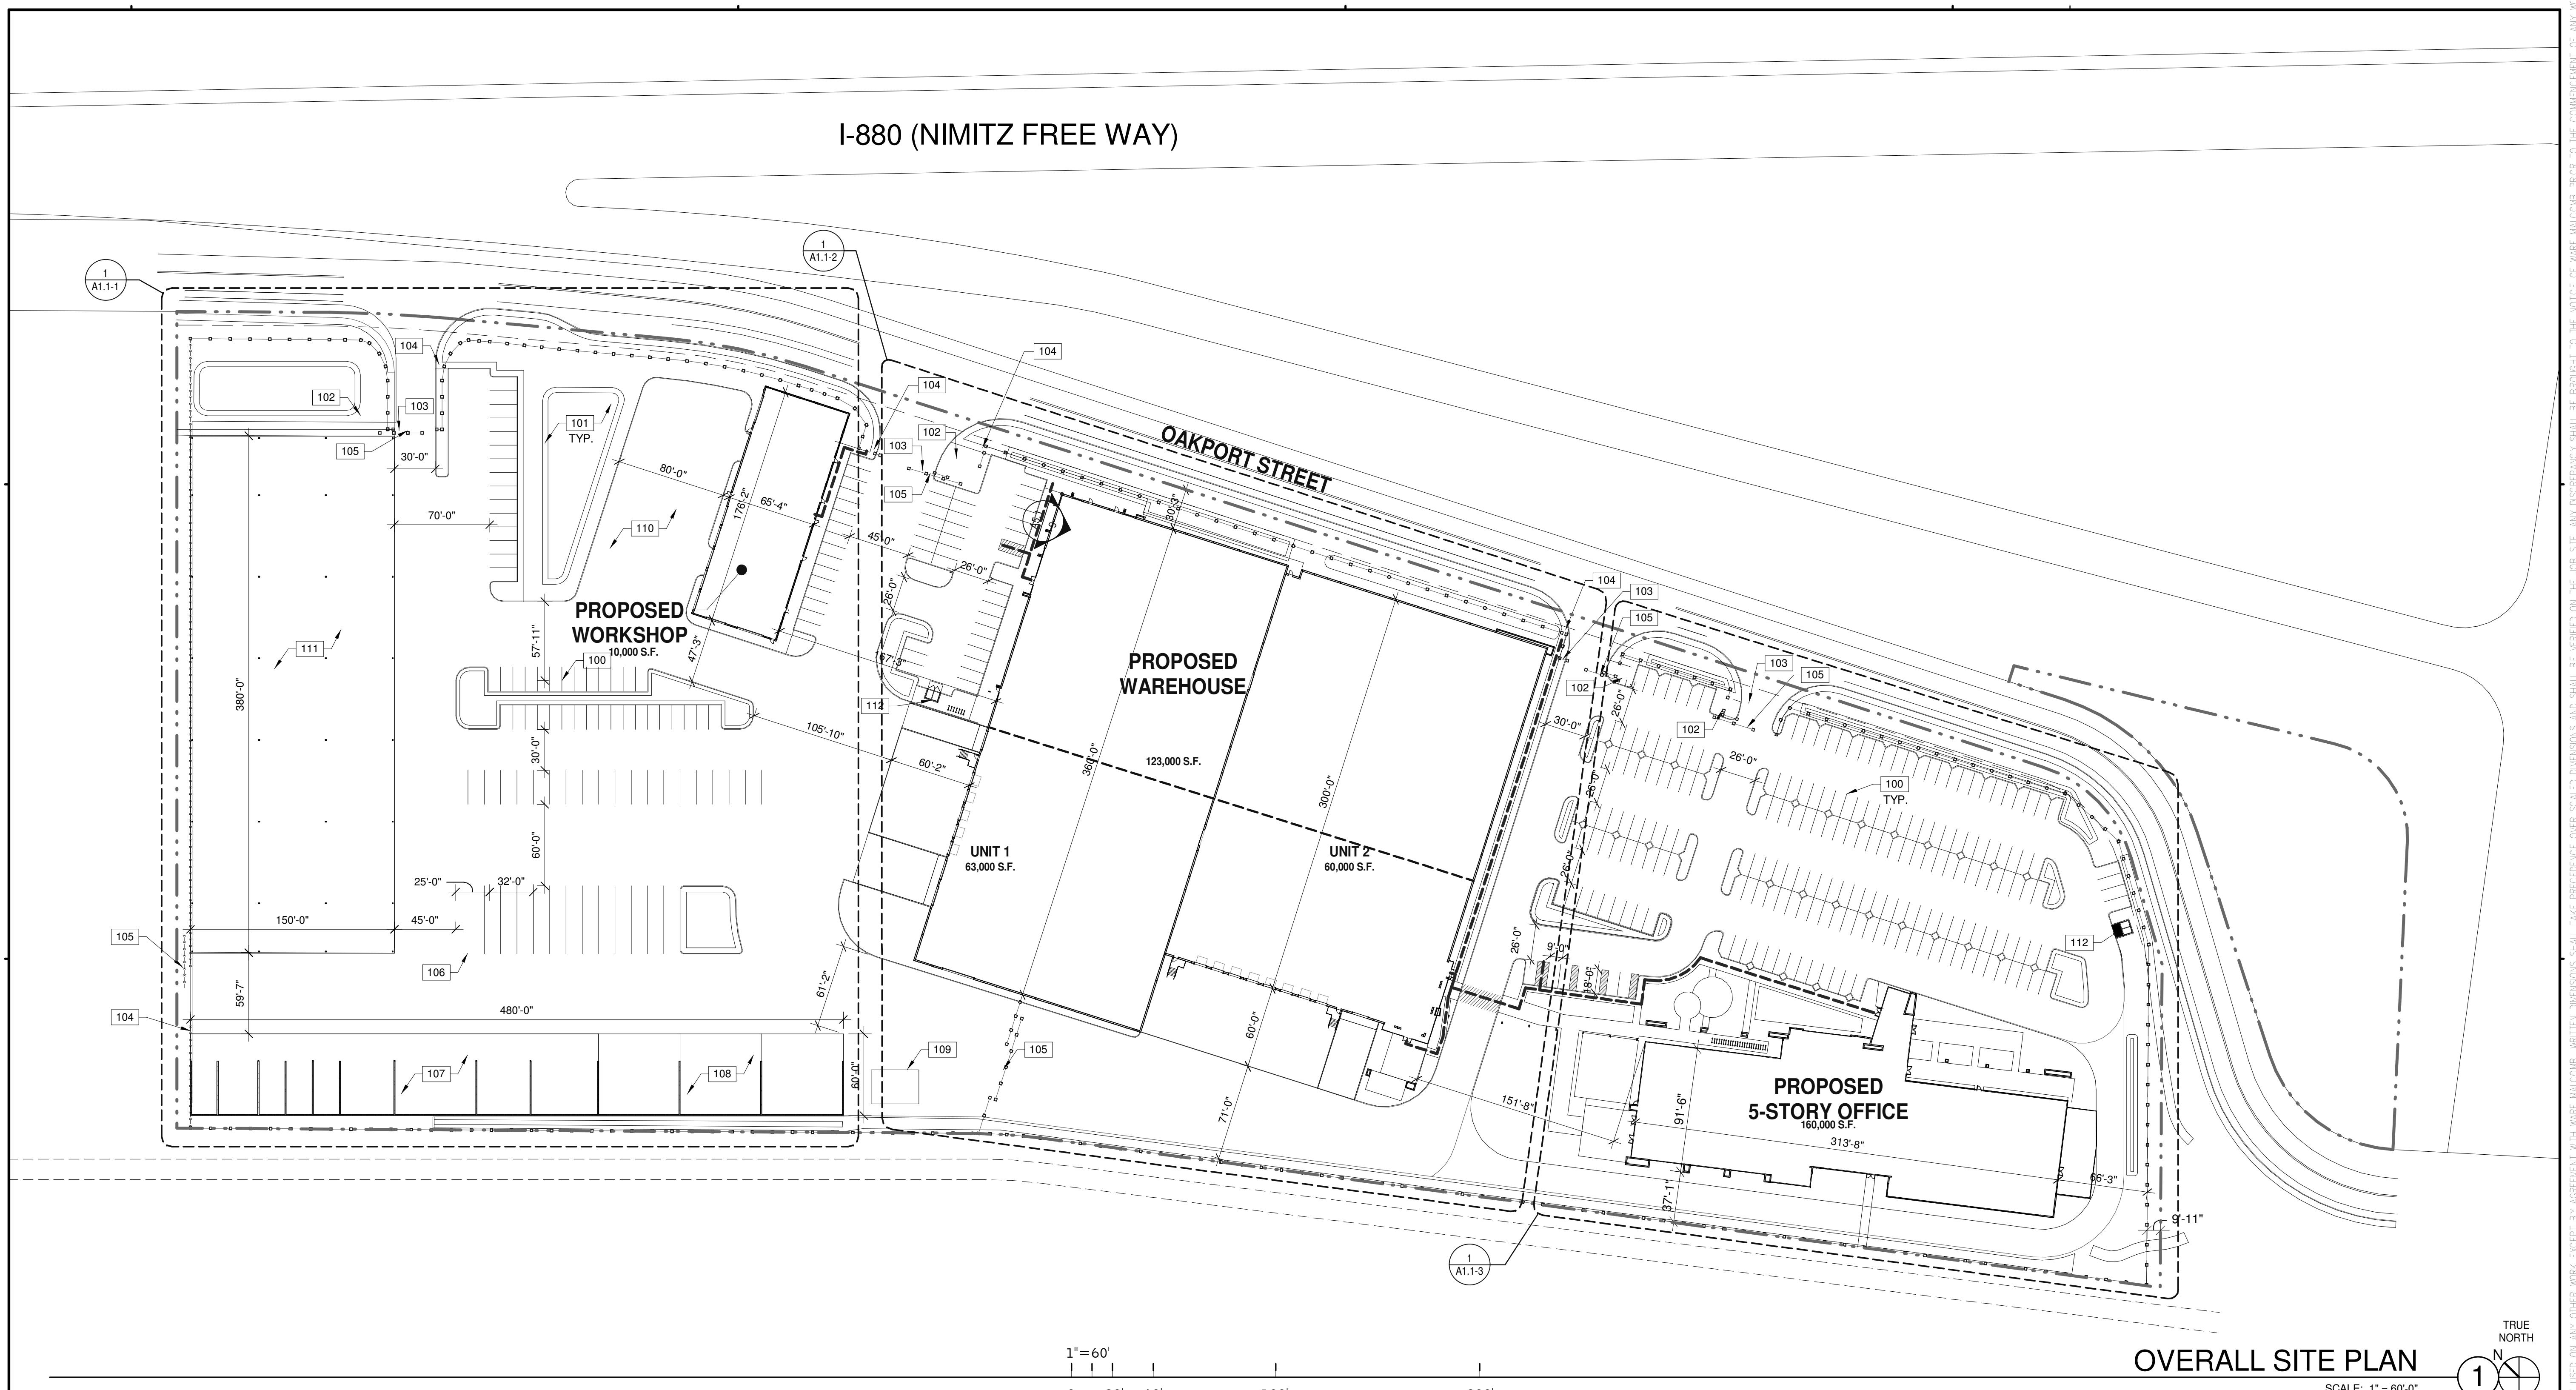
## SITE LEGEND

- PROPERTY LINE.
- - - ACCESSIBLE PATH OF TRAVEL, 1:20 MAX. SLOPE 2% MAX. CROSS SLOPE.
- POLE MOUNTED LIGHT FIXTURE, SEE ELECTRICAL DRAWINGS
- WALLPACK LIGHT FIXTURE, SEE ELECTRICAL DRAWINGS
- TRANSFORMER WITH CONCRETE PAD, SEE ELECTRICAL DRAWINGS. (PROVIDE PROTECTION BOLLARDS PER LOCAL UTILITY OR PUBLIC WORK STANDARDS)
- ▨ FIRE LANE (HATCHED)
- × PARKING STALL COUNT TOTAL
- ▲ DOCK HIGH TRUCK DOOR
- GRADE LEVEL TRUCK DOOR
- ◎ FIRE HYDRANT (VERIFY LOCATION WITH CIVIL DRAWINGS)
- P.I.V. WITH TAMPER, SEE FIRE PROTECTION DRAWINGS

## NOTES

SEE SHEET A0.2 FOR GENERAL NOTES

- REMARKS
- |   |
|---|
| 100. PAINTED PARKING STRIPING PER CITY STANDARDS. |
| 101. LANDSCAPE AND IRRIGATION AREA.               |
| 102. GUARD SHACK.                                 |
| 103. GATED DRIVEWAY.                              |
| 104. PEDESTRIAN GATE.                             |
| 105. VEHICLE GATE.                                |
| 106. VEHICLE WASH ENCLOSURE.                      |
| 107. MATERIAL BIN.                                |
| 108. SCRAPS BINS.                                 |
| 109. PROPANE TANK.                                |
| 110. PTA TRAINING AREA.                           |
| 111. PIPE LAYDOWN AREA.                           |
| 112. TRASH ENCLOSURE.                             |

## OVERALL SITE PLAN

DATE	REMARKS
1 04/03/2019	PLANNING SUBMITTAL

PAPM:	J. BABINE
DRAWN BY:	E.S.
JOB NO.:	SNR17-0069-00


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## NOTES

SEE SHEET A0.2 FOR GENERAL NOTES

- PAINTED PARKING STRIPING PER CITY STANDARDS.
- LANDSCAPE AND IRRIGATION AREA.
- CHAINLINK FENCE. SEE DETAIL 11/A6.2.
- CHAINLINK GATE. SEE DETAIL 9/A6.2.
- CHAINLINK ROLLING GATE. SEE DETAIL 6/A6.2.
- CONCRETE RAMP.
- GALVANIZED RAILING.
- CONCRETE PAVEMENT.
- EASEMENT LINE.
- RECESSED OR SURFACE MOUNTED KNOX-BOX, INSTALL AT 5'-0" ABOVE FINISH FLOOR.
- TRASH ENCLOSURE. SEE DETAIL 9/A6.1.
- GUARD SHACK.
- GATED DRIVEWAY.
- PEDESTRIAN GATE. SEE DETAIL 10/A6.2.
- VEHICLE GATE. SEE DETAIL 6/A6.2.
- VEHICLE WASH ENCLOSURE.
- MATERIALS BIN.
- SCRAPS BINS.
- PROPANE TANK.
- PTA TRAINING AREA.
- PIPE LAYDOWN AREA.
- WROUGHT IRON FENCING. SEE DETAIL 13/A6.2.
- WROUGHT IRON GATE.

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<b>BUILDING 1 - ENLARGED SITE PLAN</b>	
REF MARKS	PLANNING SUBMITTAL
1	04/03/2019


PA/PM:	J. BABINE
DRAWN BY:	E.S.
JOB NO.:	SNR17-0069-00

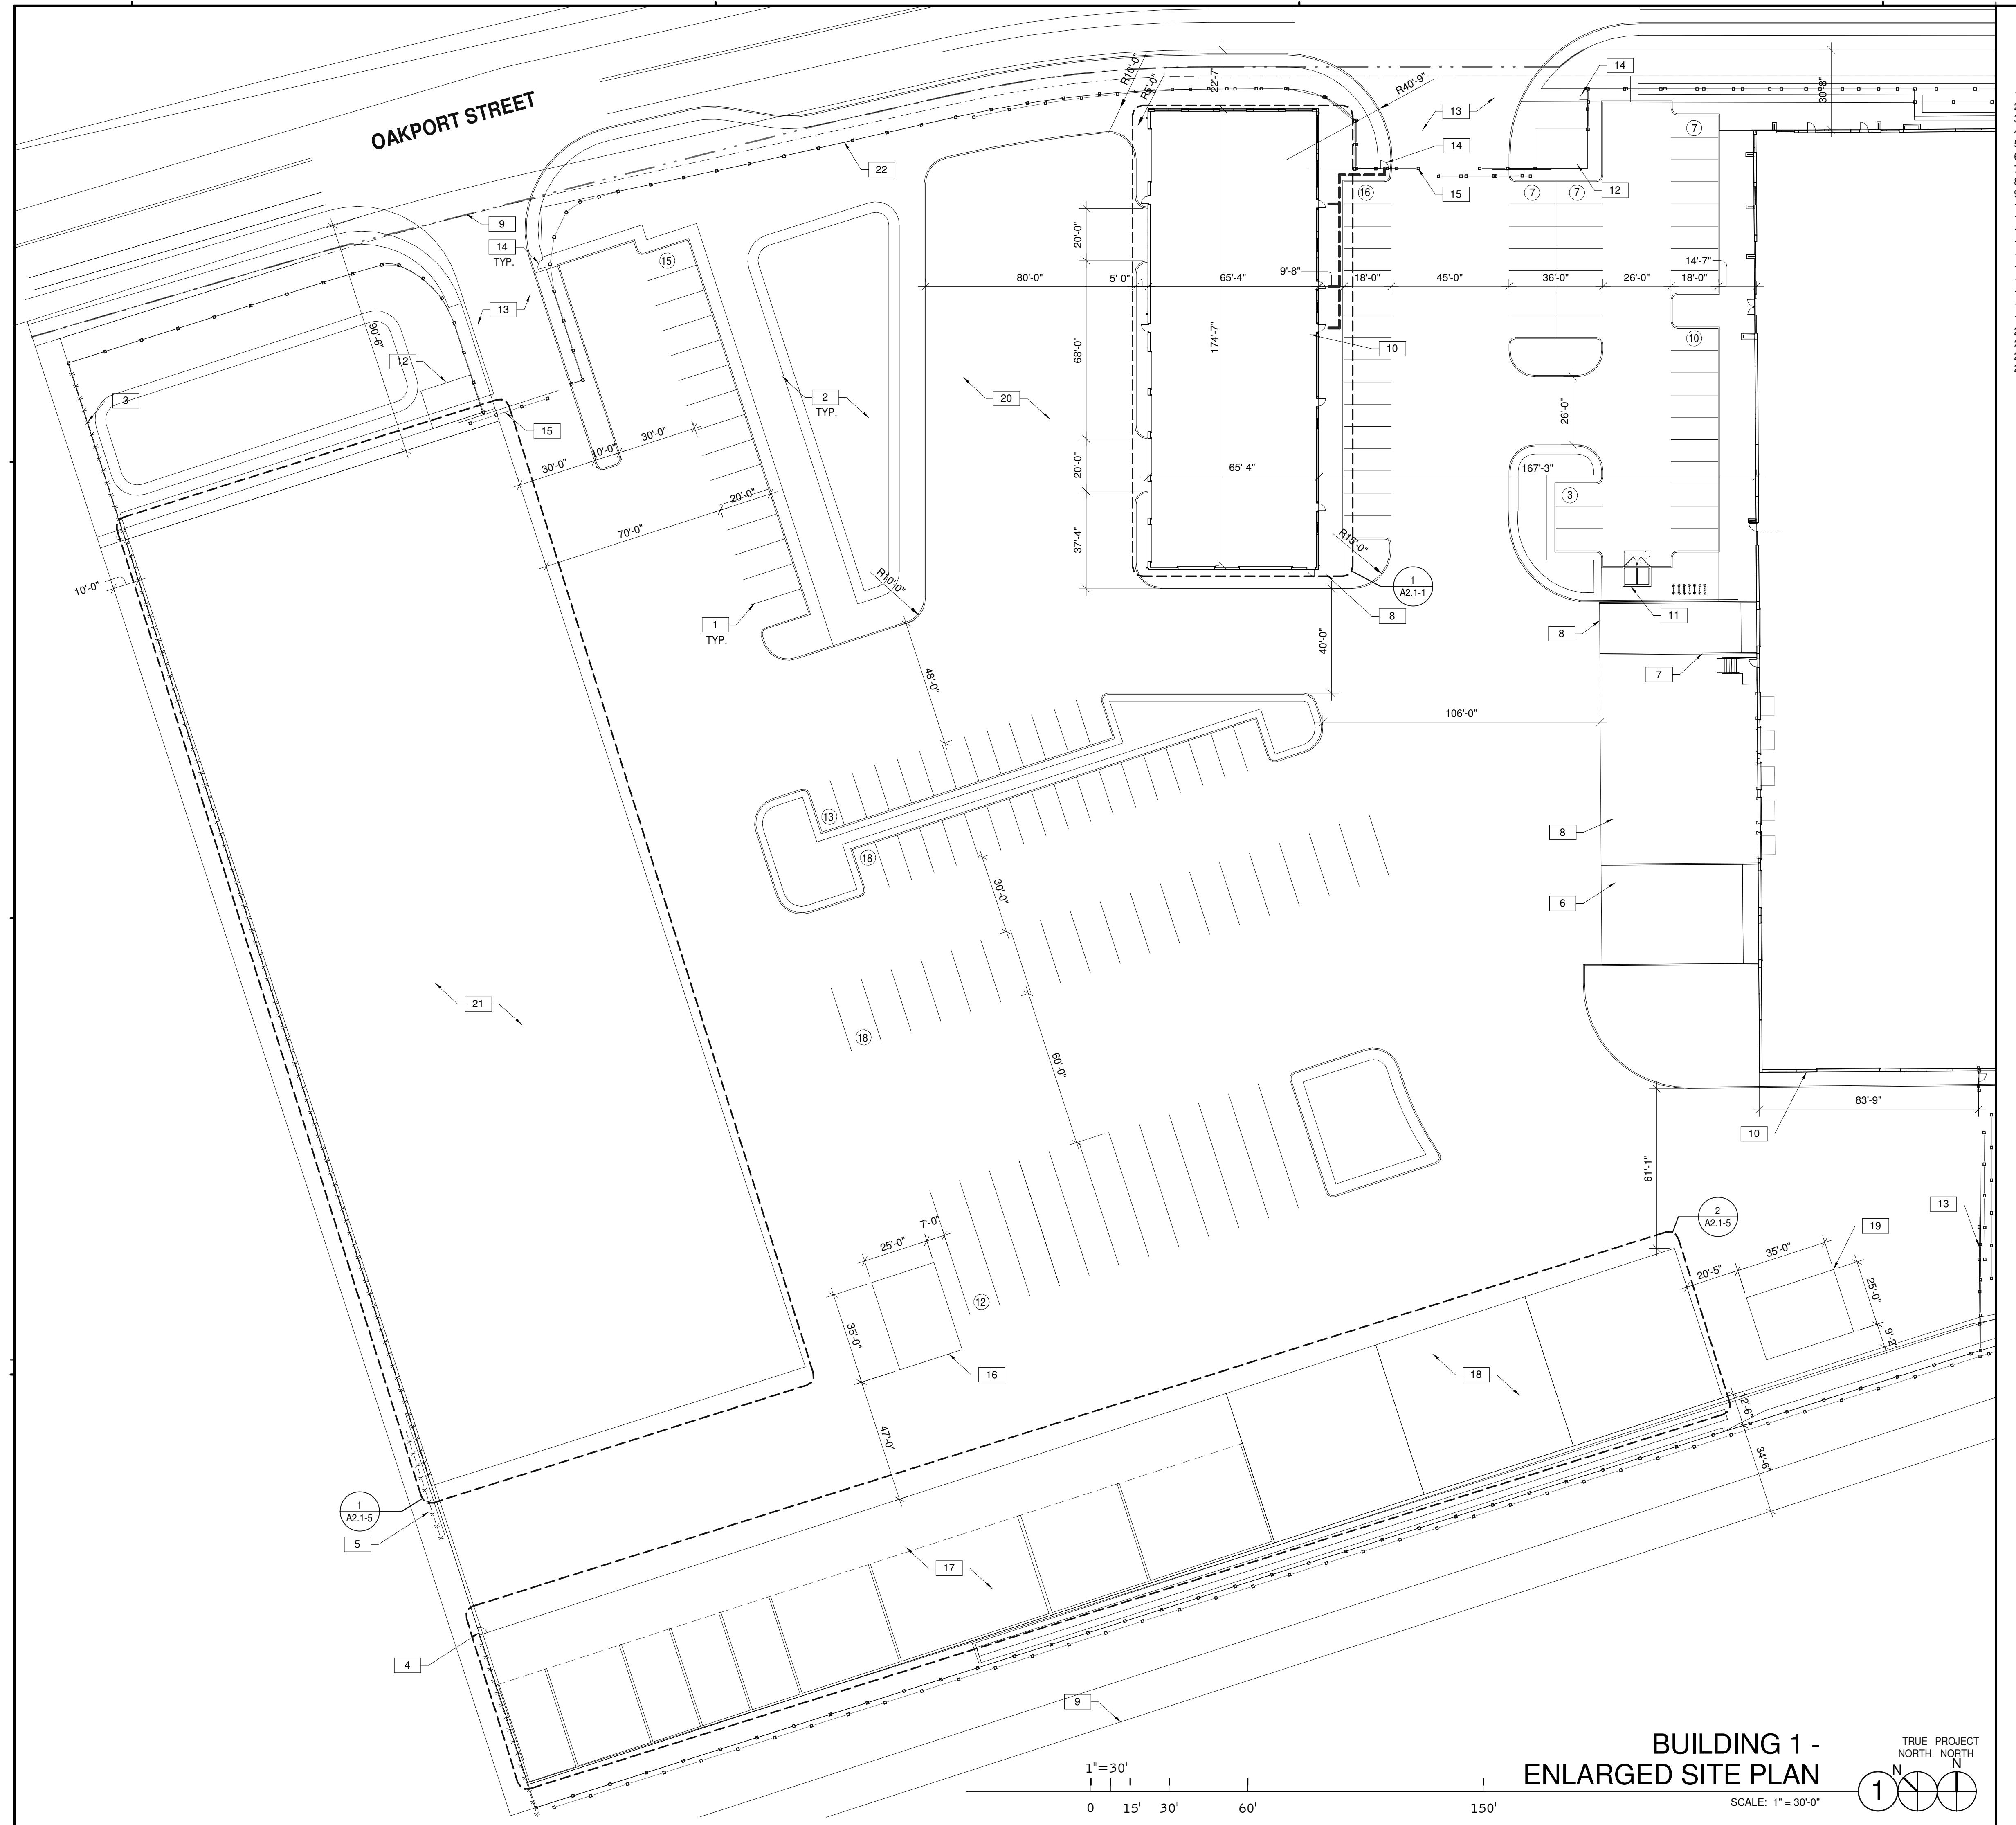
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## SITE LEGEND

- PROPERTY LINE, SEE CIVIL DRAWINGS
- ACCESSIBLE PATH OF TRAVEL, 1:20 MAX. SLOPE, 2% MAX. CROSS SLOPE.
- POLE MOUNTED LIGHT FIXTURE, SEE ELECTRICAL DRAWINGS
- FIRE LANE (HATCHED)
- PARKING STALL COUNT TOTAL
- GRADE LEVEL TRUCK DOOR
- FIRE HYDRANT (VERIFY LOCATION WITH CIVIL DRAWINGS)
- P.I.V. WITH TAMPER, SEE FIRE PROTECTION DRAWINGS


## KEY PLAN



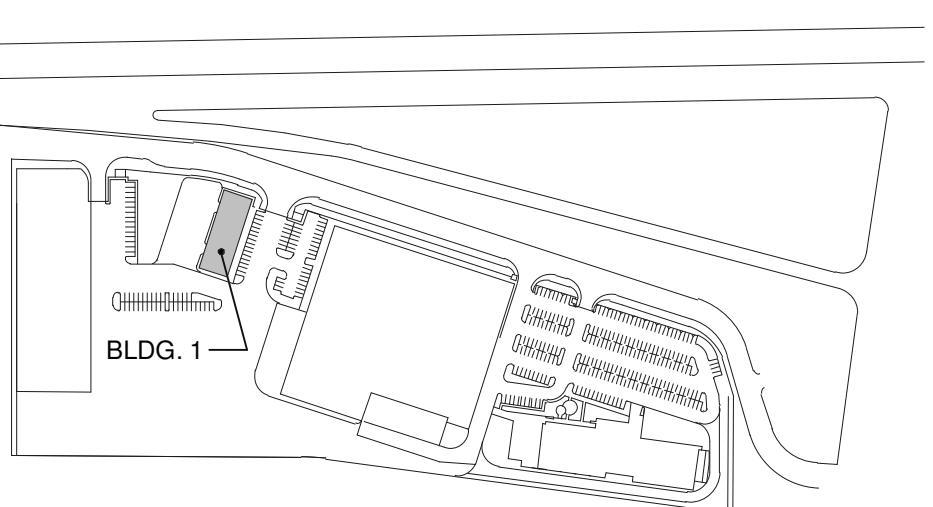

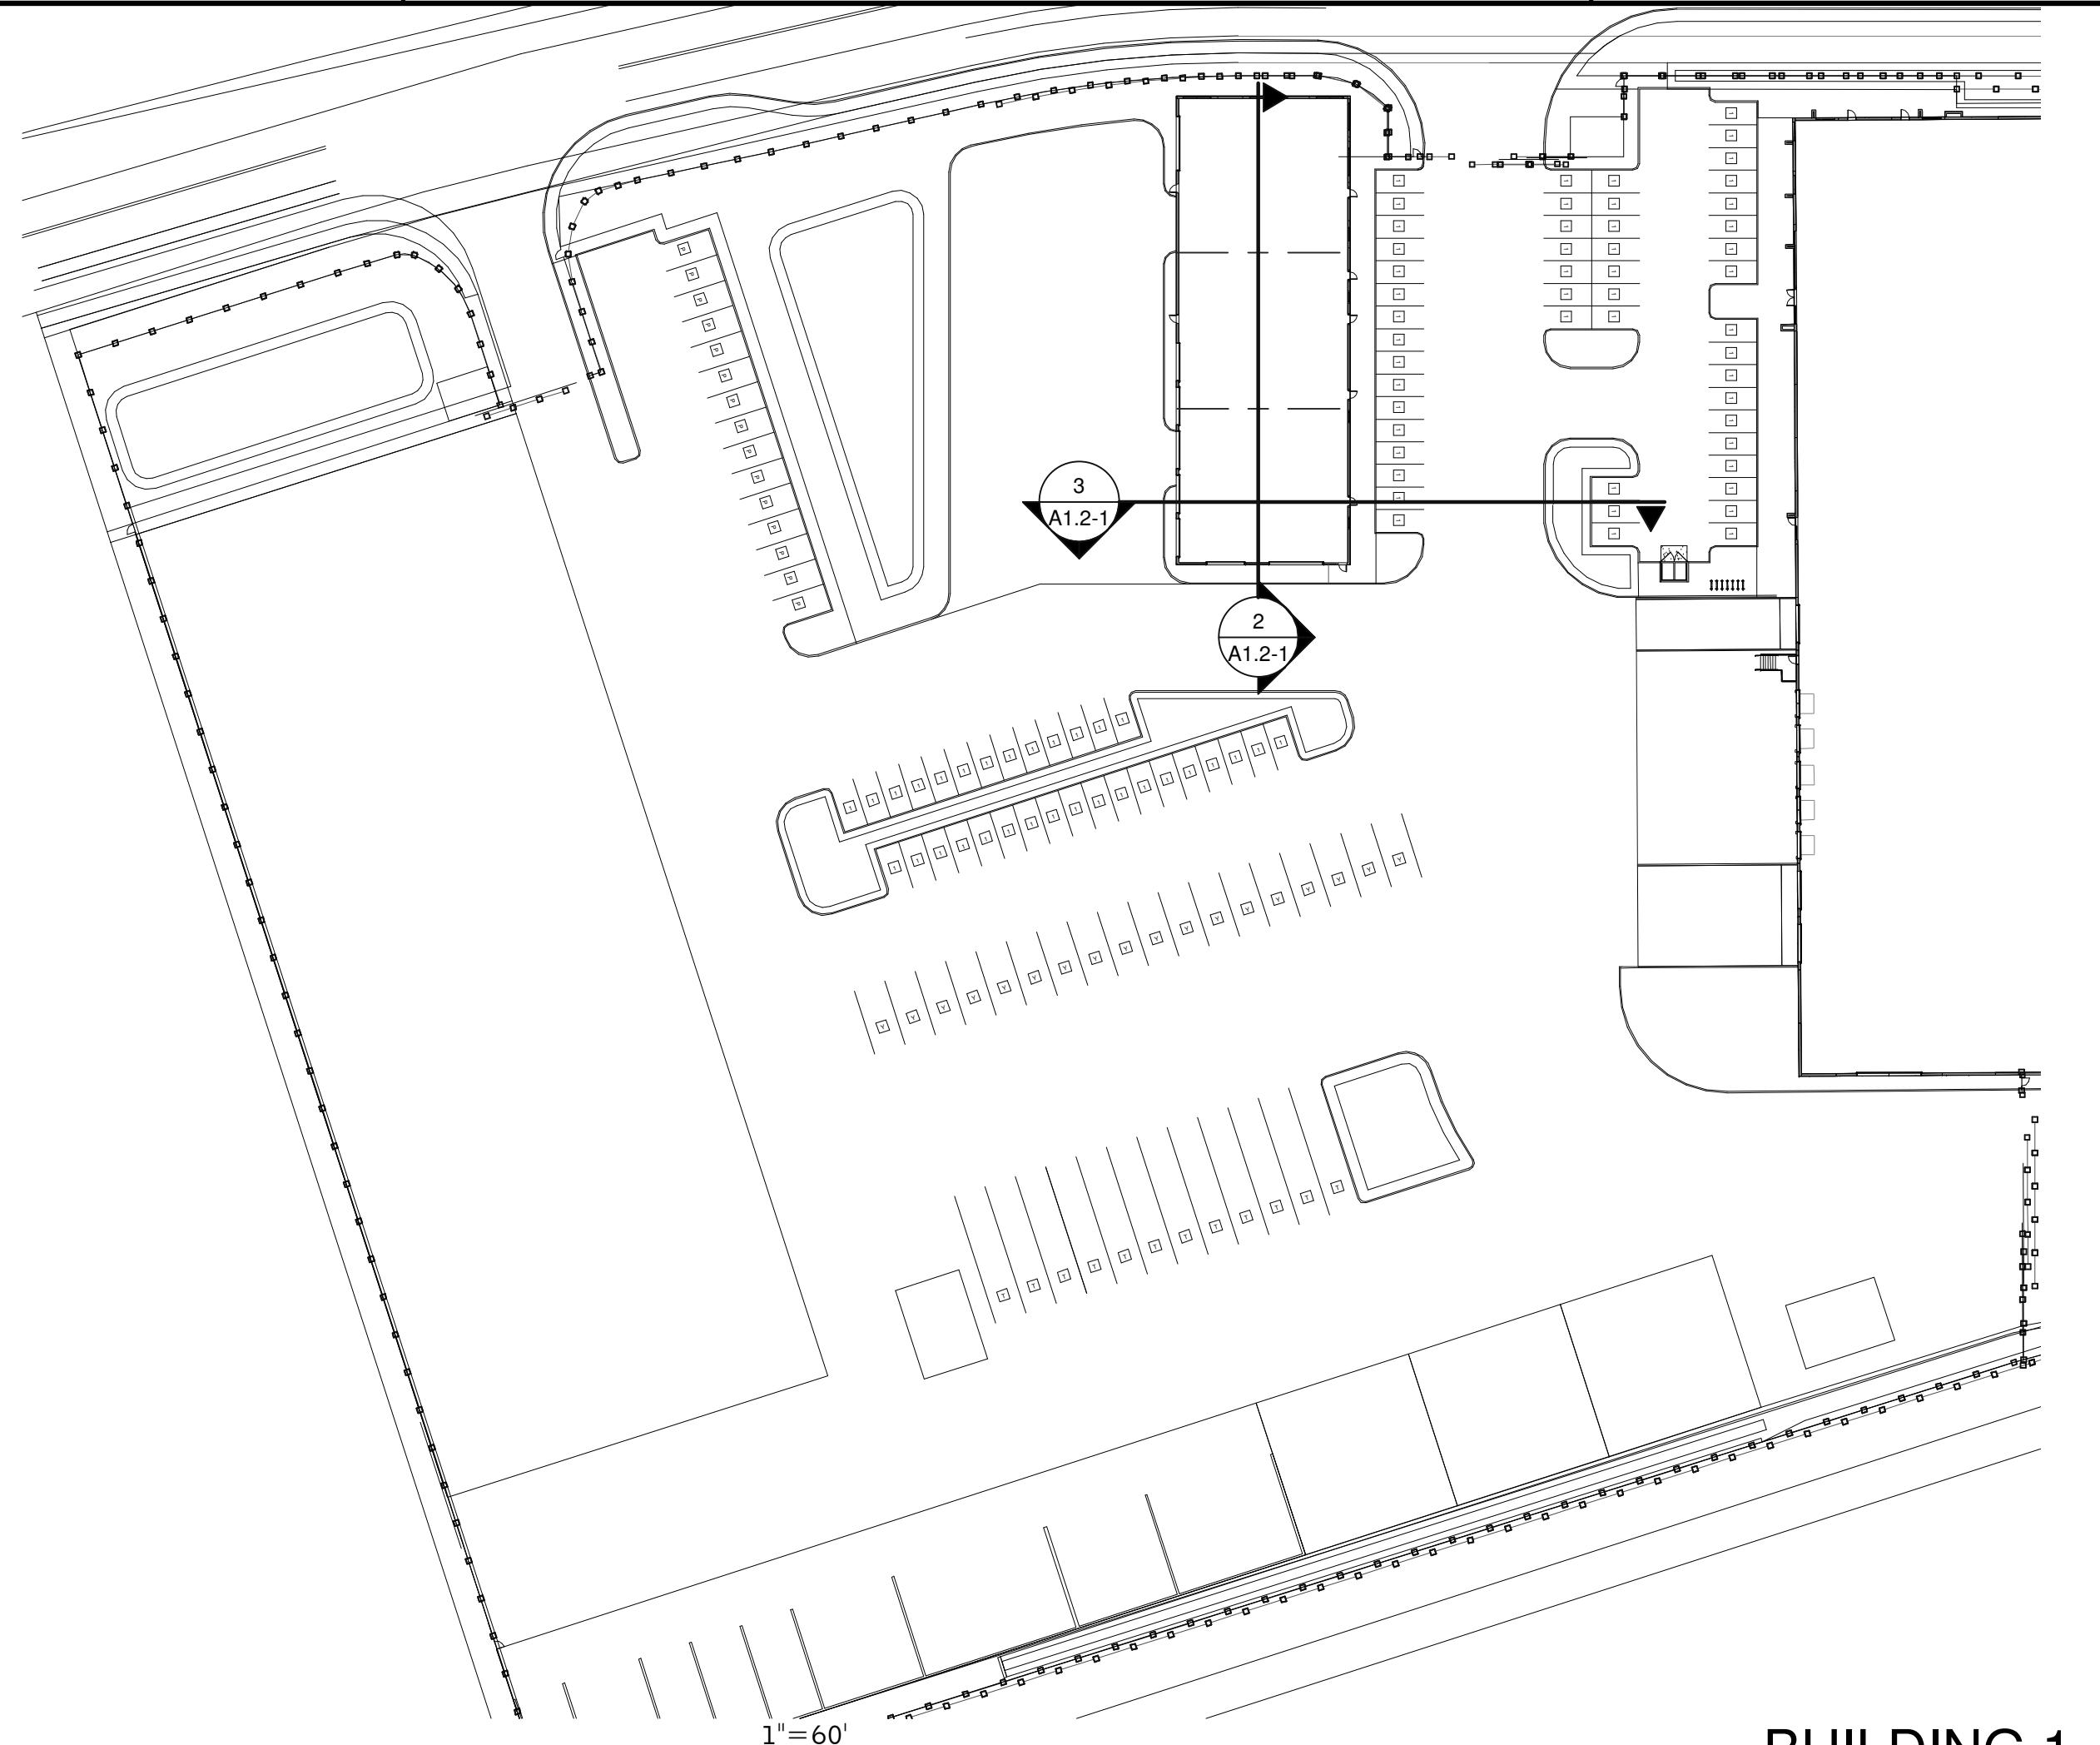
BUILDING 1 - KEY PLAN - SITE SECTION

①

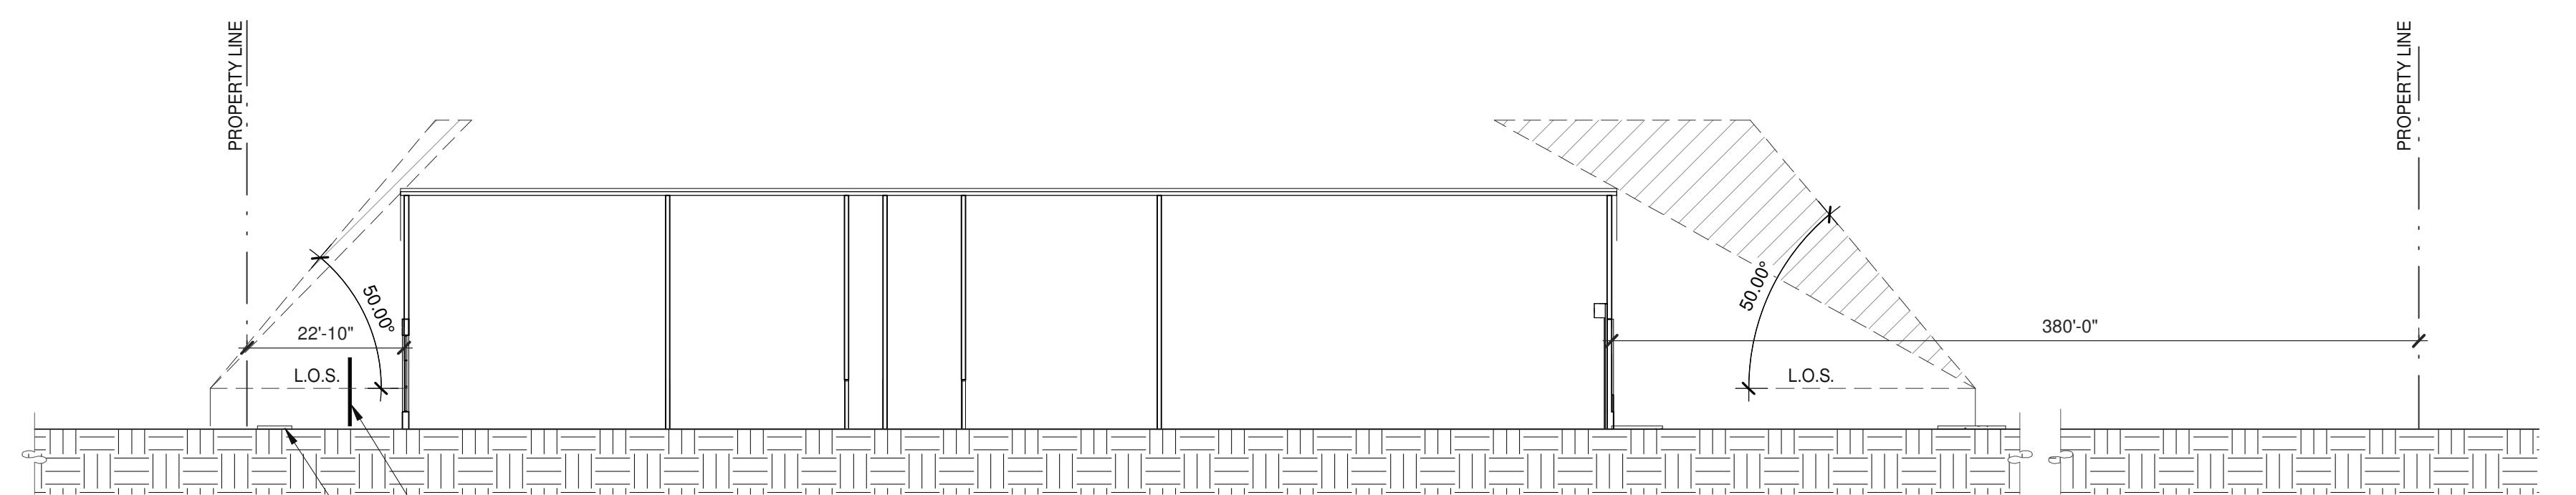

BUILDING 1 - SITE SECTION

②

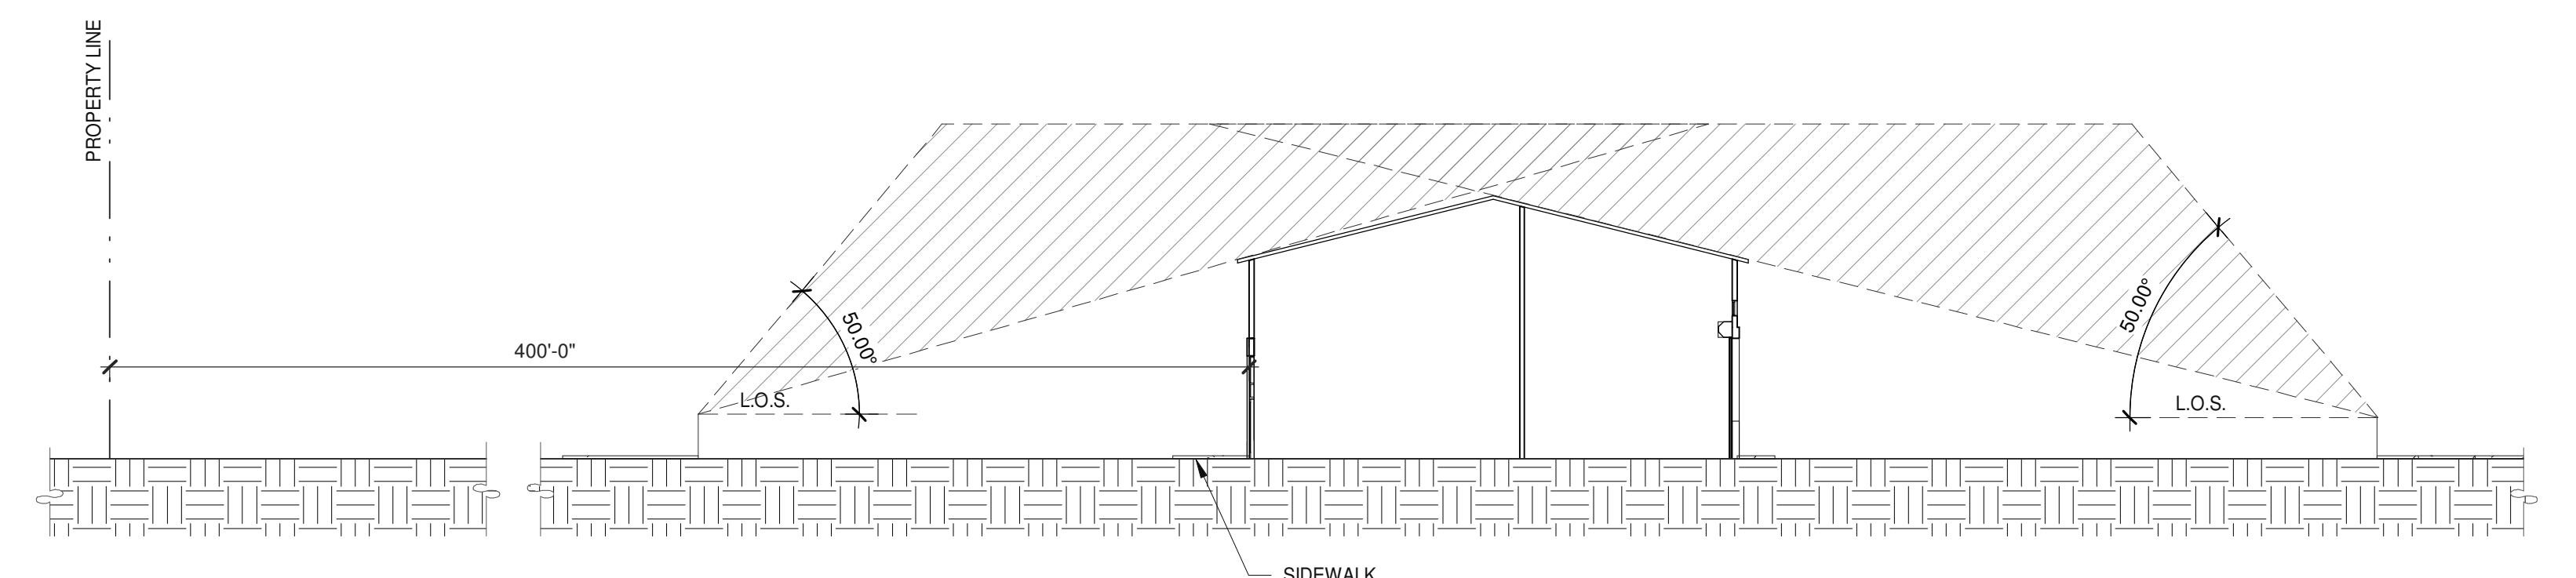

BUILDING 1 - SITE SECTION

③

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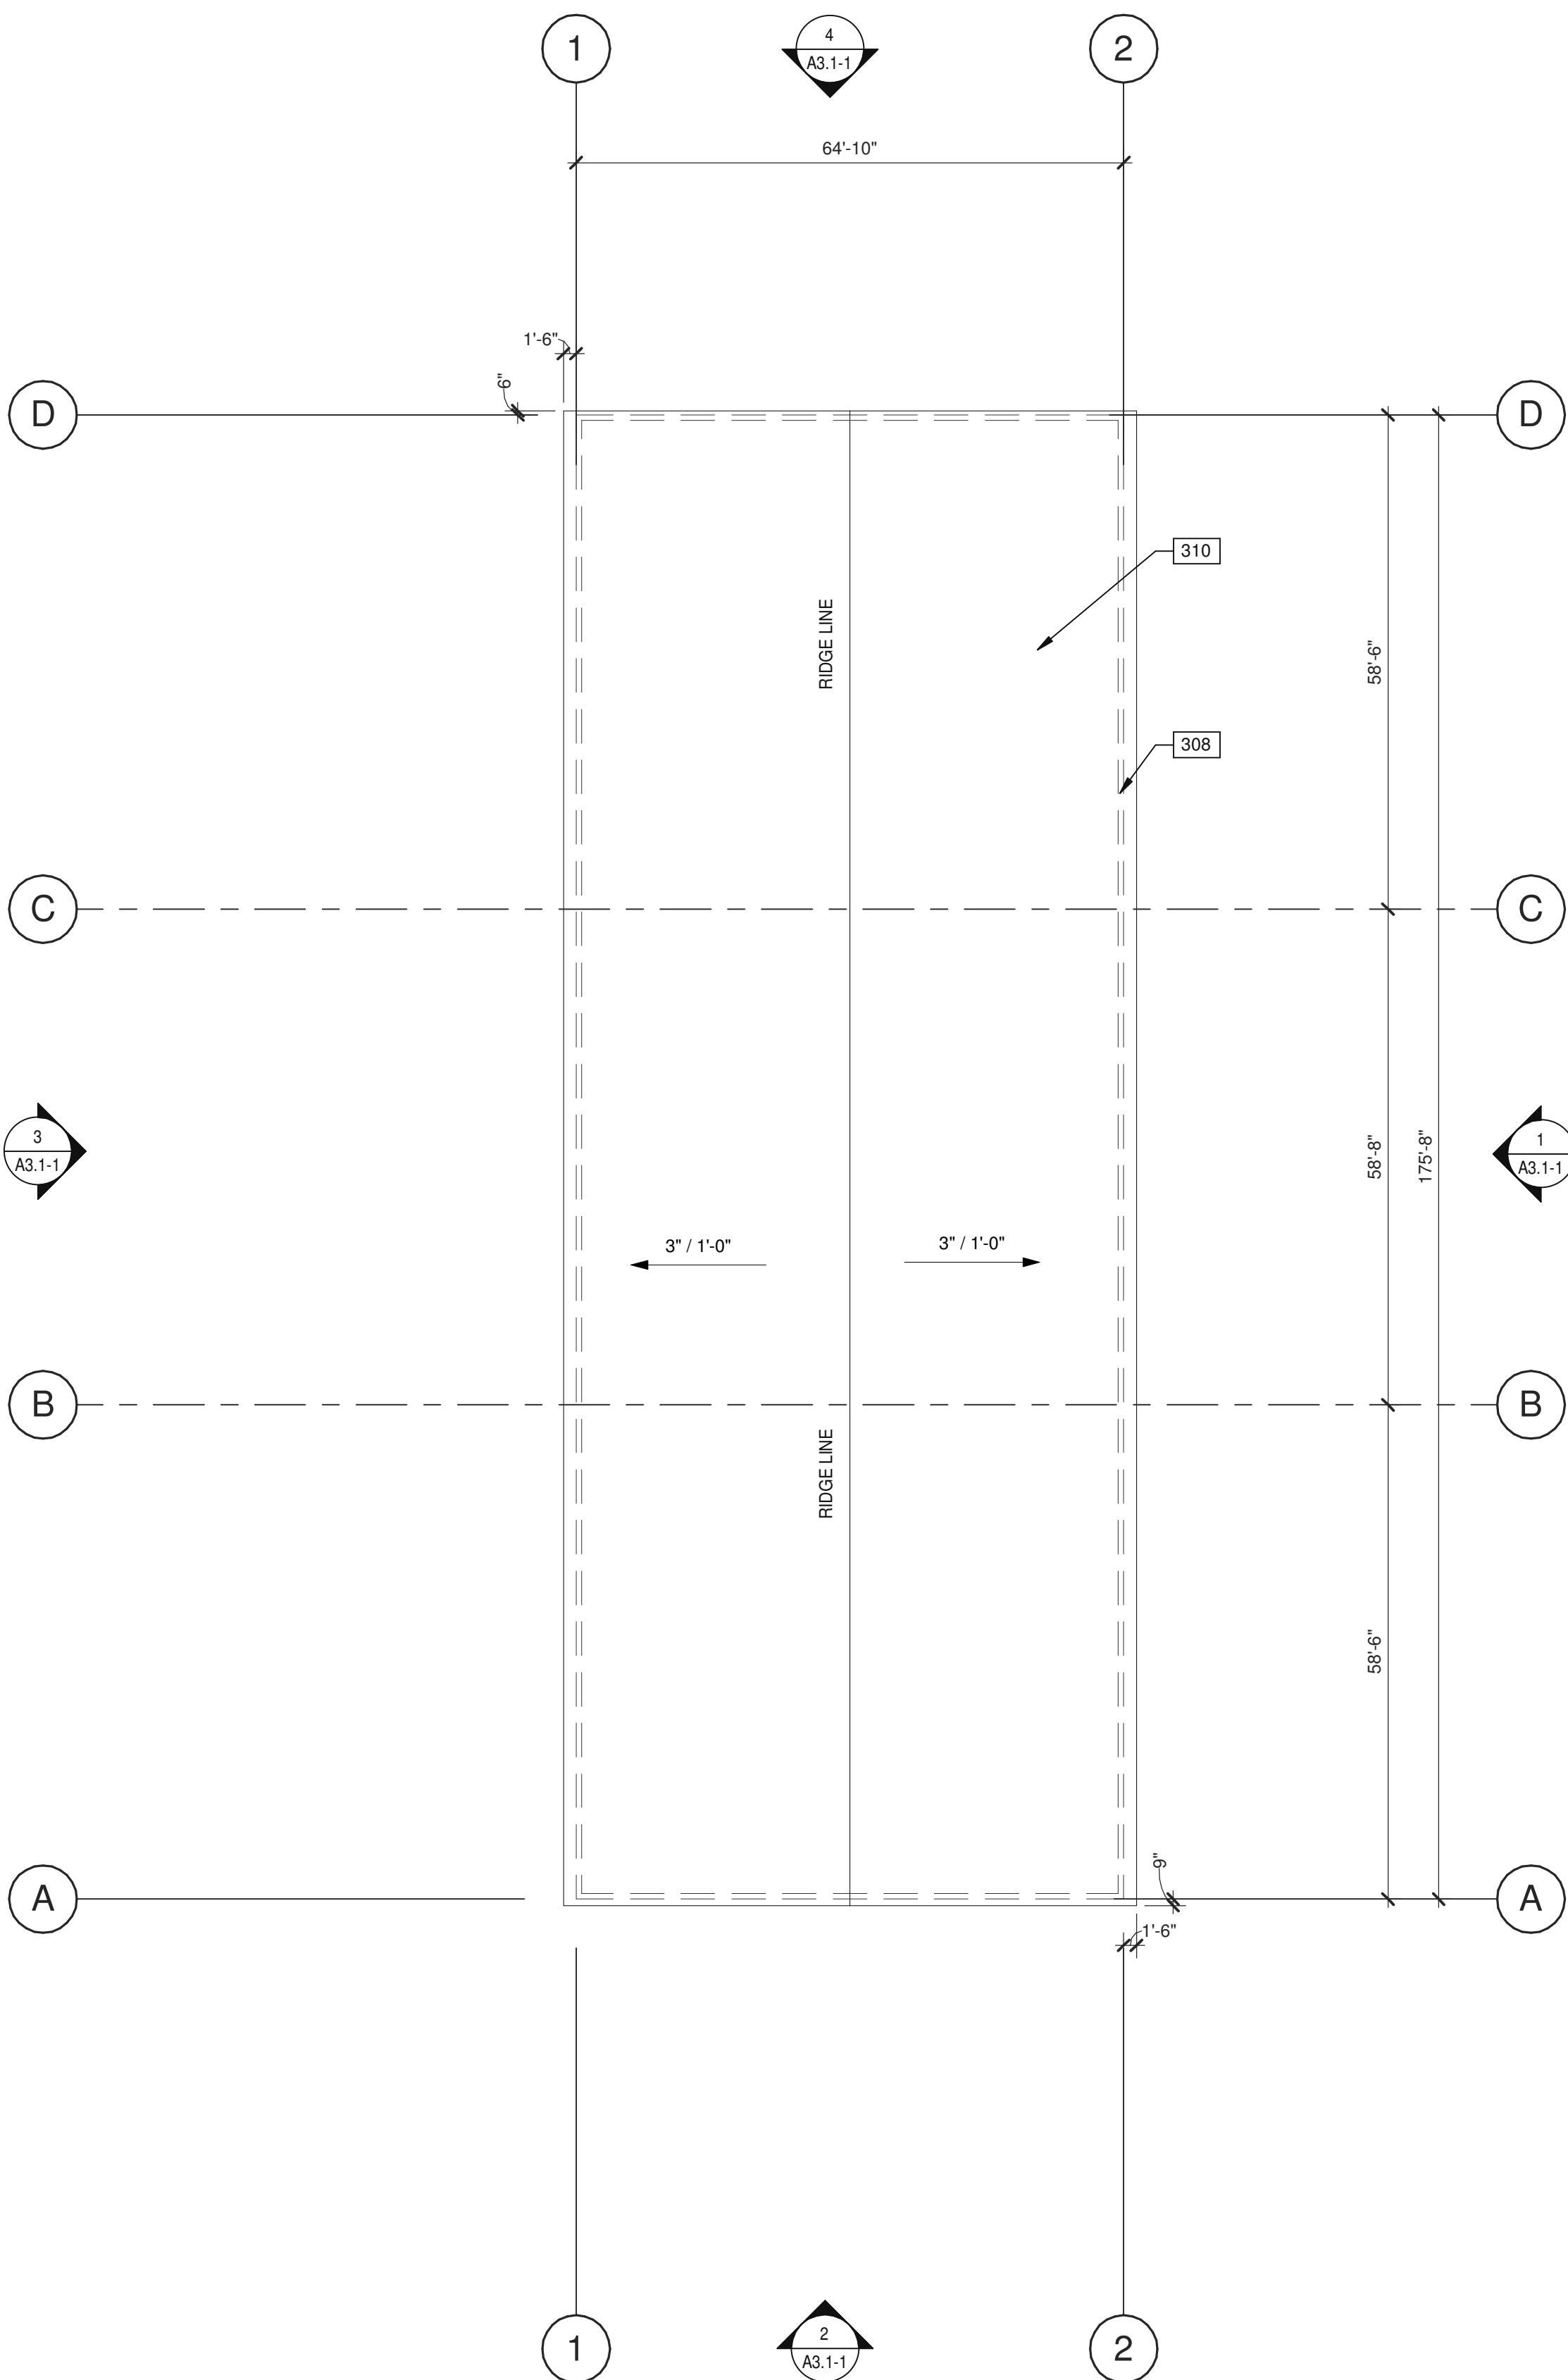
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BUILDING 1 - SITE SECTIONS	
DATE	REMARKS
1 04/03/2019	PLANNING SUBMITTAL


P/APM:	J. BABINE
DRAWN BY:	E.S.
JOB NO.:	SNR17-0069-00

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BUILDING 1 - ROOF PLAN

(2)



BUILDING 1 - FLOOR PLAN

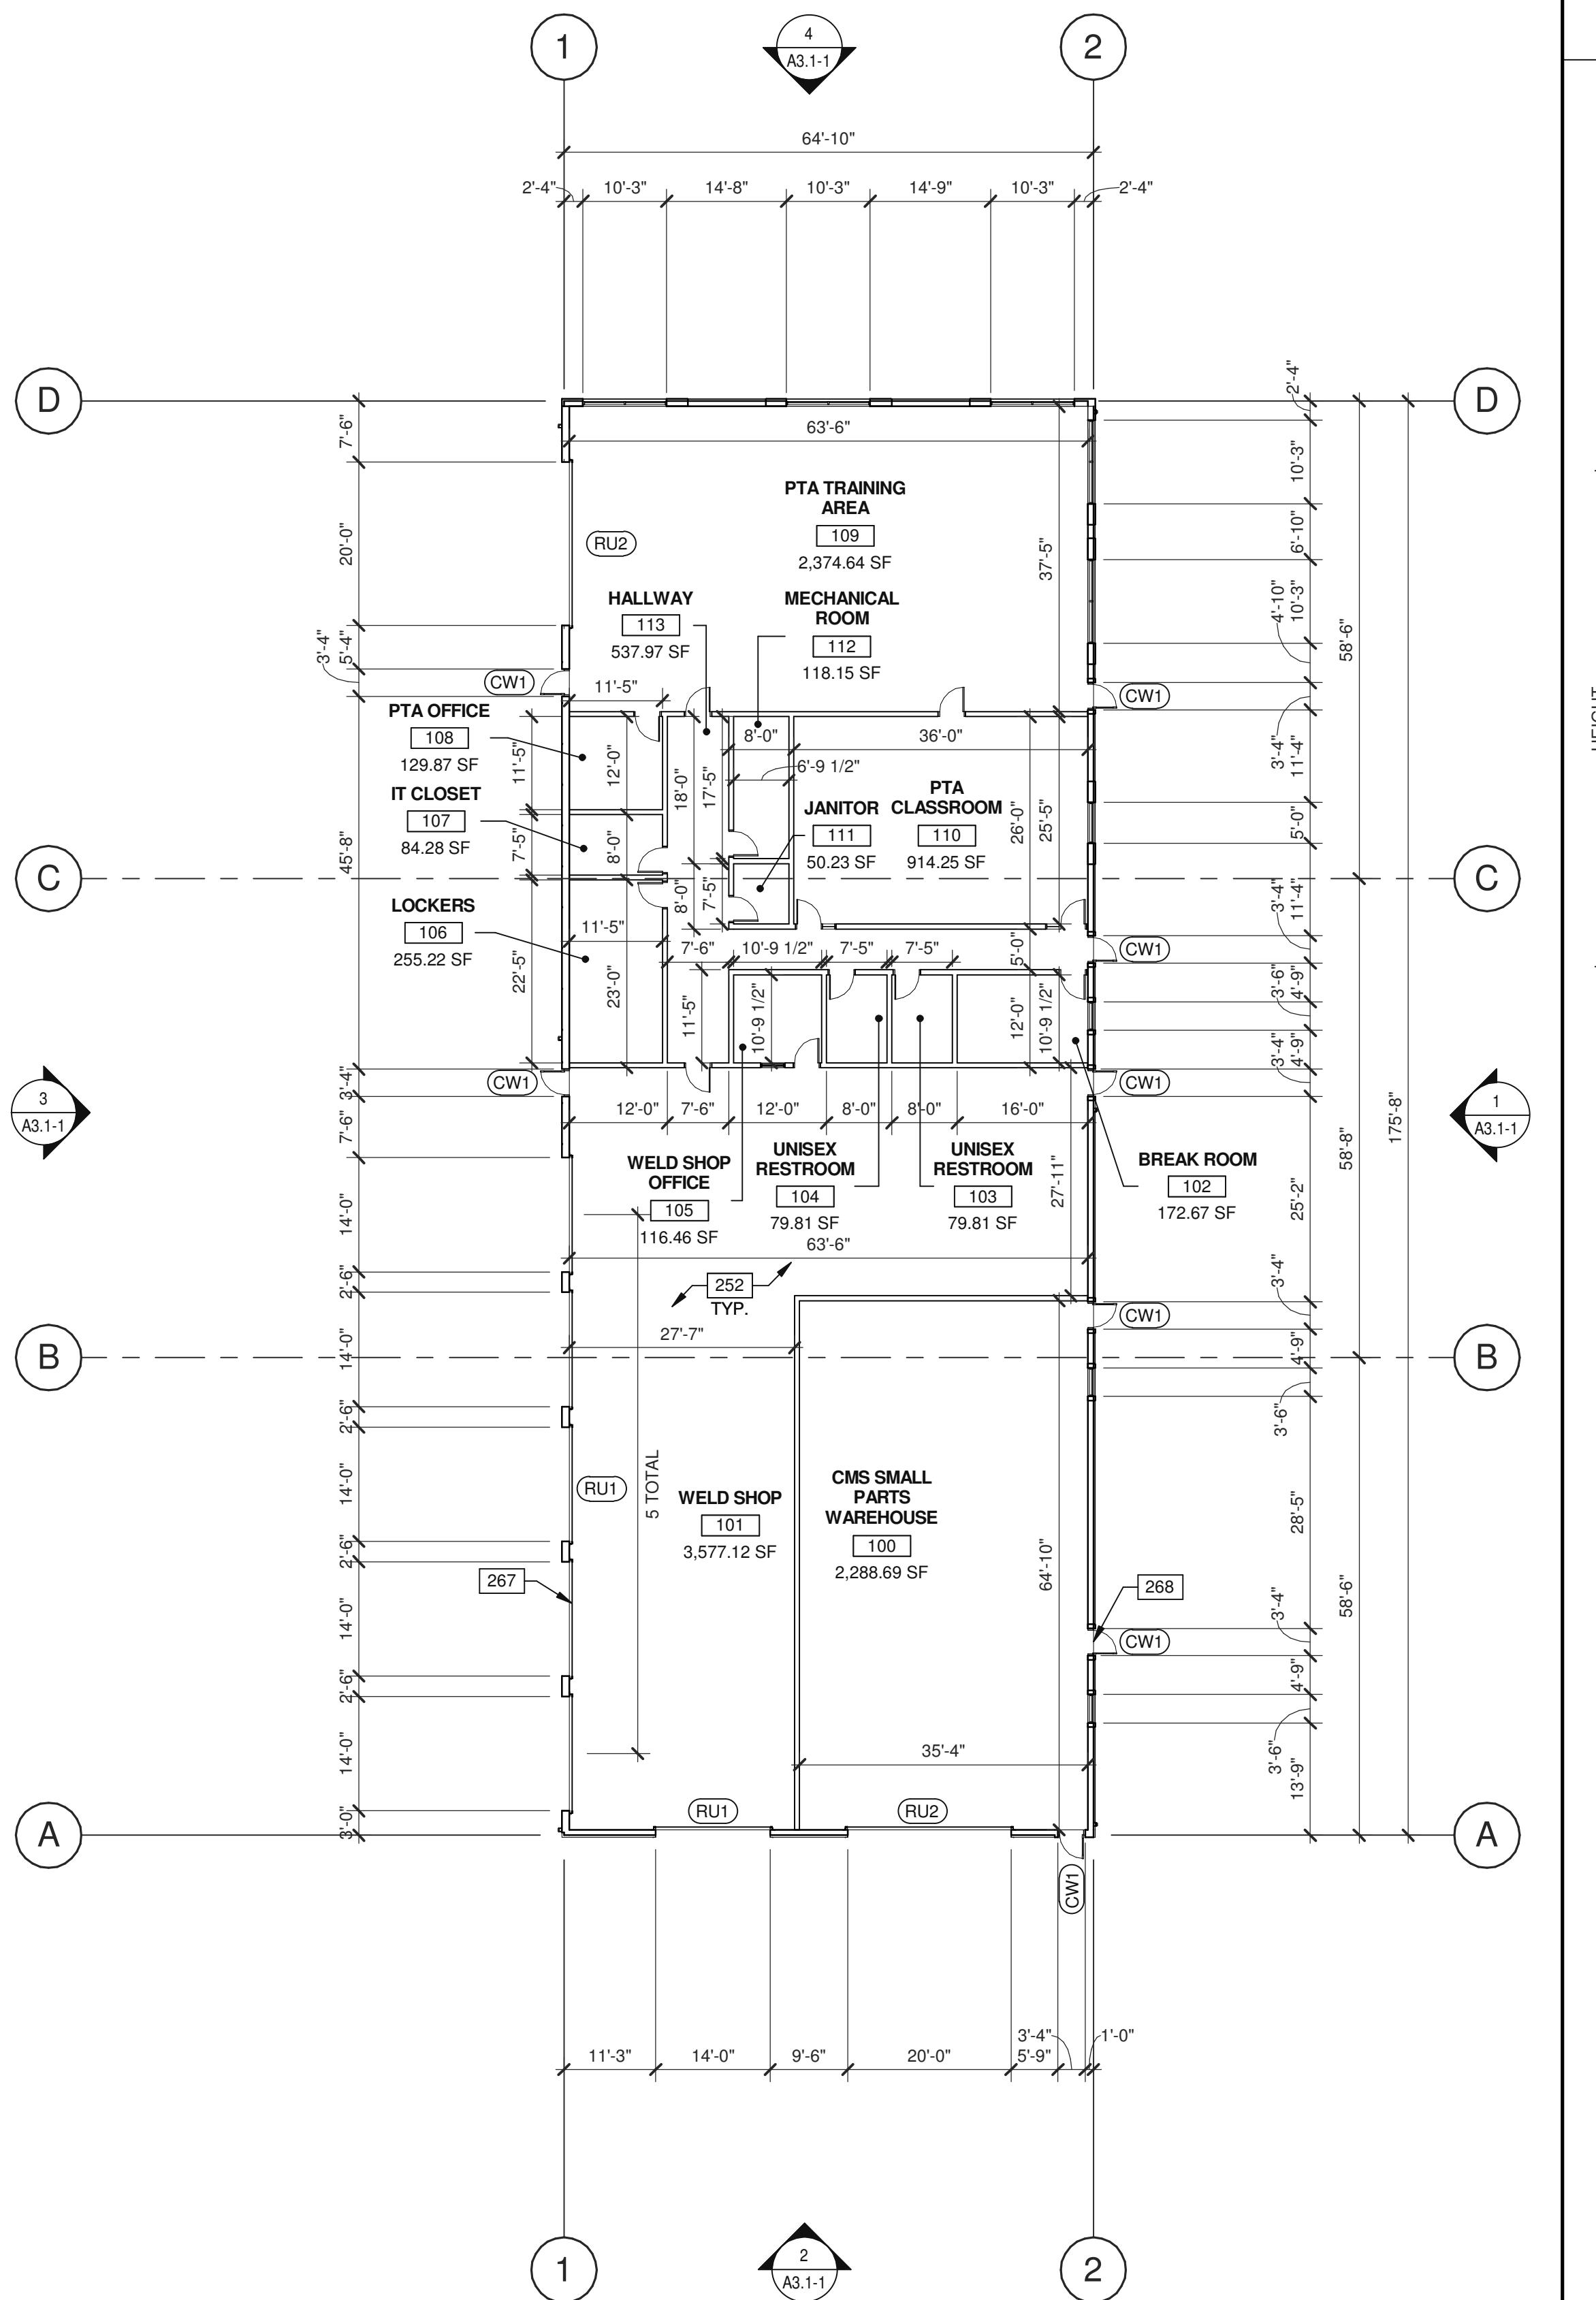(1)

**NOTES****FLOOR PLAN**

- 252 CONCRETE SLAB. PROVIDE VAPOR RETARDER OVER SAND BASE AT OFFICE AREA PER SOILS REPORT. PROVIDE SEALER FOR CONCRETE FLOOR AREA IN WAREHOUSE.  
267 ROLL UP DOOR (GRADE LEVEL), SEE ELEVATIONS.  
268 NARROWSTILE STOREFRONT ENTRANCE.

**ROOF PLAN**

- 308 ROOF HATCH, VERIFY JOIST LOCATIONS WITH STRUCTURAL DRAWINGS.  
310 STANDING SEAM METAL ROOF OVER RIGID INSULATION.

**DOOR TYPES**

(SF2) 6'-0" x 8'-0" (PAIR)  
CLEAR ANOD. ALUM. STOREFRONT  
DOOR W/TEMPERED GLAZING  
(NARROW STILE)

FRAME: MANUFACTURER

HARDWARE:  
2 SETS PIVOT SET  
2 SETS INTER PIVOT  
1 EA MORTISE CYLINDER  
2 SETS OFFSET PULL  
2 EA OH CLOSER  
1 EA THRESHOLD  
1 EA DECAL

NOTE: WEATHERSEAL BY DOOR  
MANUFACTURER

(RU1) 14'-0" x 16'-0"  
ROLL UP DOOR W/ FACTORY  
PAINTED FINISH

(RU2) 20'-0" x 16'-0"  
ROLL UP DOOR W/ FACTORY  
PAINTED FINISH

HARDWARE:  
1 EA SLIDE BOLT  
1 EA PAD LOCK

**DOOR NOTES****BUTT HINGES:**

SOSS - STANDARD WEIGHT, PLAIN BEARING, STEEL HINGES OR APPROVED EQUAL.  
ALL EXTERIOR OUTSWING DOOR BUTTS SHALL BE MADE OF NON-FERROUS  
MATERIAL AND SHALL HAVE STAINLESS STEEL HINGE PINS.  
VON DUPRIN 99 SERIES PANIC DEVICE OR APPROVED EQUAL  
CLOSING DEVICES: NORTON 8500 BF-SERIES OR APPROVED EQUAL  
STOP: TRIMCO W1200 SERIES DOOR STOP  
SLIDE BOLT AND PAD LOCK: INSTALL SLIDE BOLT ABOVE LEVEL OF DOOR GUARD

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**BUILDING 1 - FLOOR & ROOF PLANS**

REMARKS


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DRAWN BY:	E.S.
JOB NO.:	SNR17-0069-00

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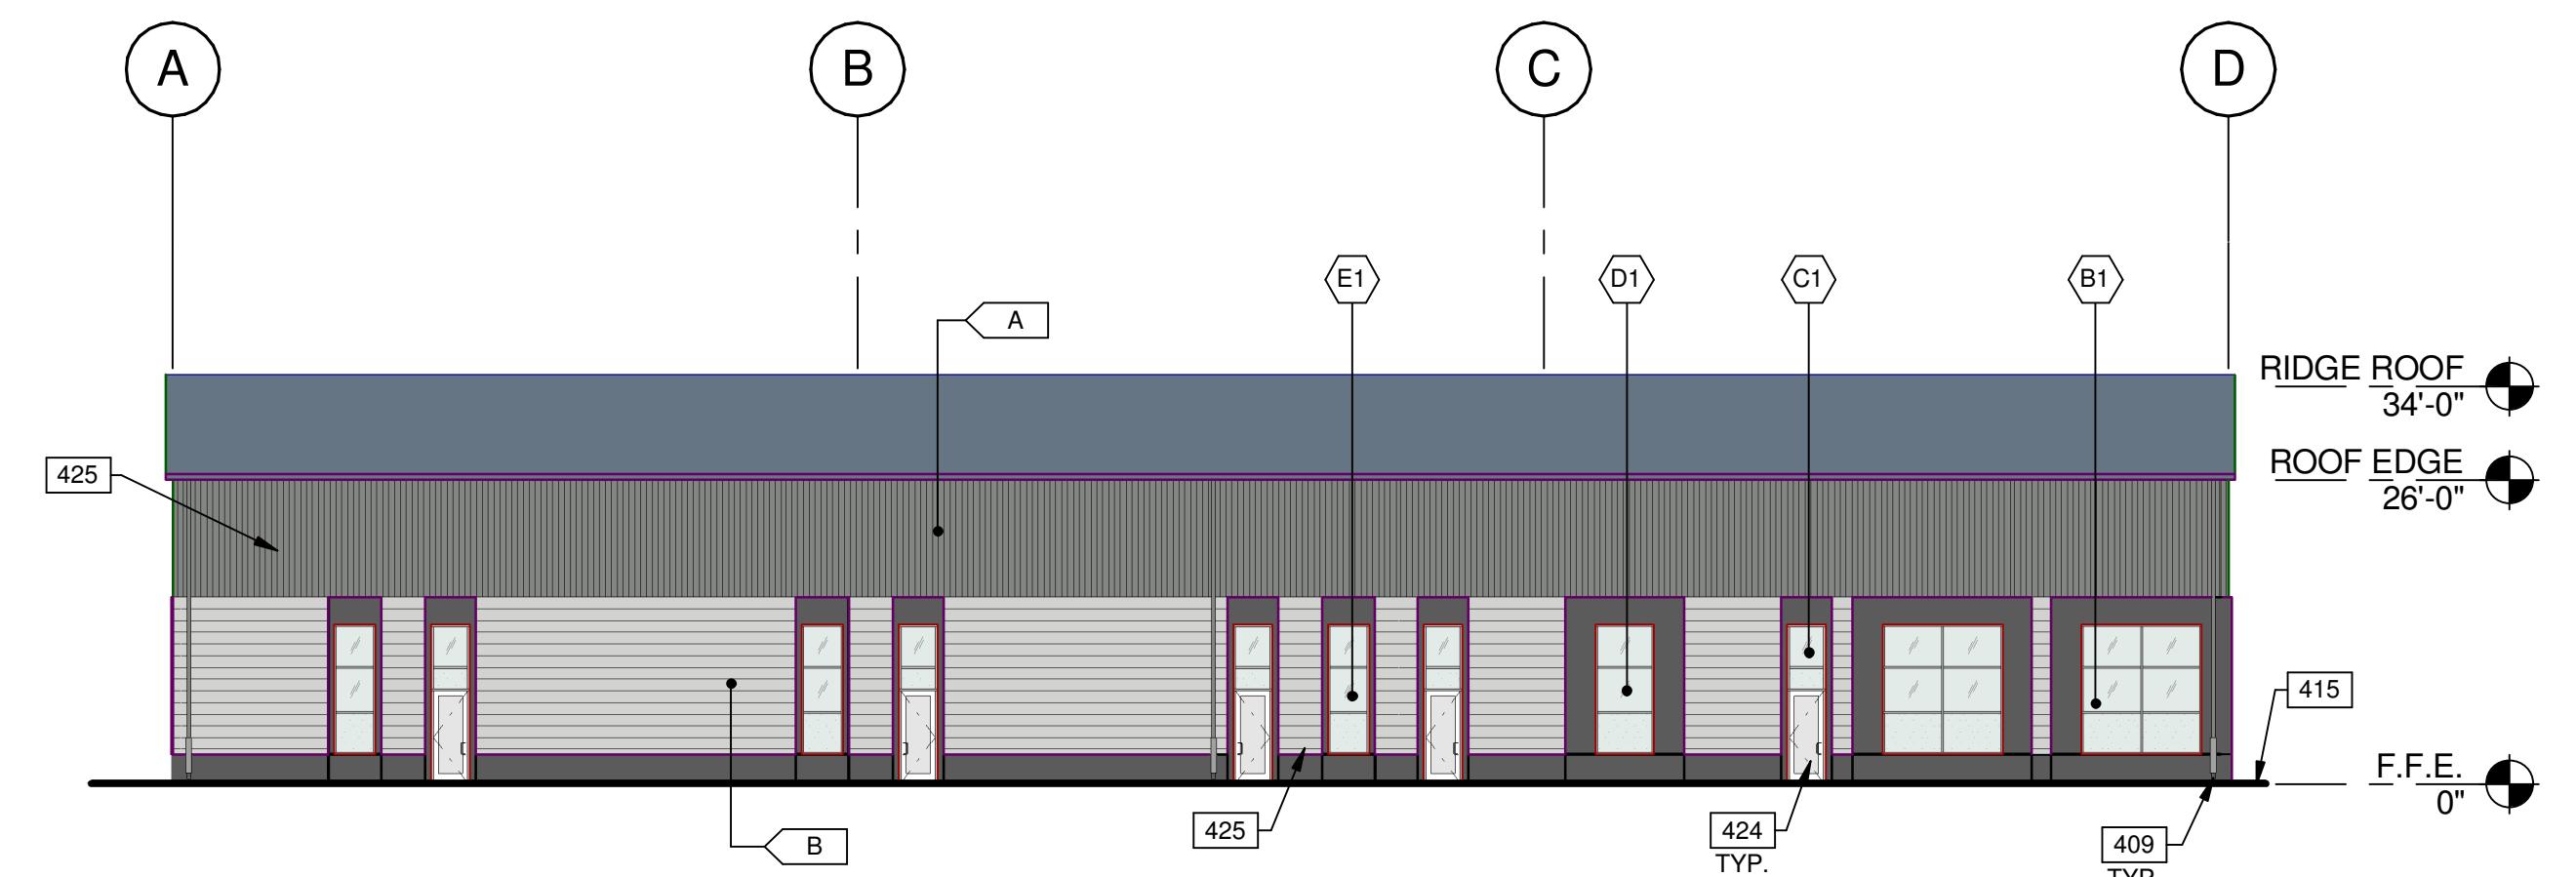
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BUILDING 1 - WEST EXTERIOR ELEVATION

SCALE: 1/16" = 1'-0"


3

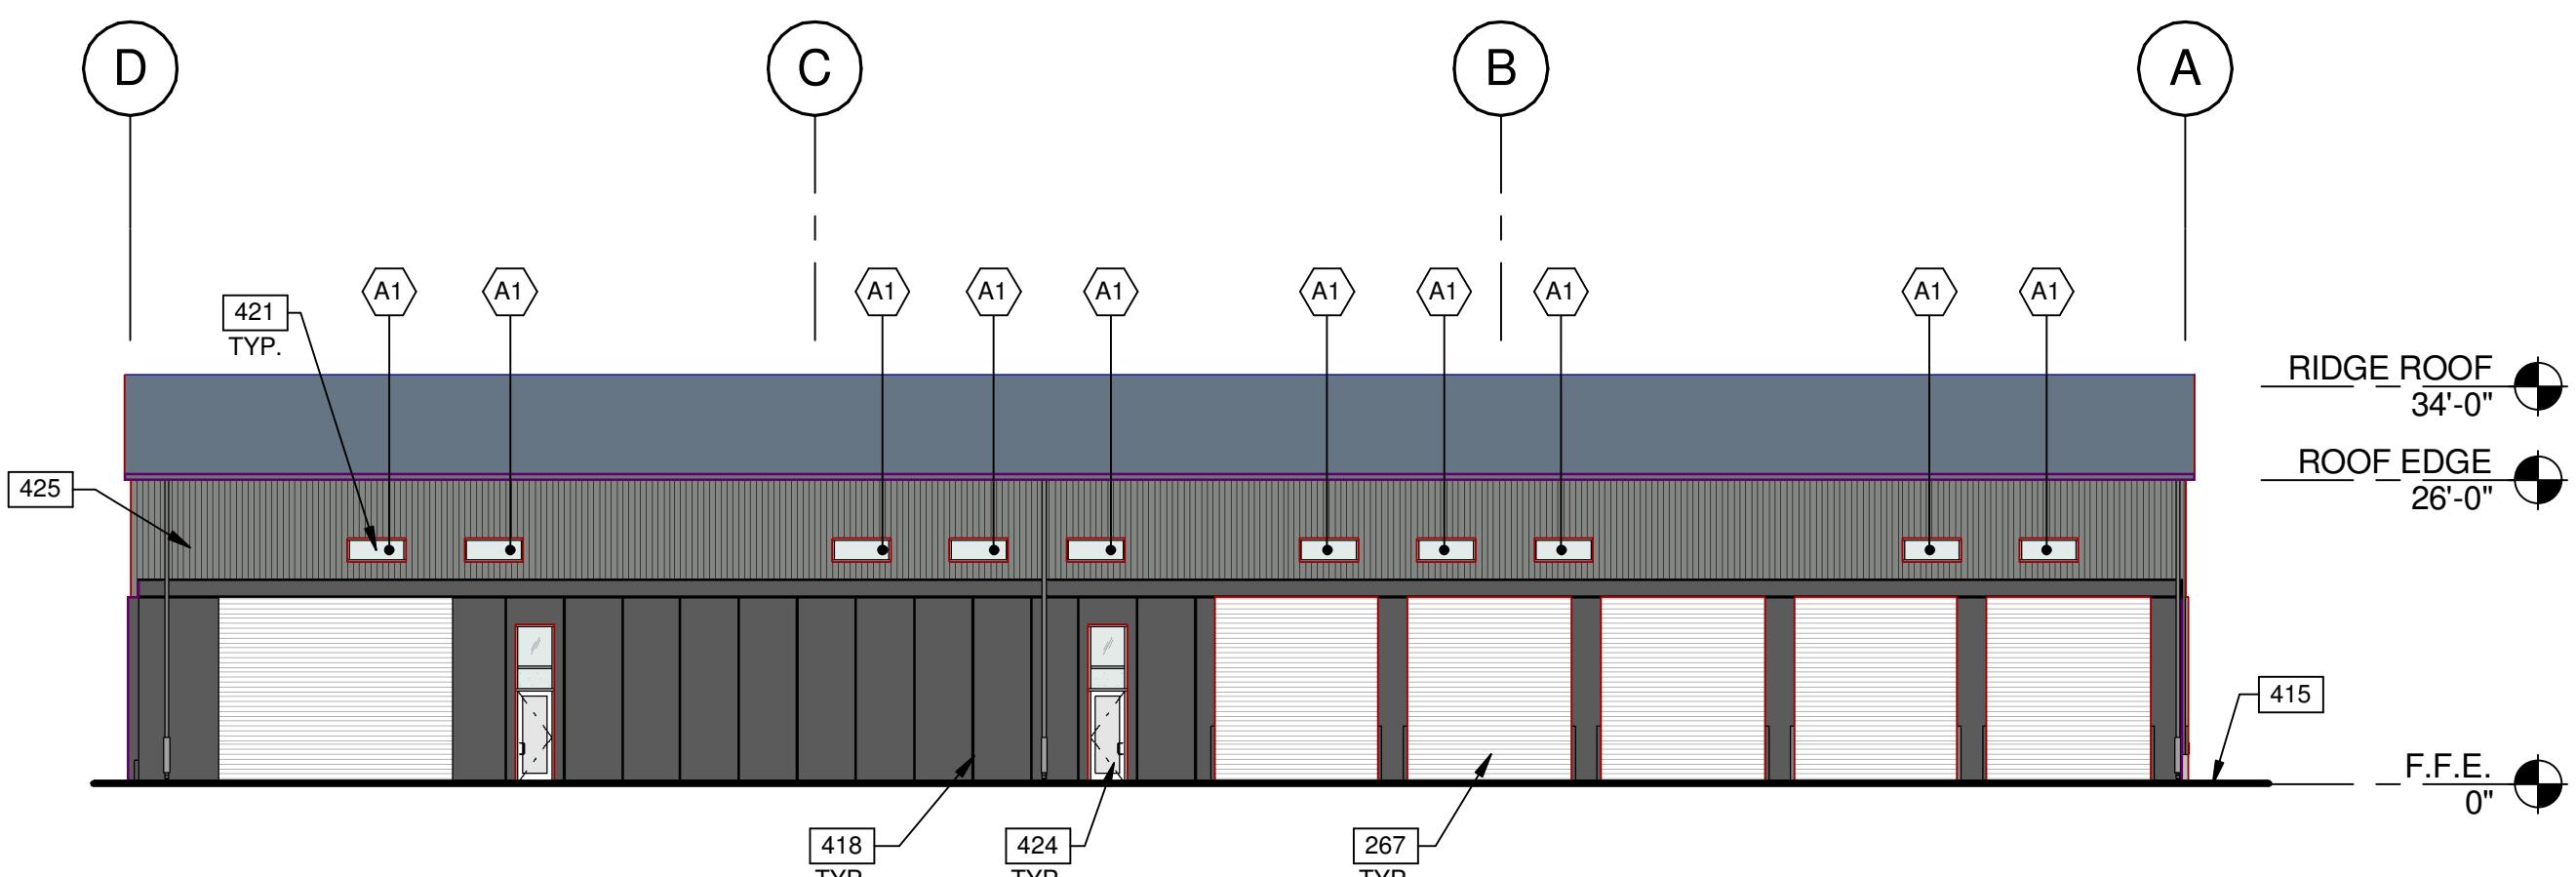

BUILDING 1 - EAST EXTERIOR ELEVATION

SCALE: 1/16" = 1'-0"


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BUILDING 1 - NORTH EXTERIOR ELEVATION

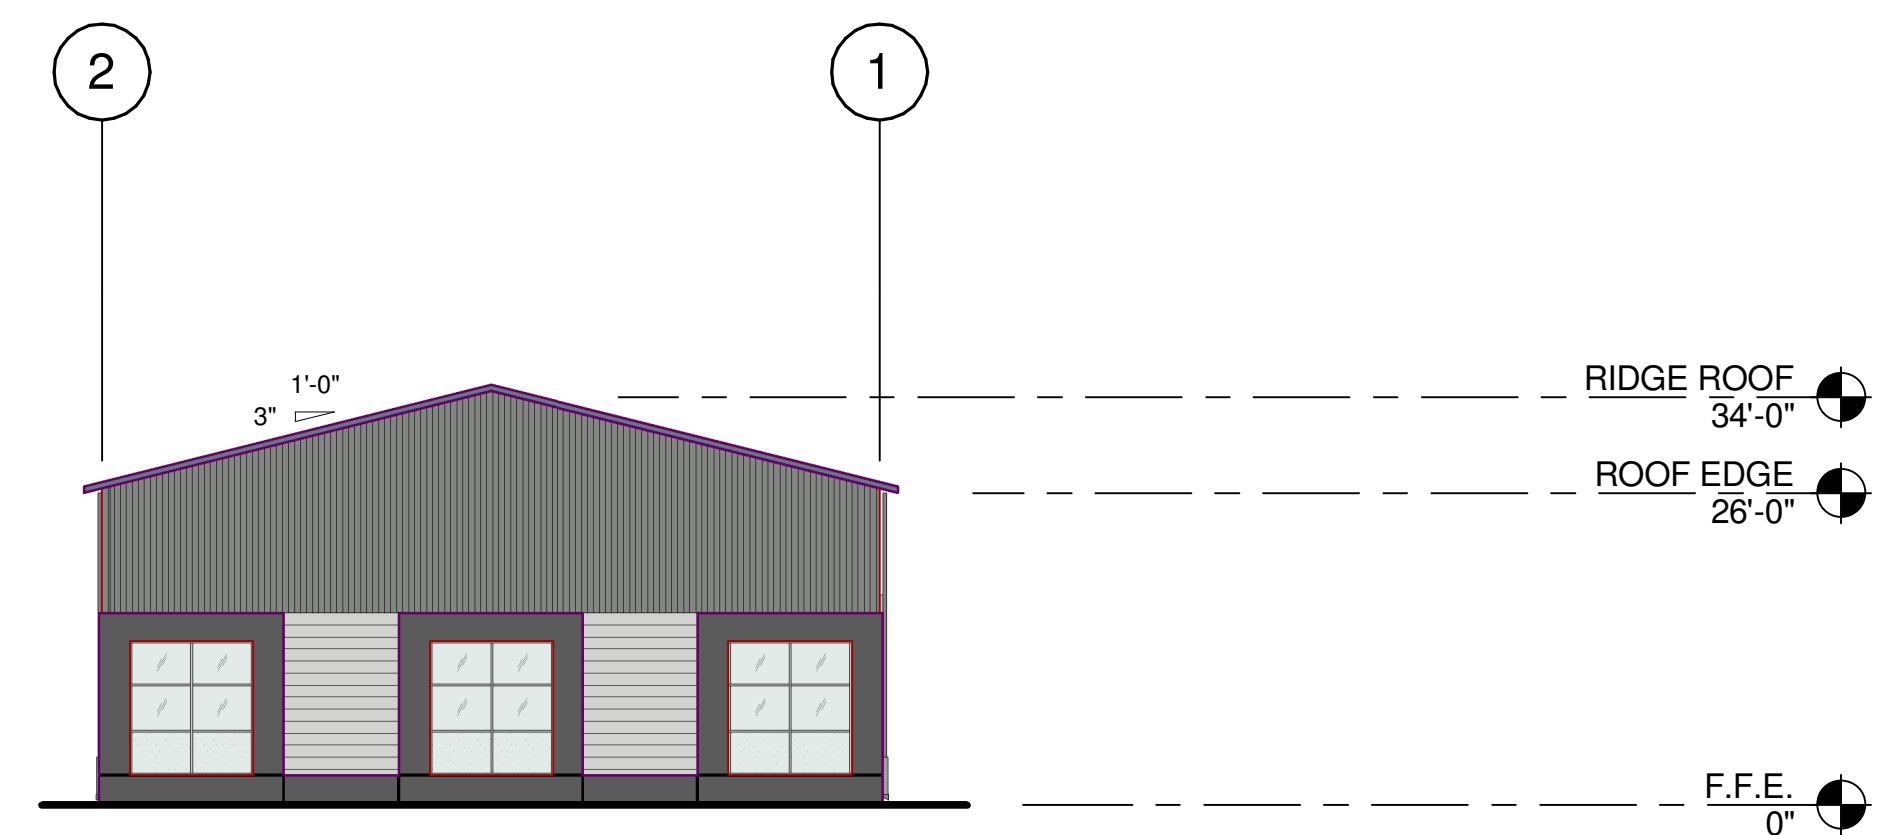SCALE: 1/16" = 1'-0"

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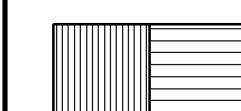
BUILDING 1 - SOUTH EXTERIOR ELEVATION

SCALE: 1/16" = 1'-0"

2
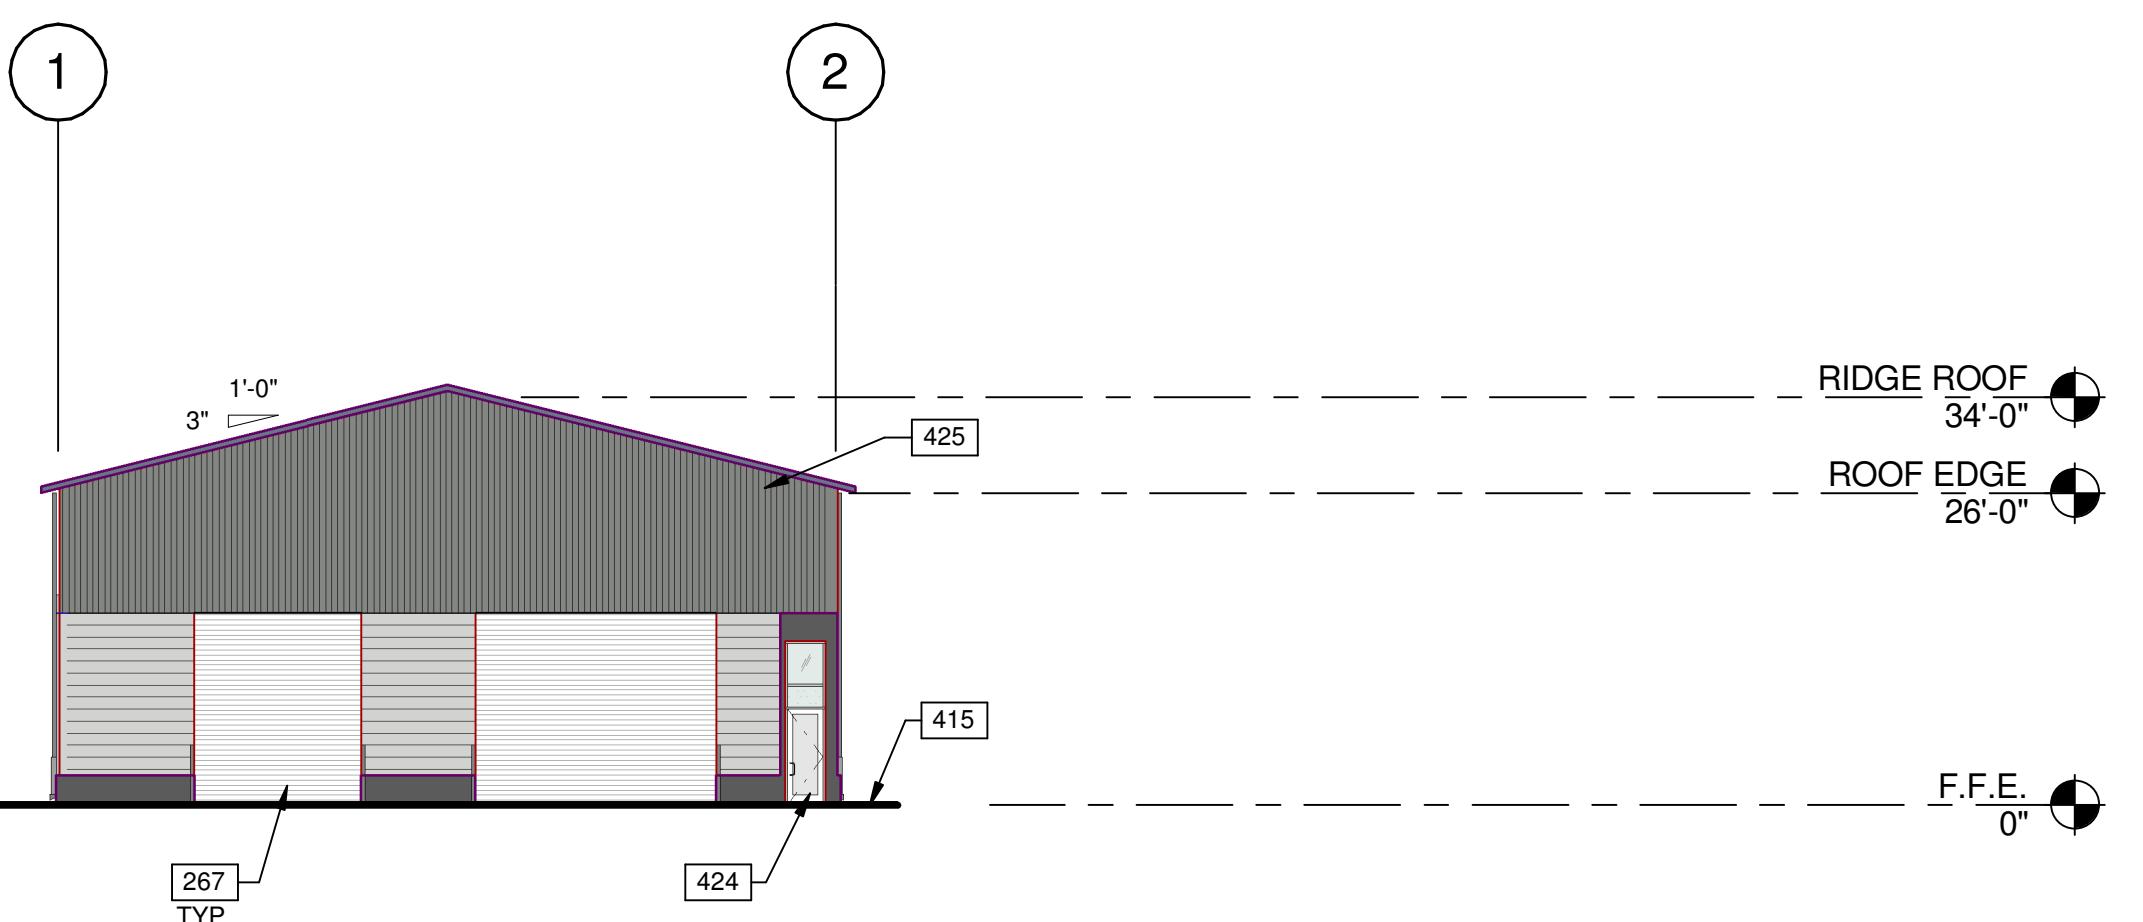
## LEGEND

## MATERIALS:



PRE-ENGINEERED METAL STRUCTURE

## COLORS:

PROVIDE 6'-0" WIDE PAINT COLOR MOCK-UP FULL HEIGHT OF BUILDING FOR OWNER/ARCHITECT REVIEW.



BASE COLOR: SHERWIN WILLIAMS SW 7674 - PEPPERCORN



SECONDARY COLOR: SHERWIN WILLIAMS SW 7067 - CITYSCAPE




SECONDARY COLOR: SHERWIN WILLIAMS SW 7064 - PASSIVE

## GLASS:



VISION GLASS

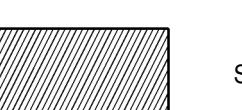

SPANDEL GLASS



TEMPERED GLASS

ALL GLASS USED ON THE ENVELOPE OF THE BUILDING TO BE:

20 ULTRACLEAR LOW IRON FLOAT GLASS

23 GUARDING CRYSTALBLUE FLOAT GLASS (1" INSULATED ON CLEAR/SPANDEL WHERE INDICATED)

SUNGUARD SPANDEL HT - WARM GRAY

GLASS WIND LOAD RESISTANCE CALCULATIONS ARE UNDER SEPARATE PERMIT

MULLION FINISH:  
KAWNEER CLEAR NO. 14 AND NO. 17 (OR COMPARABLE)

## NOTES

- 267 ROLL UP DOOR (GRADE LEVEL), SEE ELEVATIONS.  
 409 DRAIN LEADER, PAINTED TO MATCH BUILDING.  
 FINISH GRADE VARIES.  
 418 3/4" V-REVEAL.  
 421 CLERESTORY WINDOW.  
 424 NARROWSTILE STOREFRONT ENTRANCE.  
 425 PRE-ENGINEERED METAL STRUCTURE.

## BUILDING 1 - EXTERIOR ELEVATIONS

REMARKS

DATE 04/03/2019 PLANNING SUBMITTAL

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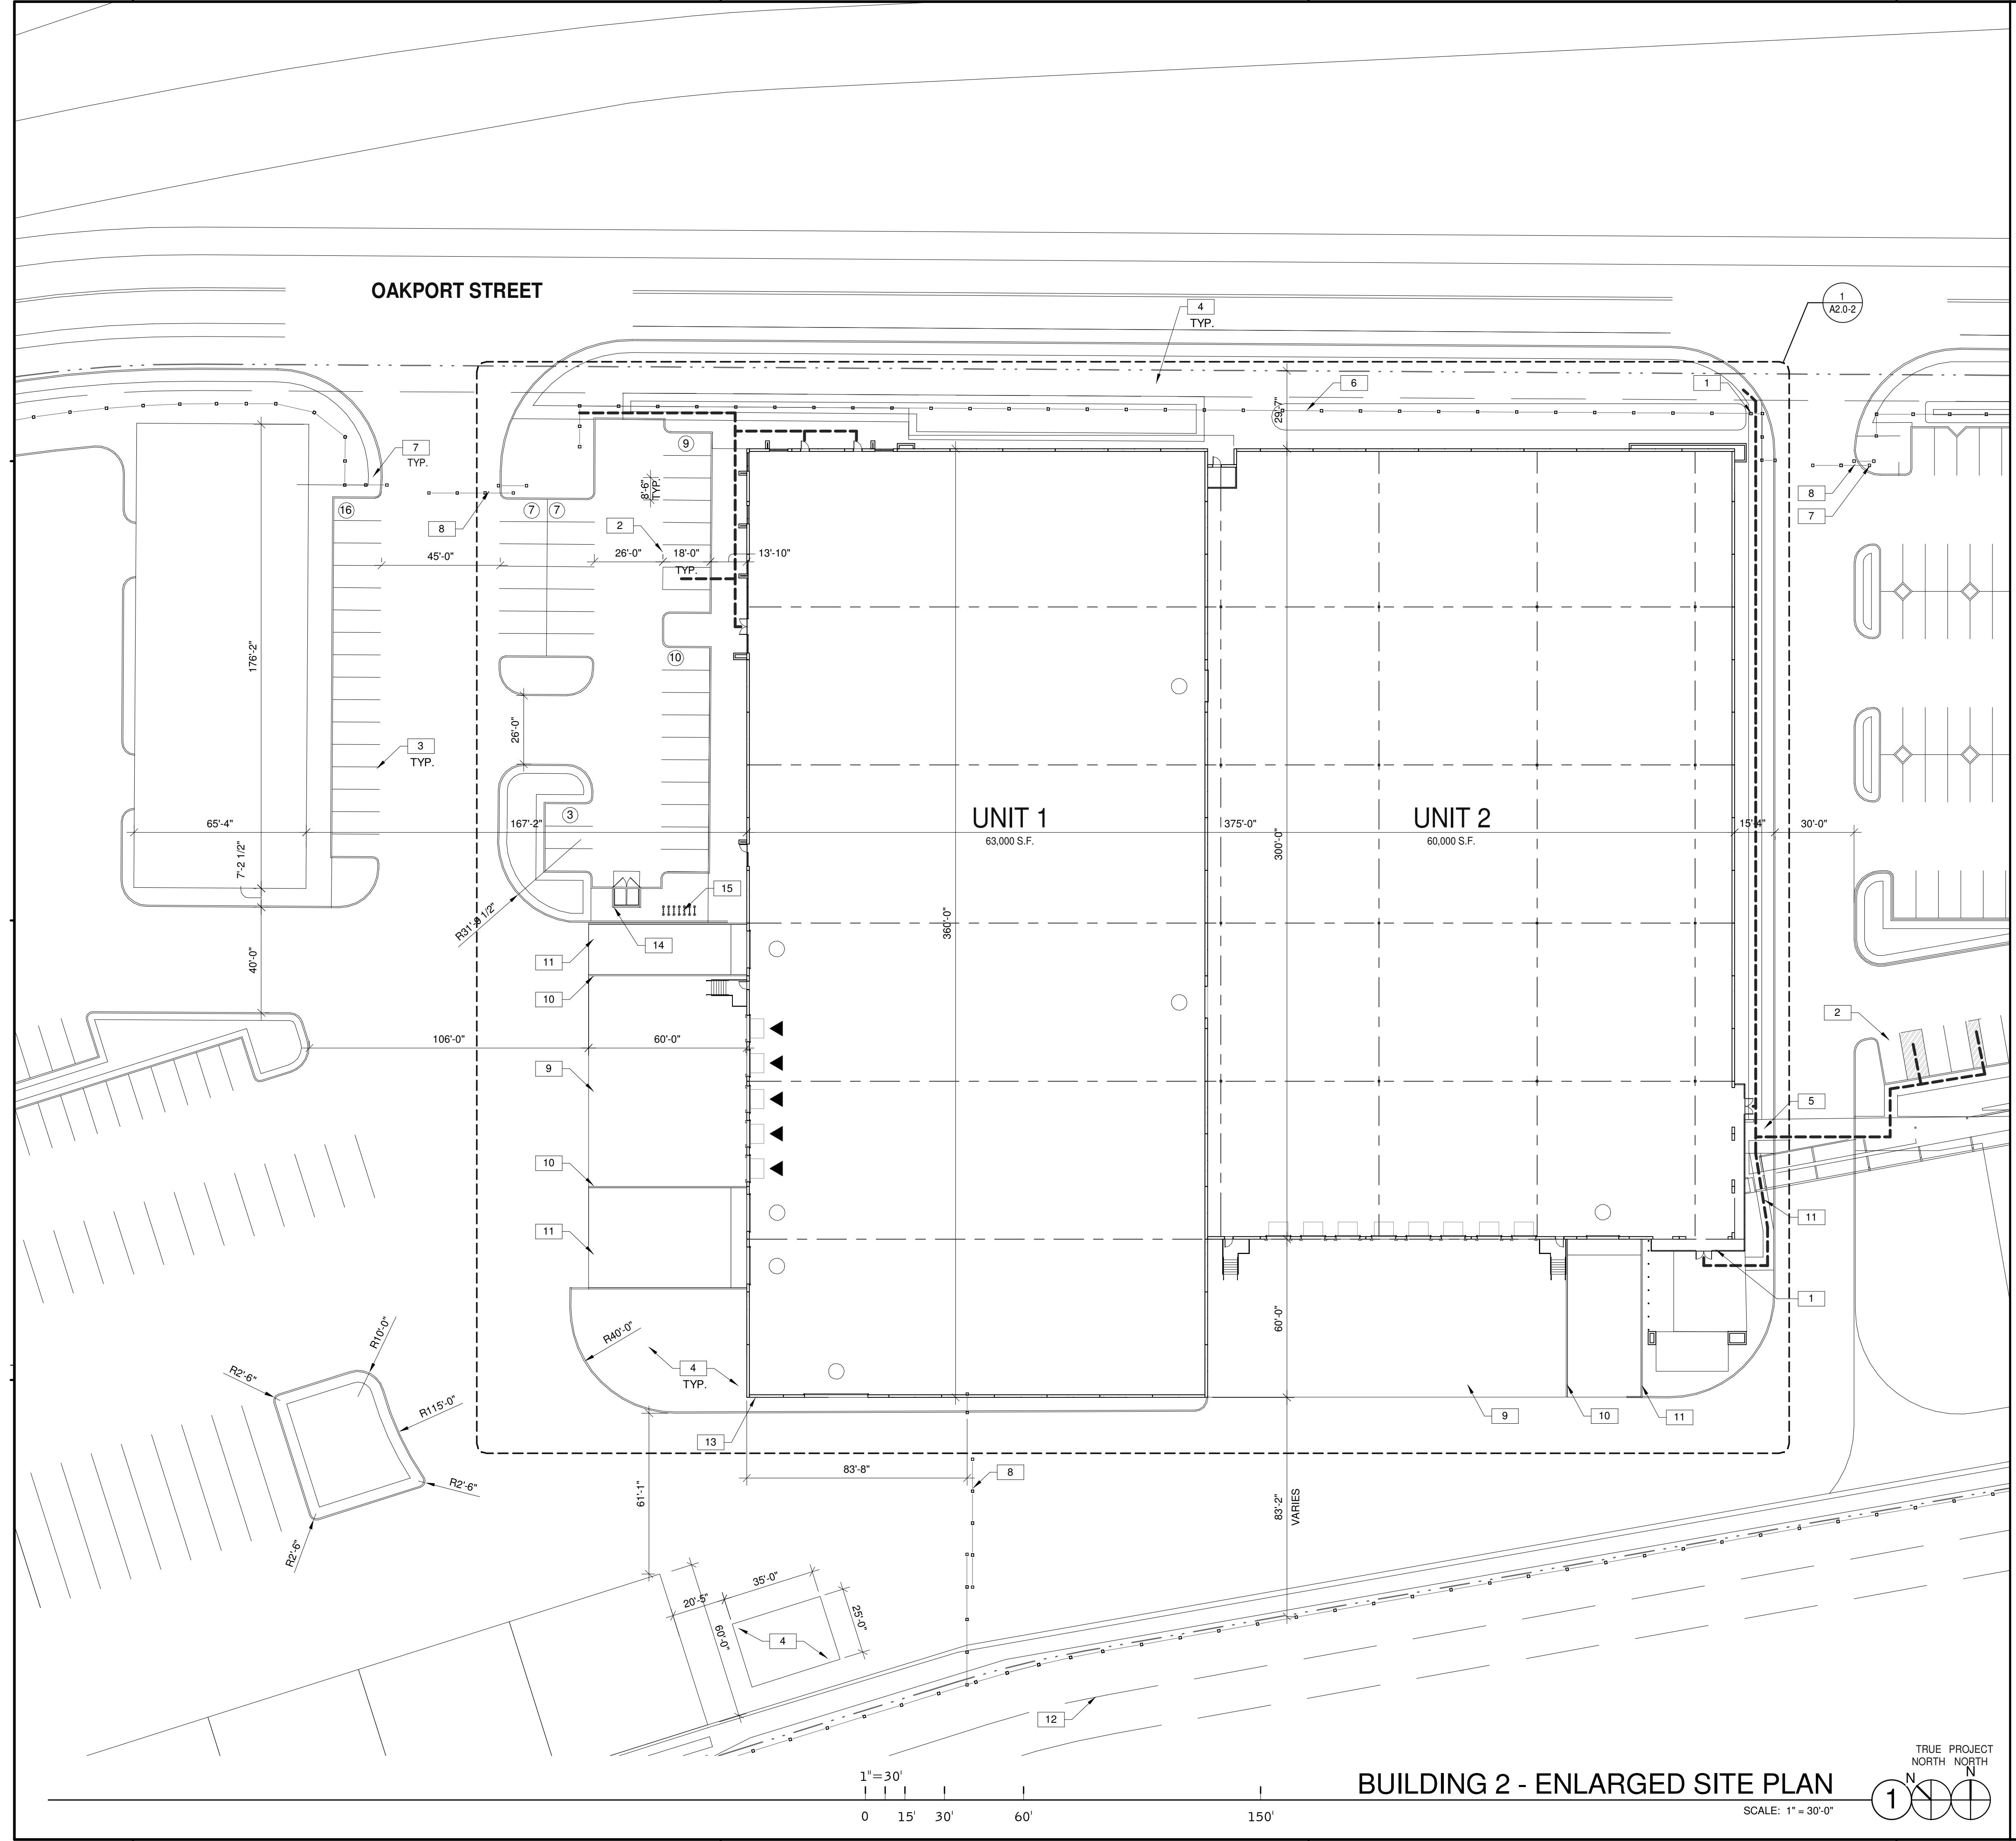
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168

169

170

171



## NOTES


SEE SHEET A0.2 FOR GENERAL NOTES

1. ACCESSIBLE ENTRY SIGNAGE.
2. ACCESSIBLE PARKING STALL WITH SIGNAGE.
3. PAINTED PARKING STRIPING PER CITY STANDARDS. 2'-0" PARKING OVERHANG.
4. LANDSCAPE AND IRRIGATION AREA.
5. ACCESSIBLE CURB RAMPS WITH TRUNCATED DOMES.
6. WROUGHT IRON FENCING. SEE DETAIL 10/A6.2.
7. VEHICLE GATE. SEE DETAIL 6/A6.2.
8. CONCRETE RAMPS.
9. GALVANIZED RAILING.
10. CONCRETE PAVEMENT.
11. EASEMENT LINE.
12. RECESSED OR SURFACE MOUNTED KNOX-BOX, INSTALL AT 5'-0" ABOVE FINISH FLOOR.
13. TRASH ENCLOSURE. SEE DETAIL 9/A6.1.
14. BIKE RACK.

## SITE LEGEND

- PROPERTY LINE, SEE CIVIL DRAWINGS
- ACCESIBLE PATH OF TRAVEL, 1:20 MAX. SLOPE, 2% MAX. CROSS SLOPE
- POLE MOUNTED LIGHT FIXTURE, SEE ELECTRICAL DRAWINGS
- FIRE LANE (HATCHED)
- PARKING STALL COUNT TOTAL
- DOCK HIGH TRUCK DOOR
- GRADE LEVEL TRUCK DOOR
- FIRE HYDRANT (VERIFY LOCATION WITH CIVIL DRAWINGS)
- P.I.V. WITH TAMPER, SEE FIRE PROTECTION DRAWINGS

## KEY PLAN

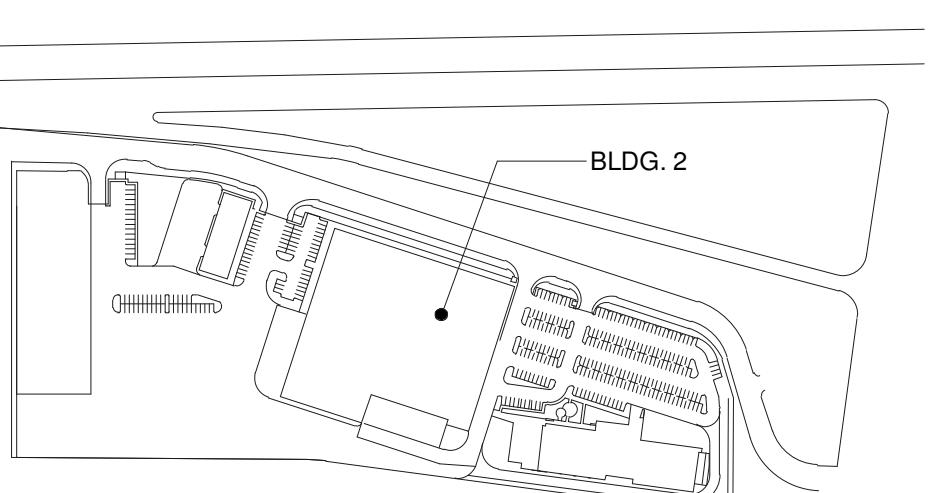

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**OAKPORT ST**  
**OAKLAND, CALIFORNIA 94621**


BUILDING 2 - ENLARGED SITE PLAN	
DATE	PLANNING SUBMITTAL
1 04/03/2019	

PA/PM:	J. BABINE
DRAWN BY:	E.S.
JOB NO.:	SNR17-0069-00

SHEET  
**A1.1-2**  
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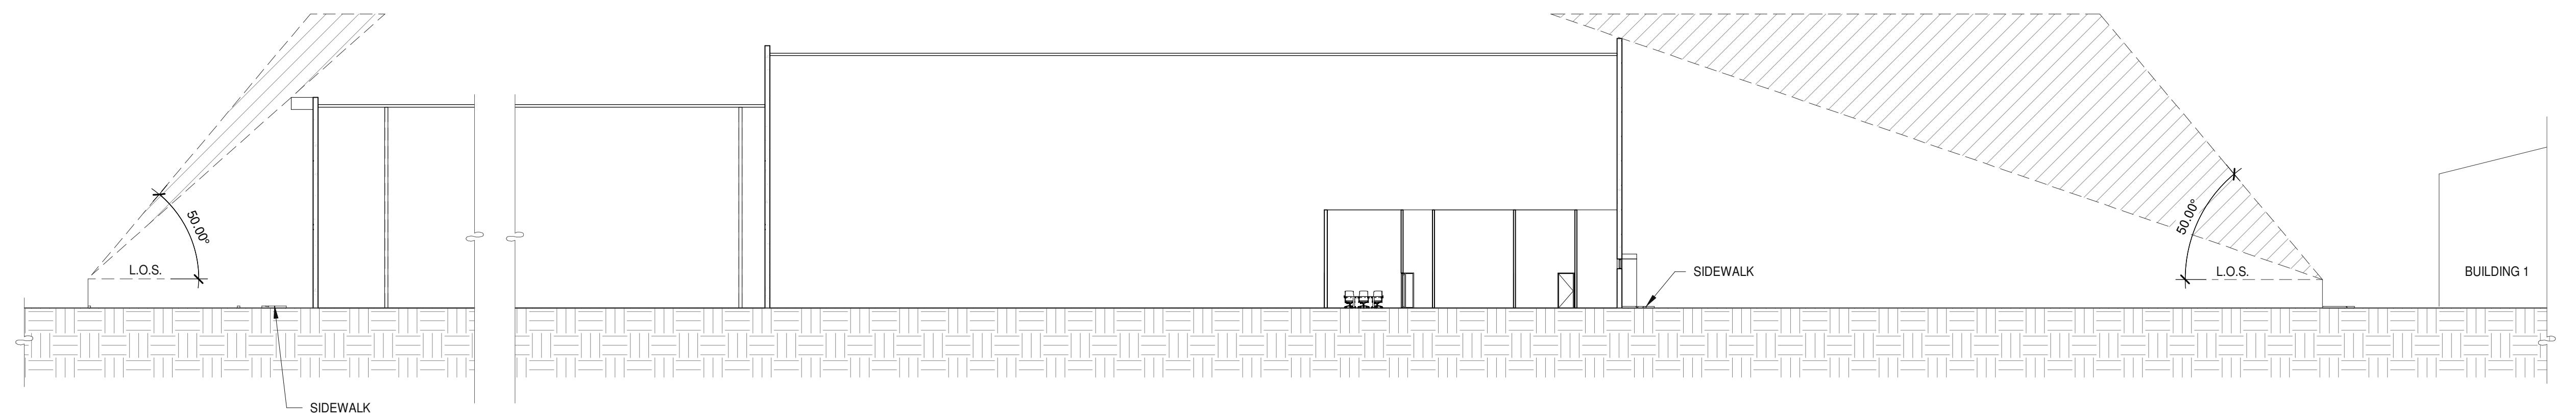
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BUILDING 2 - KEY PLAN - SITE SECTION

SCALE: 1" = 60'-0"


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BUILDING 2 - SITE SECTION

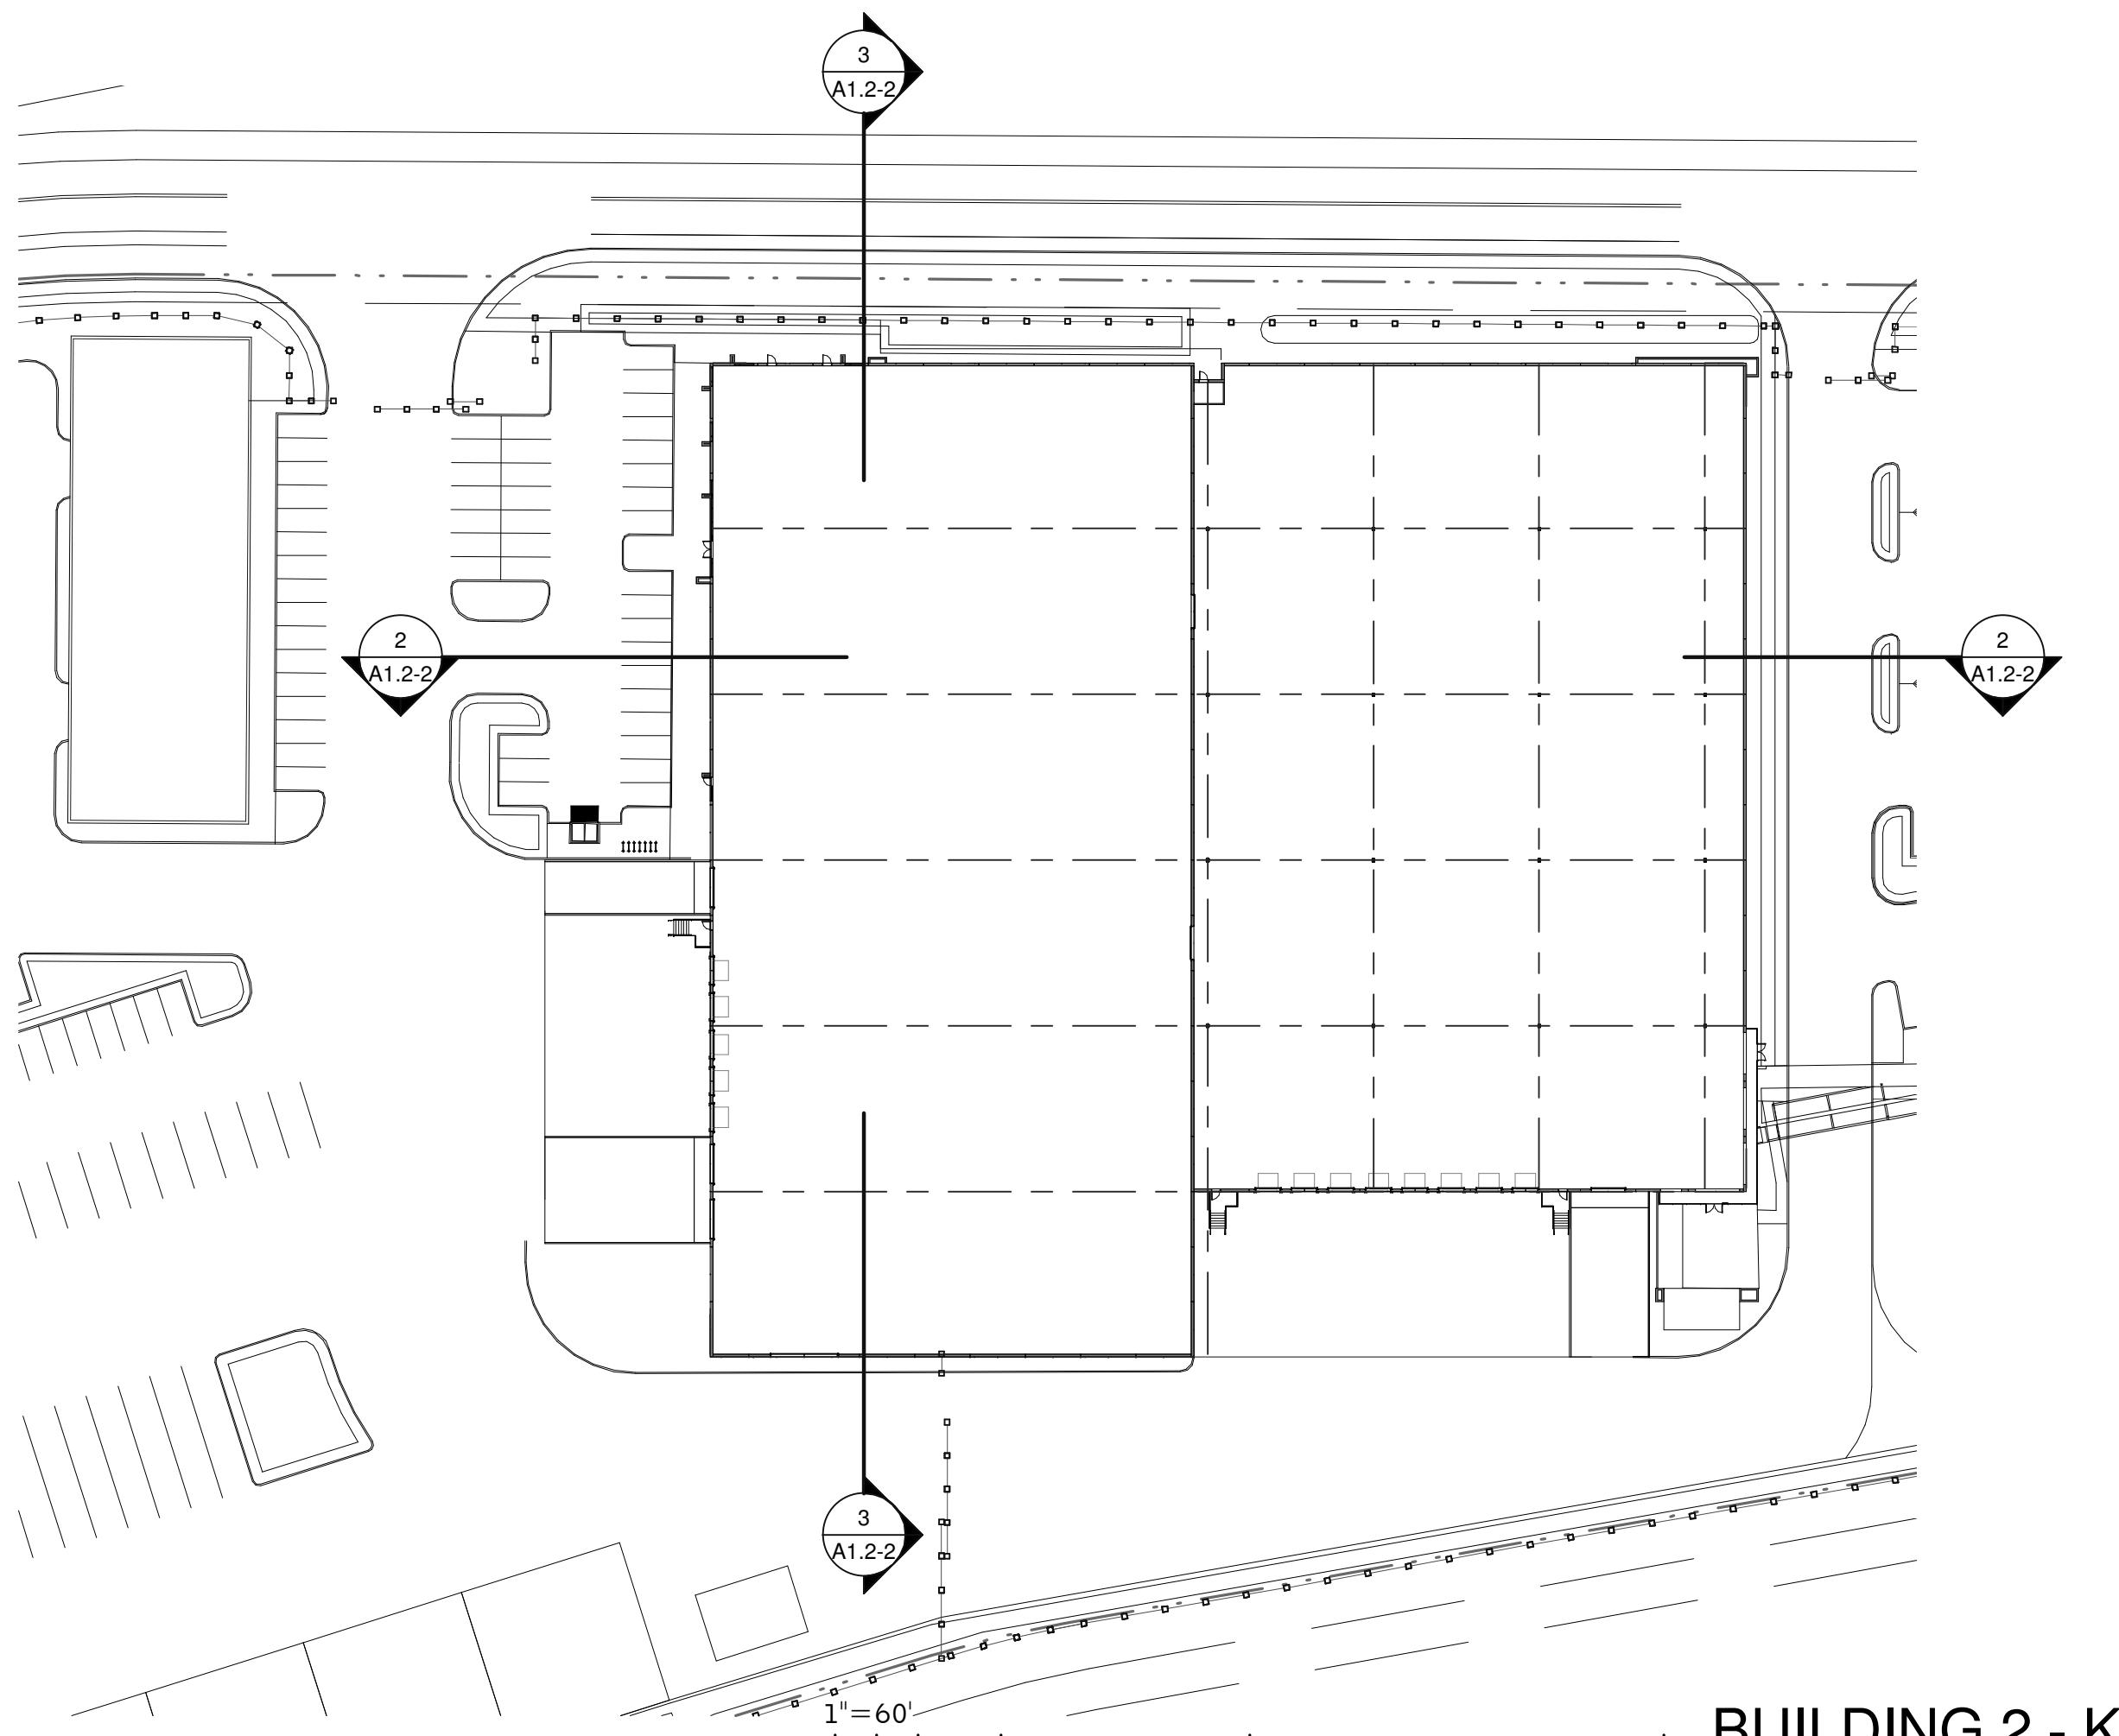SCALE: 1" = 20'-0"

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BUILDING 2 - SITE SECTION

SCALE: 1" = 20'-0"

**BUILDING 2 - SITE  
SECTIONS**

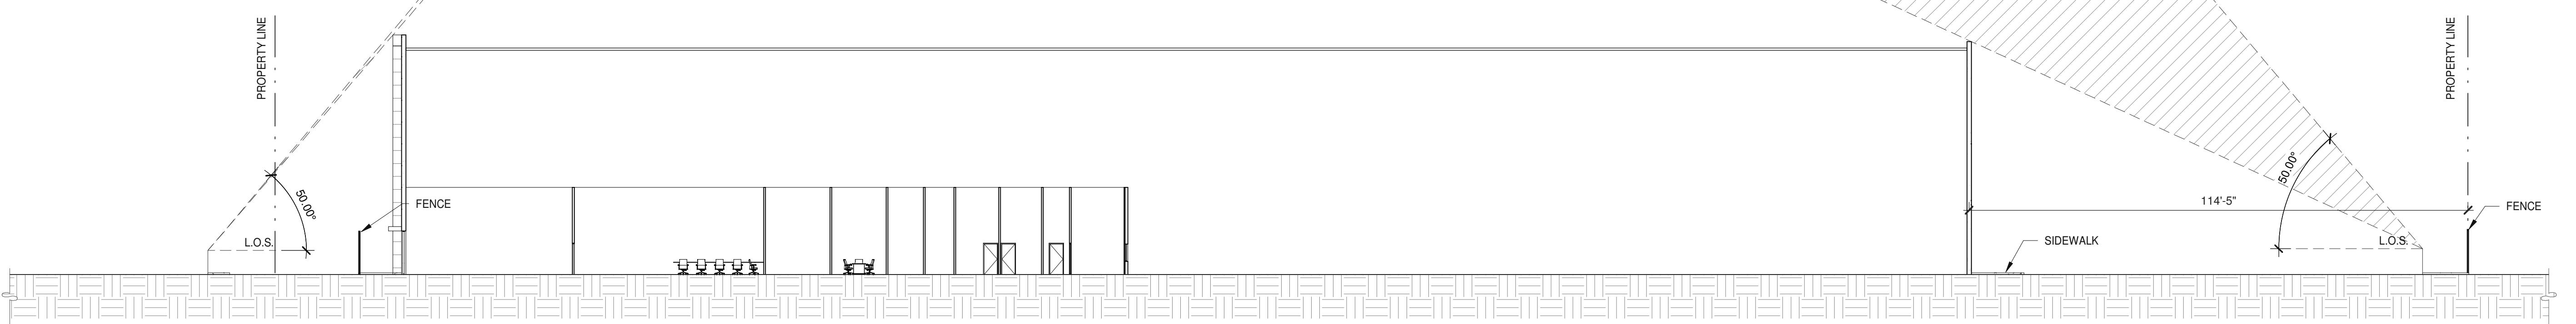DATE	REMARKS
1 04/03/2019	PLANNING SUBMITTAL

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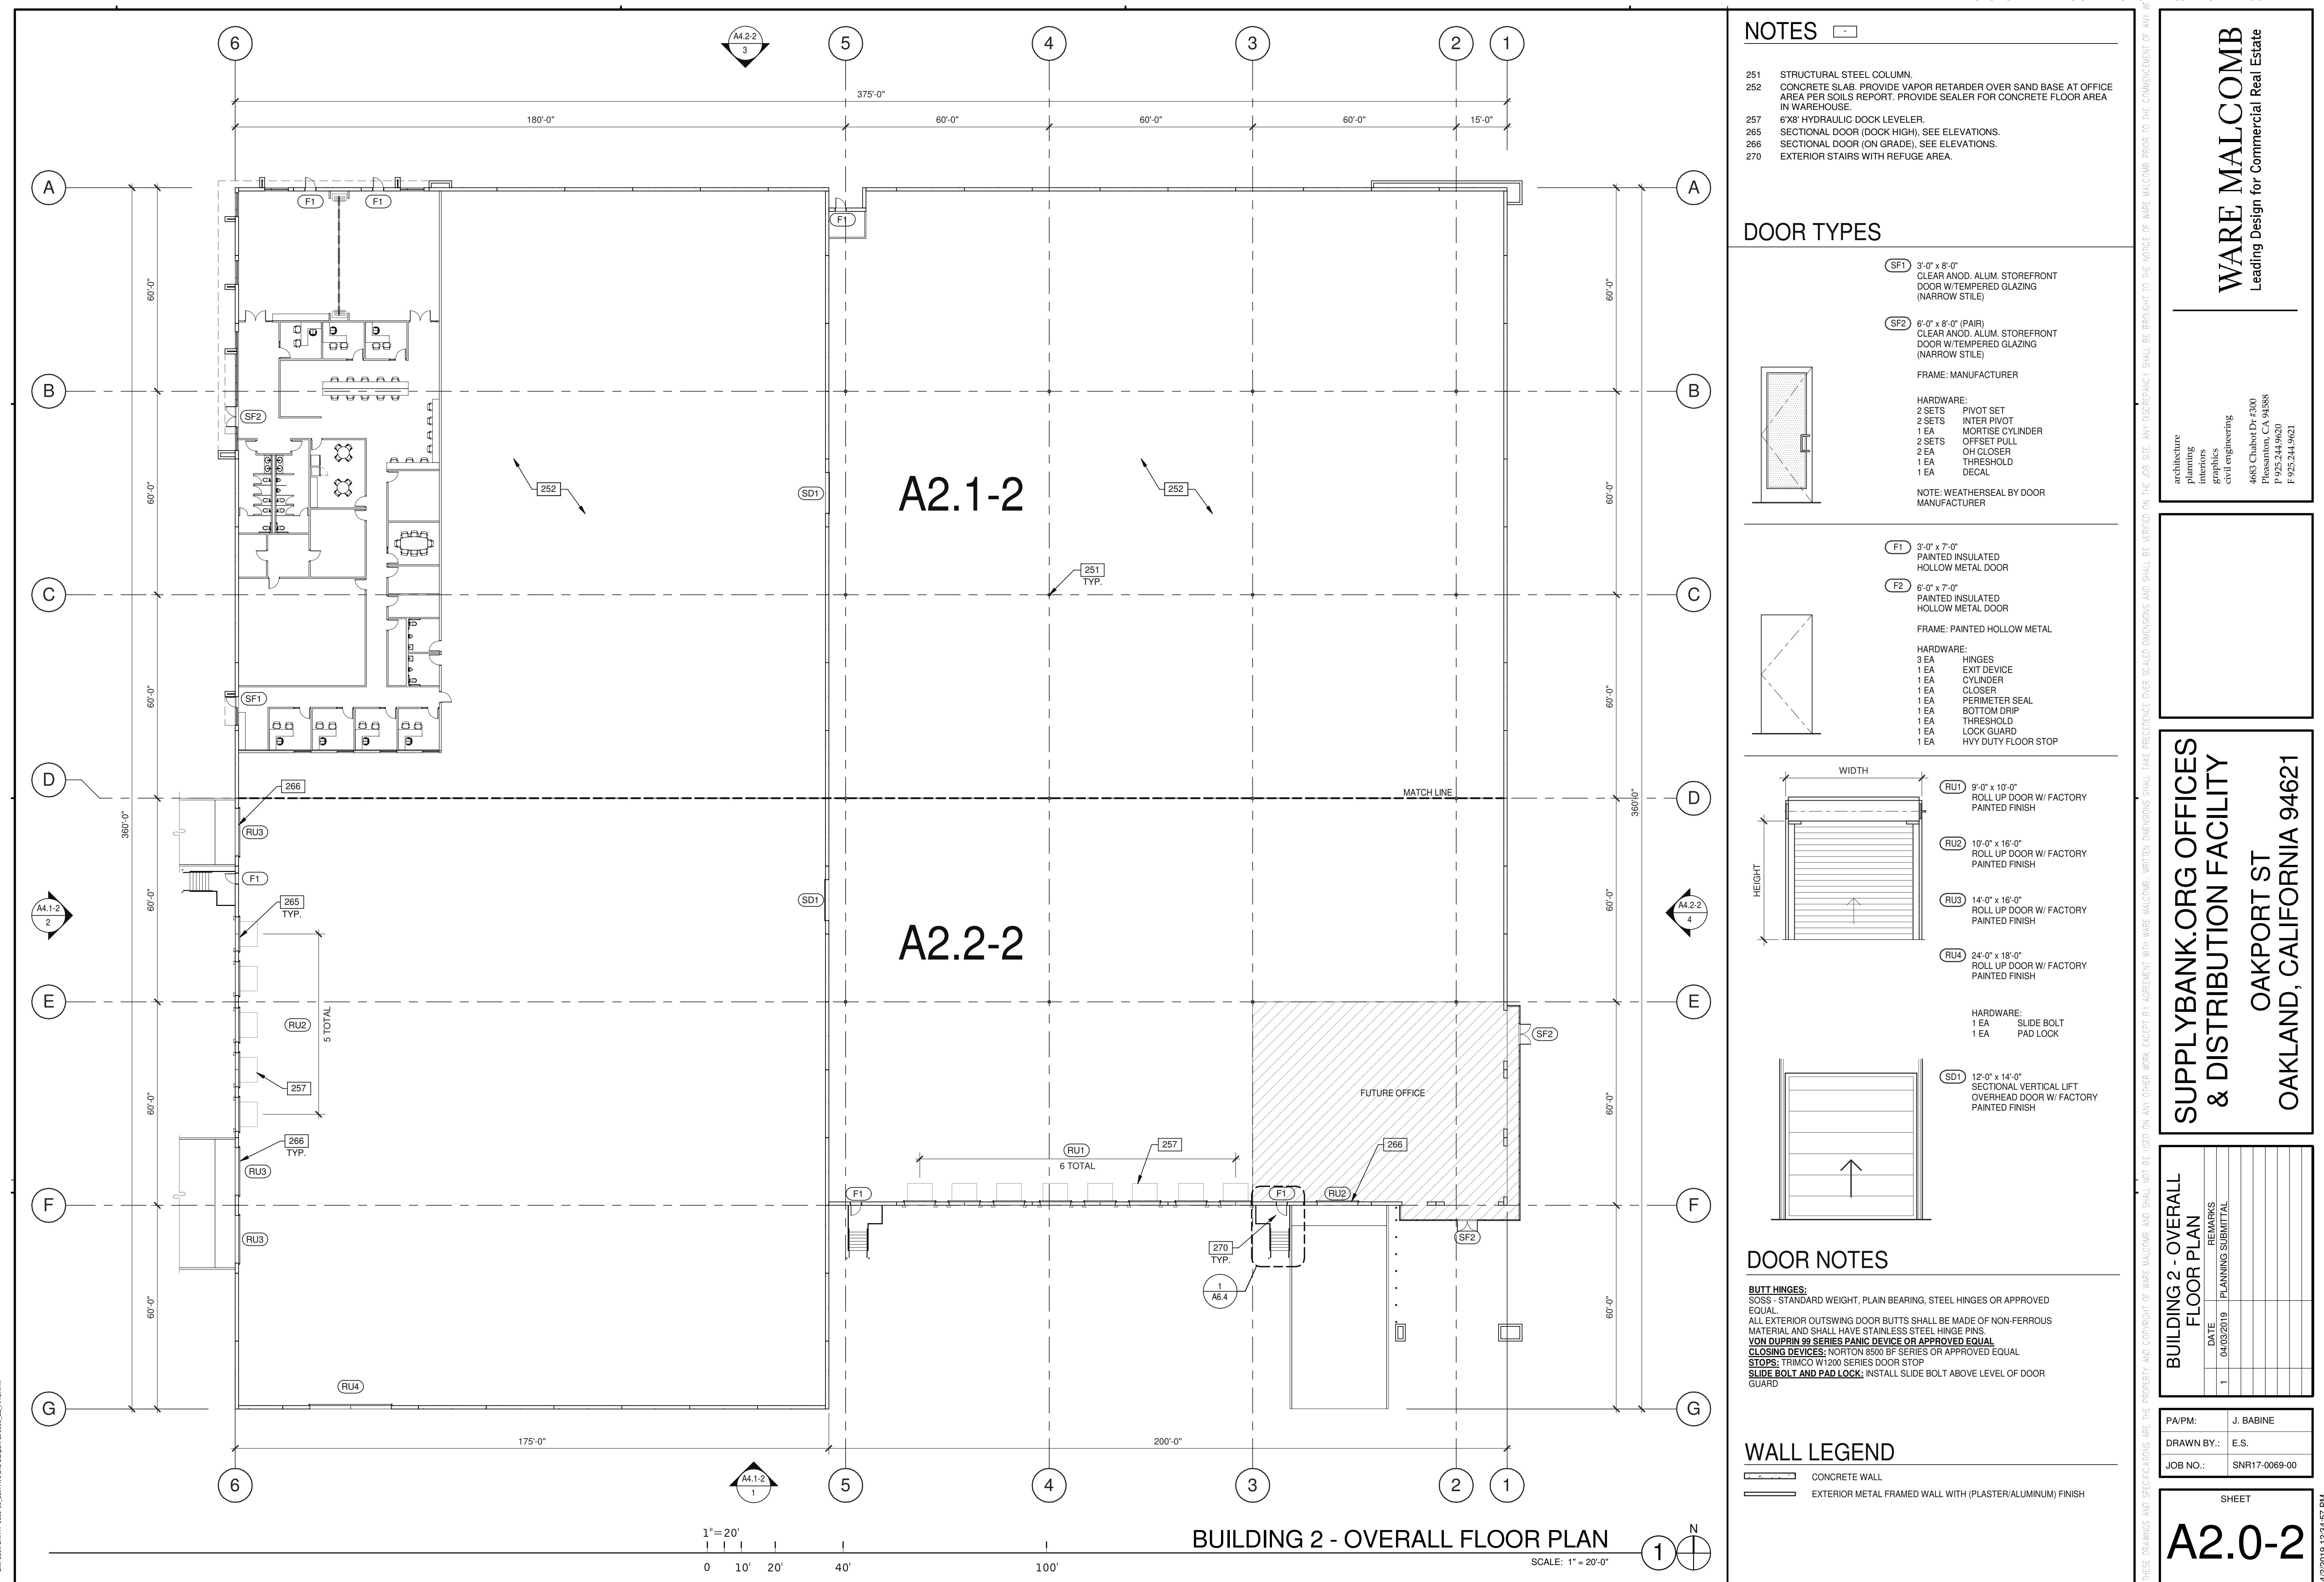
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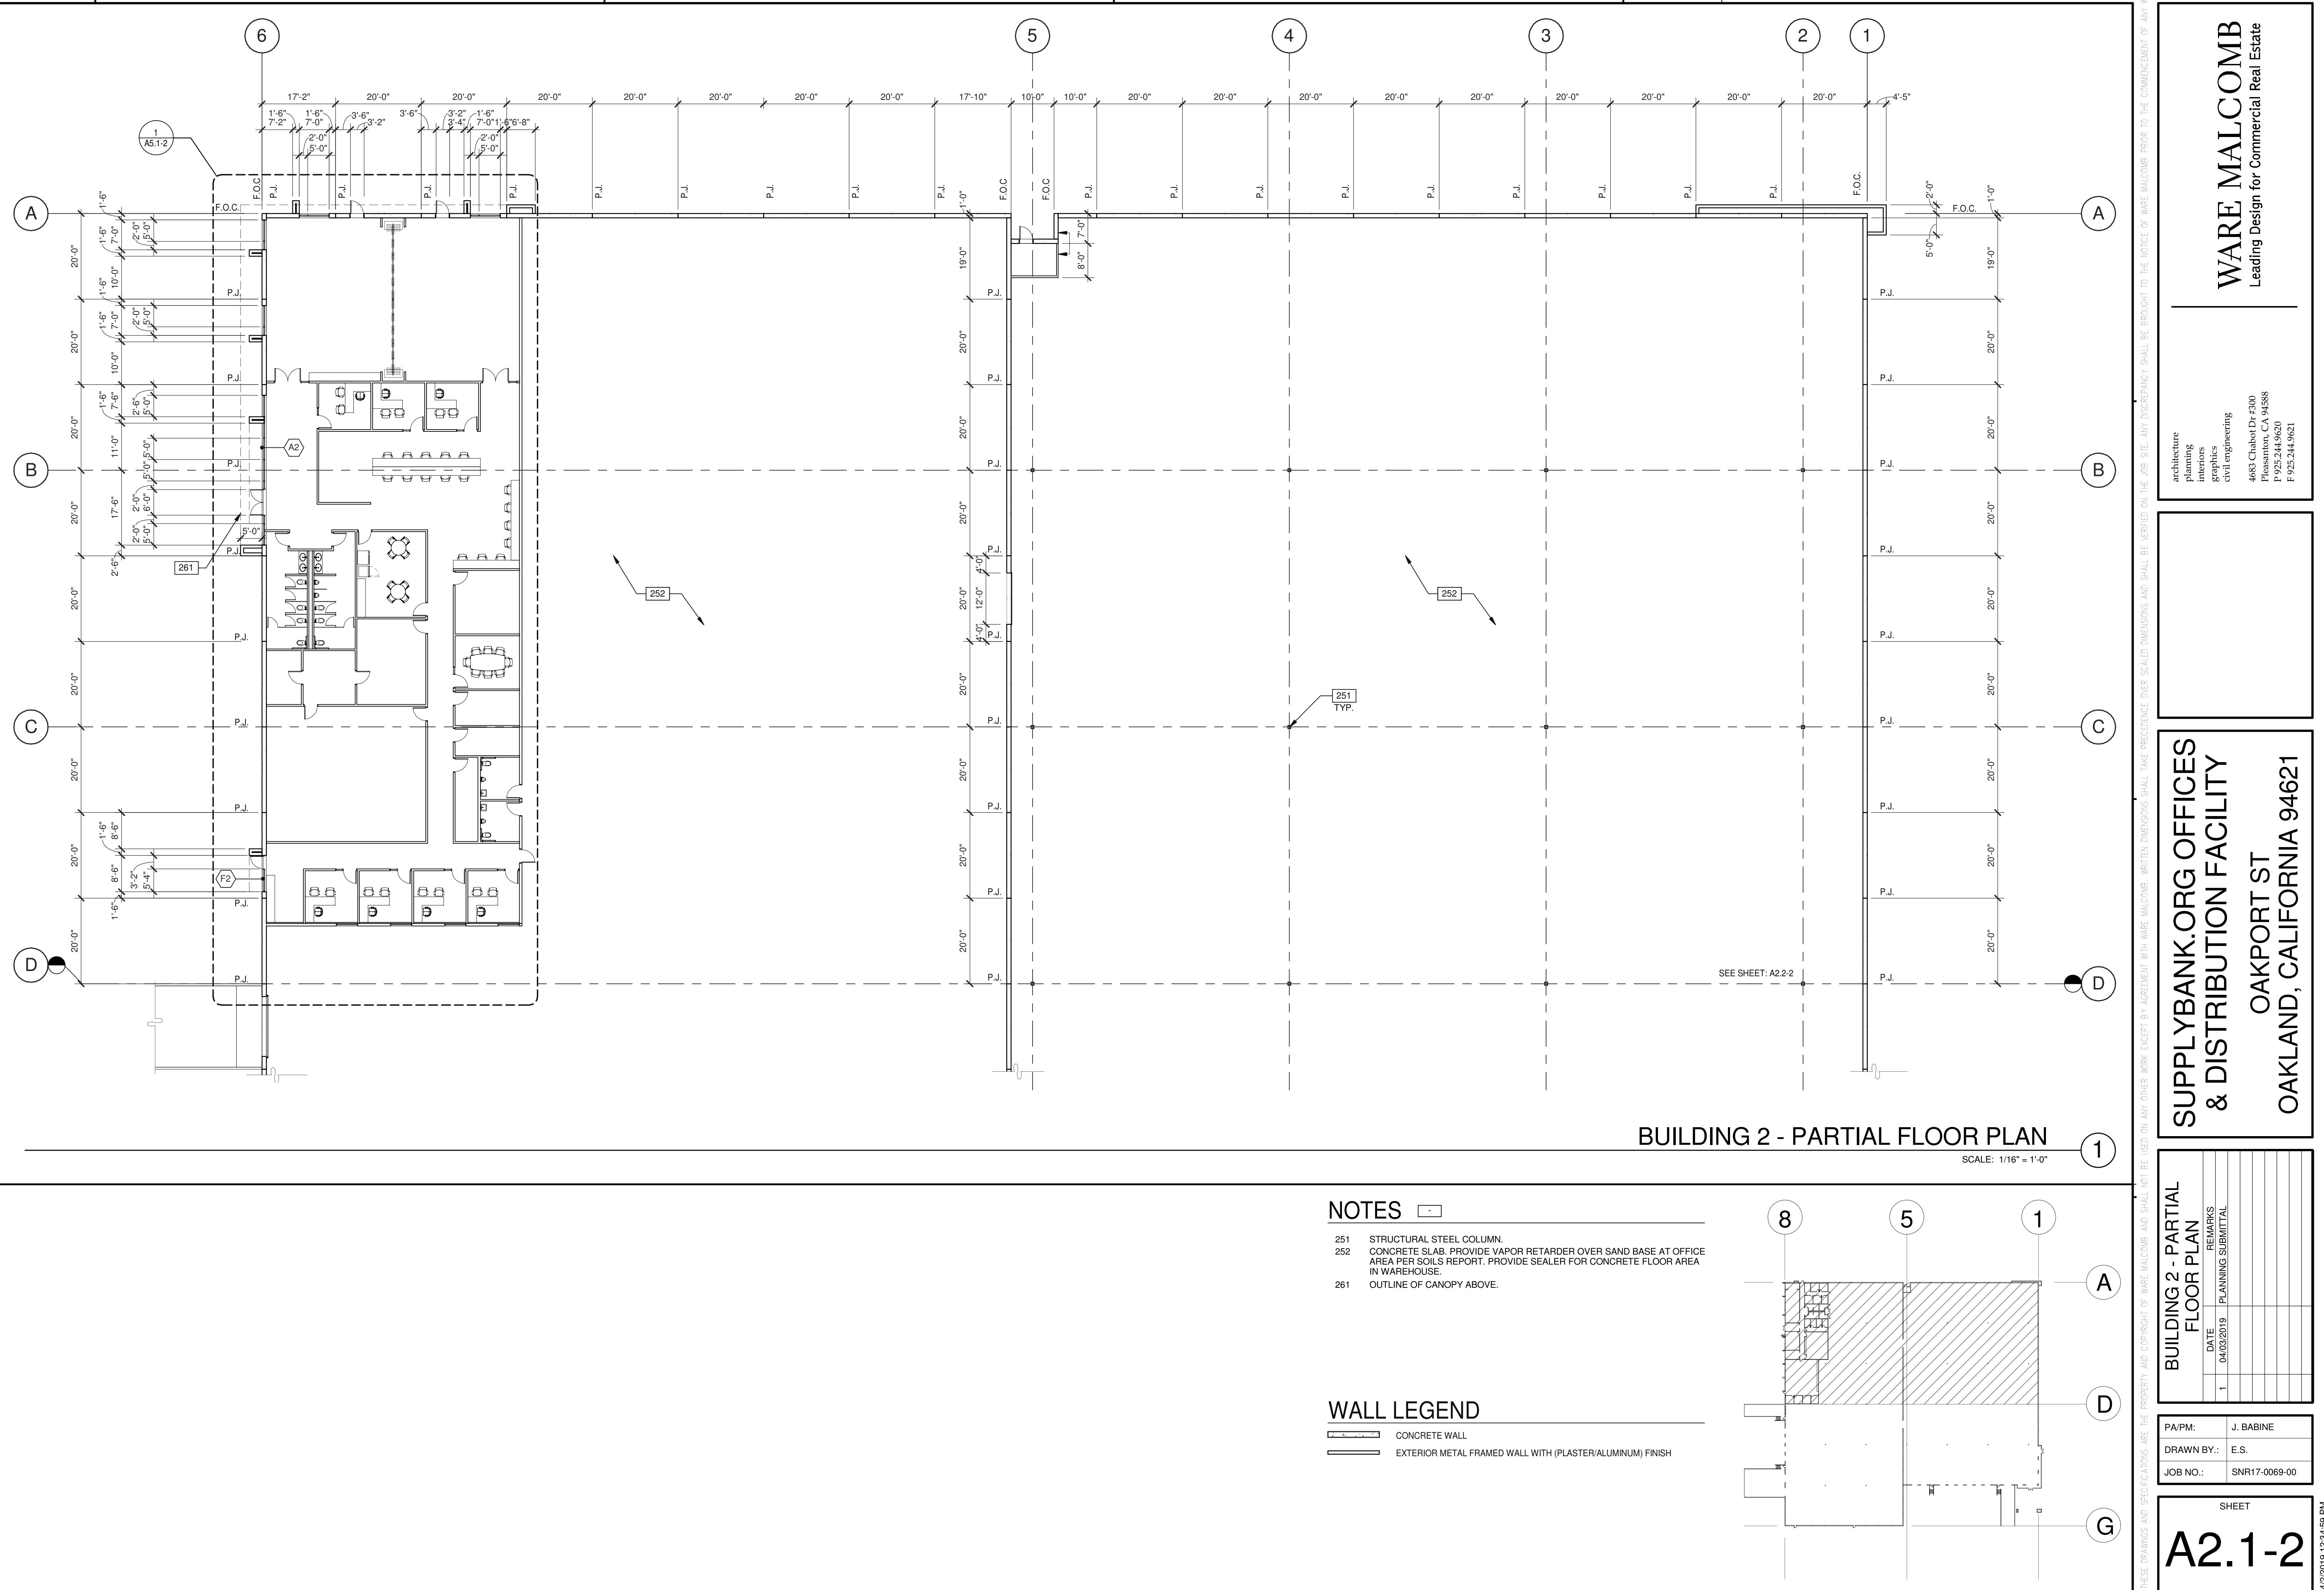
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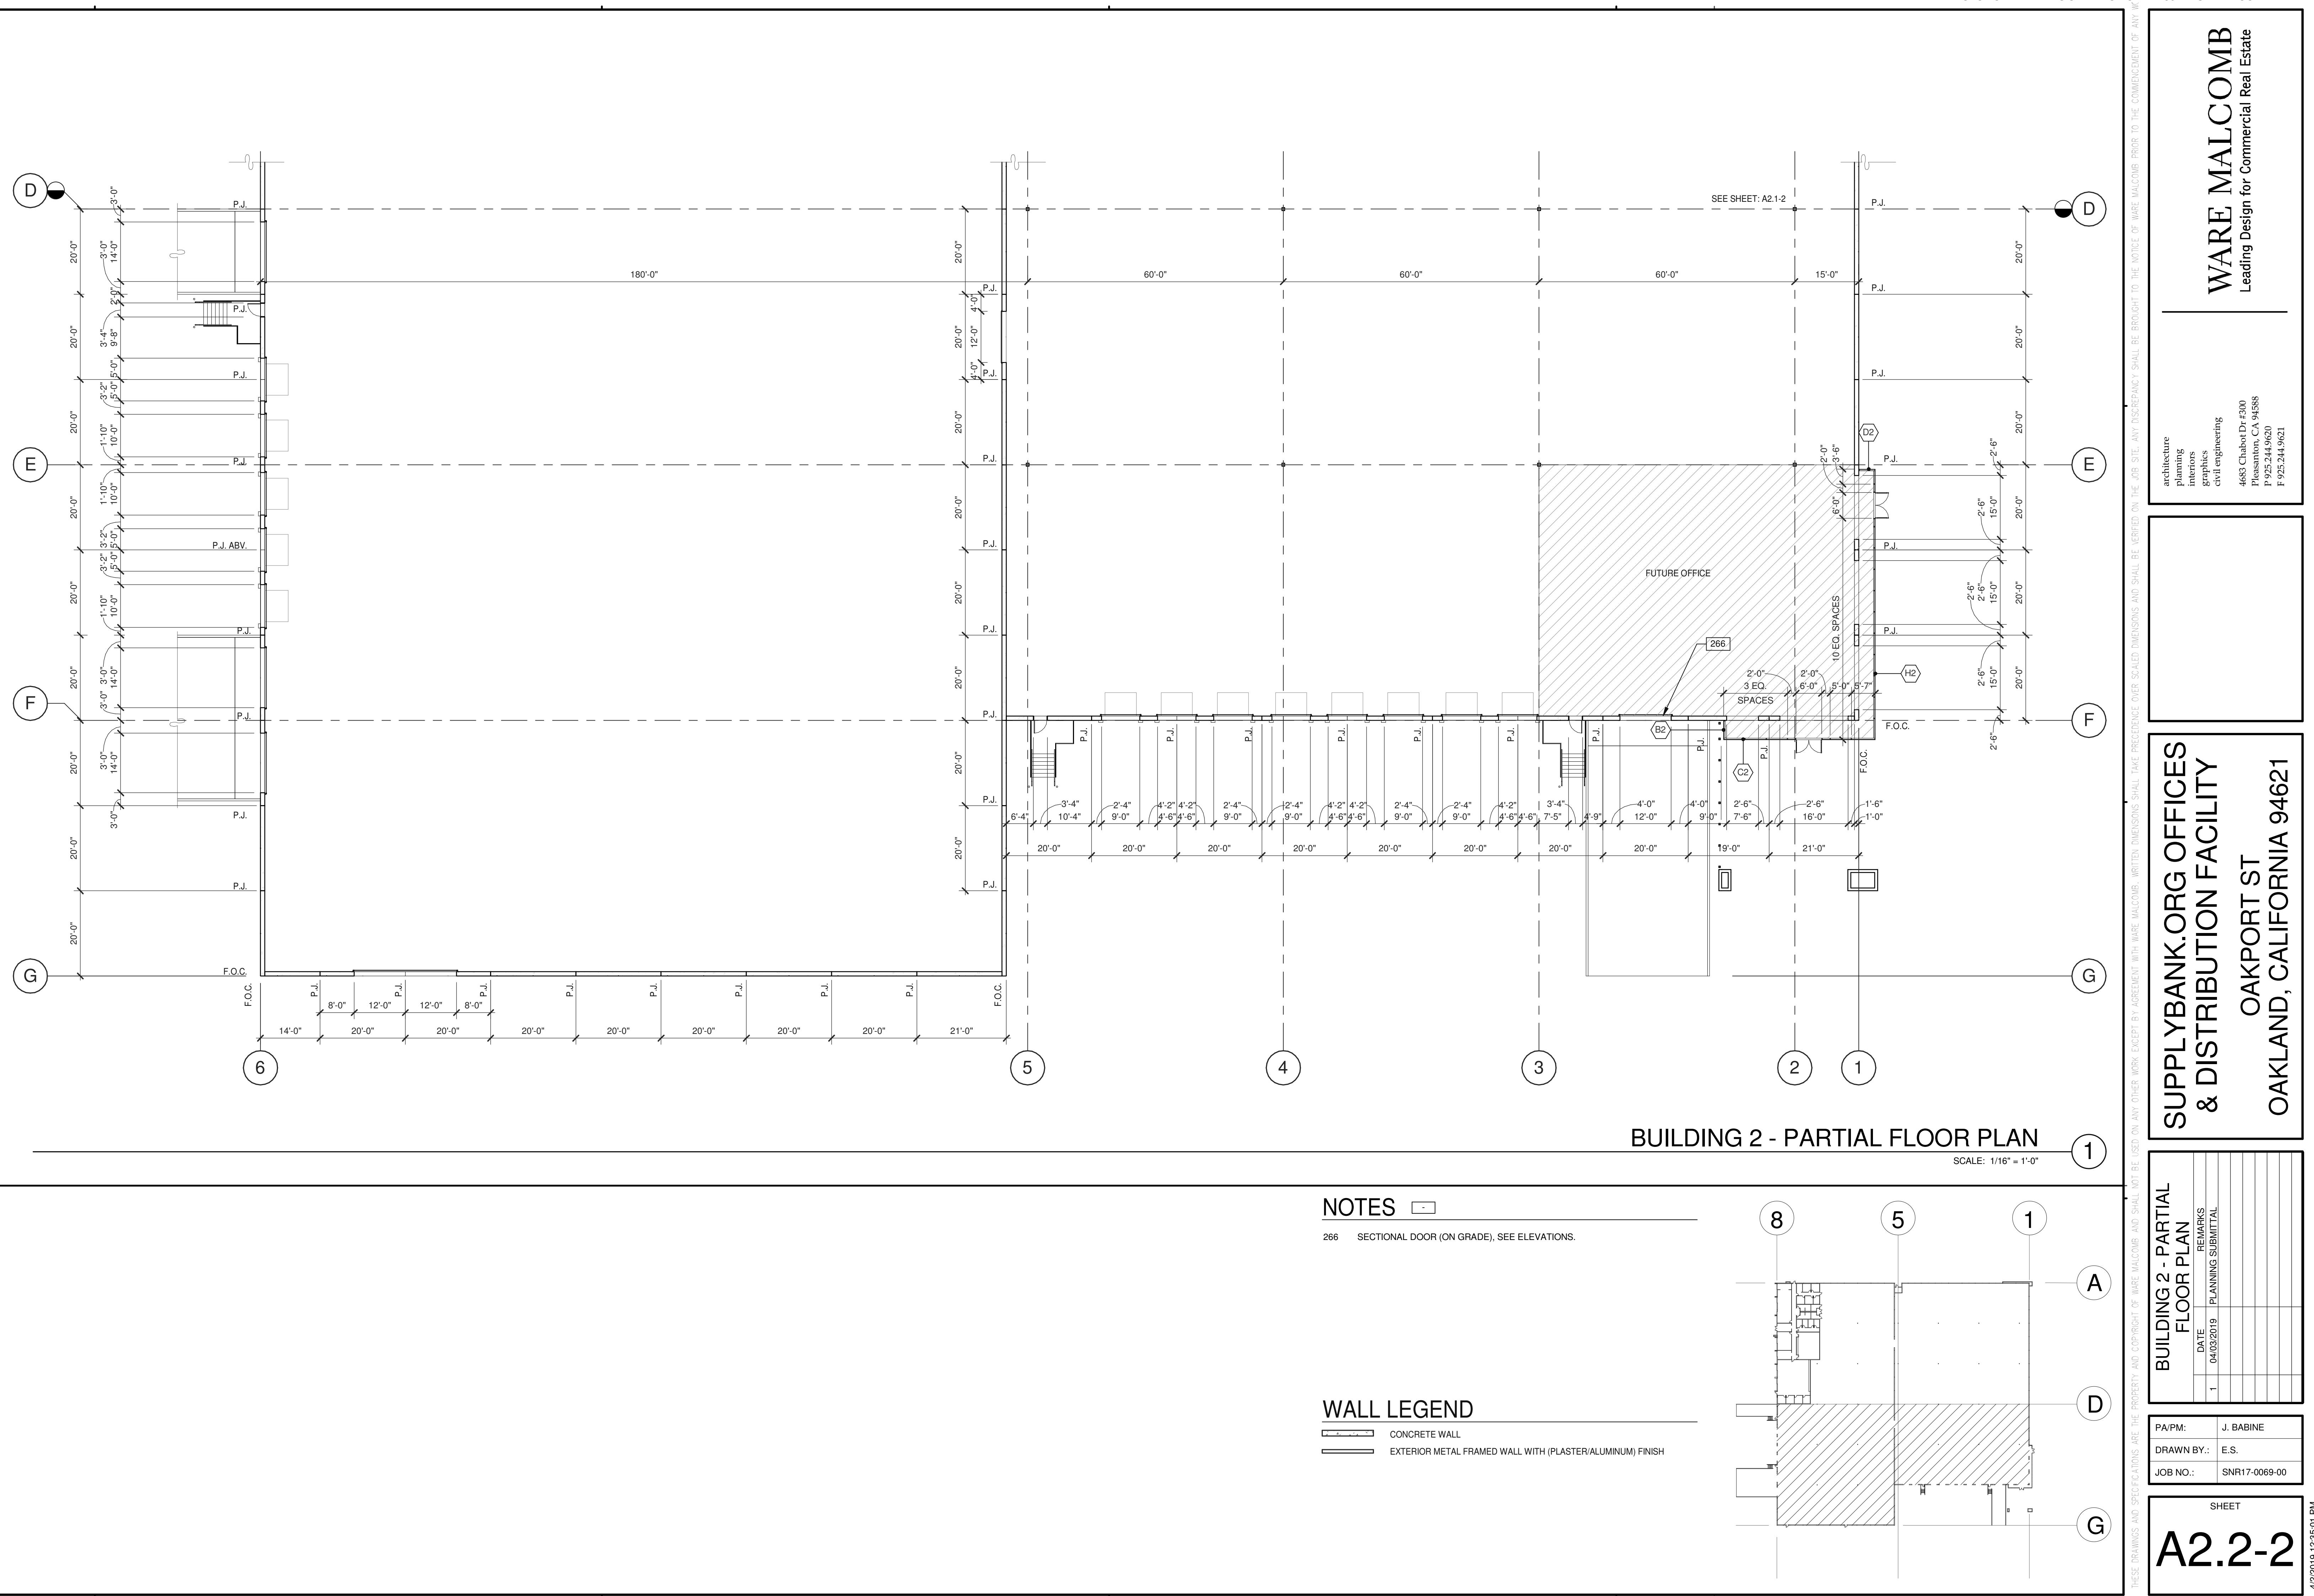
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BUILDING 2 - EXTERIOR ELEVATIONS	
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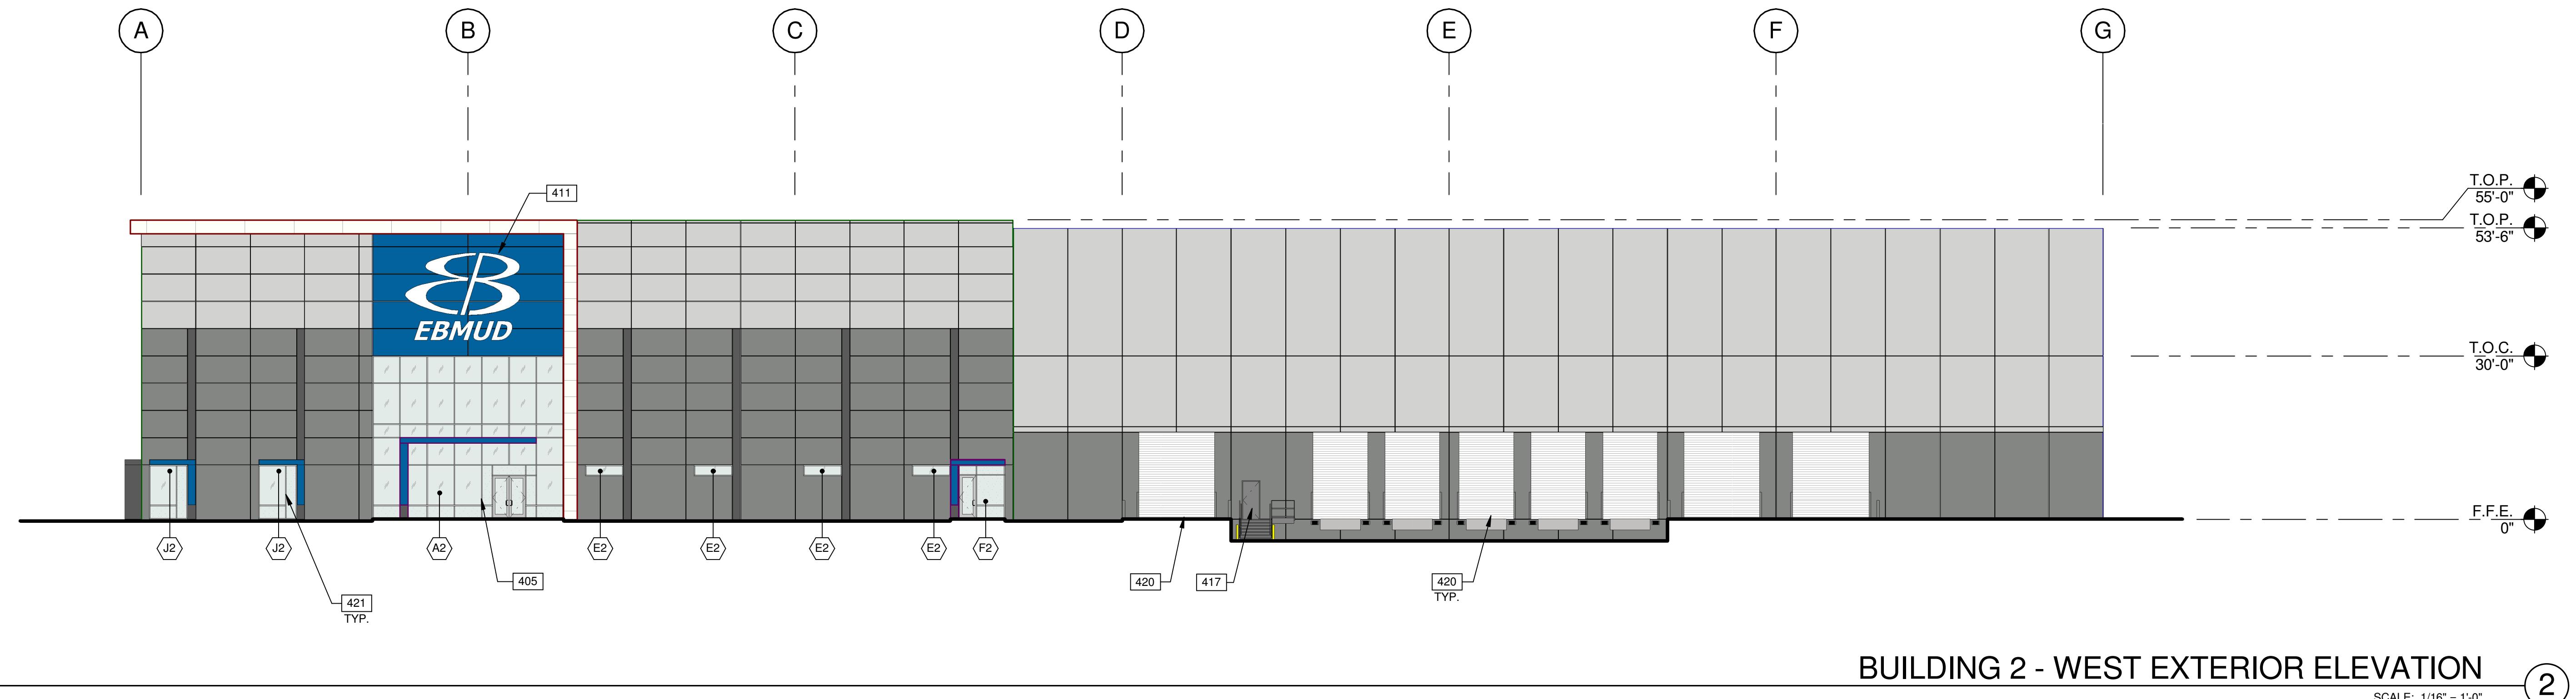
A4.1-2

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BUILDING 2 - SOUTH EXTERIOR ELEVATION

SCALE: 1/16" = 1'-0"



BUILDING 2 - WEST EXTERIOR ELEVATION

SCALE: 1/16" = 1'-0"

### LEGEND

#### MATERIALS:

- WHITE PORCELAIN TILE RAIN SCREEN SYSTEM OVER CONCRETE WALL
- EXTERIOR SMOOTH PLASTER FINISH WITH INTEGRAL COLOR OVER METAL STUD WALL
- METAL CANOPY, PAINTED

#### GLASS:


- VISION GLASS
- TEMPERED GLASS
- SPANDREL GLASS

#### COLORS:

- PROVIDE 6'-0" WIDE PAINT COLOR MOCK-UP FULL HEIGHT OF BUILDING FOR OWNER/ARCHITECT REVIEW.
- BASE COLOR: SHERWIN WILLIAMS SW 7064 - PASSIVE
- SECONDARY COLOR: SHERWIN WILLIAMS SW 7067 - CITYSCAPE
- ACCENT COLOR: SHERWIN WILLIAMS SW 7676 - PEPPERCORN
- ACCENT COLOR: SHERWIN WILLIAMS SW 6965 - HYPER BLUE
- ACCENT/SIGNAGE COLOR: SHERWIN WILLIAMS SW 6802 - JACARANDA
- ACCENT/SIGNAGE COLOR: SHERWIN WILLIAMS SW 6510 - LOYAL BLUE


### NOTES

- 401 CONCRETE WALL, PAINTED.
- 405 ALUMINUM STOREFRONT SYSTEM WITH 1" INSULATED GLASS.
- 411 SIGNAGE, UNDER SEPARATE PERMIT.
- 412 DOCK BUMPER.
- 415 FINISH GRADE VARIES.
- 417 MAN DOOR.
- 418 3/4" V-REVEAL.
- 420 ROLL UP DOOR (GRADE LEVEL).
- 421 CLERESTORY WINDOW.

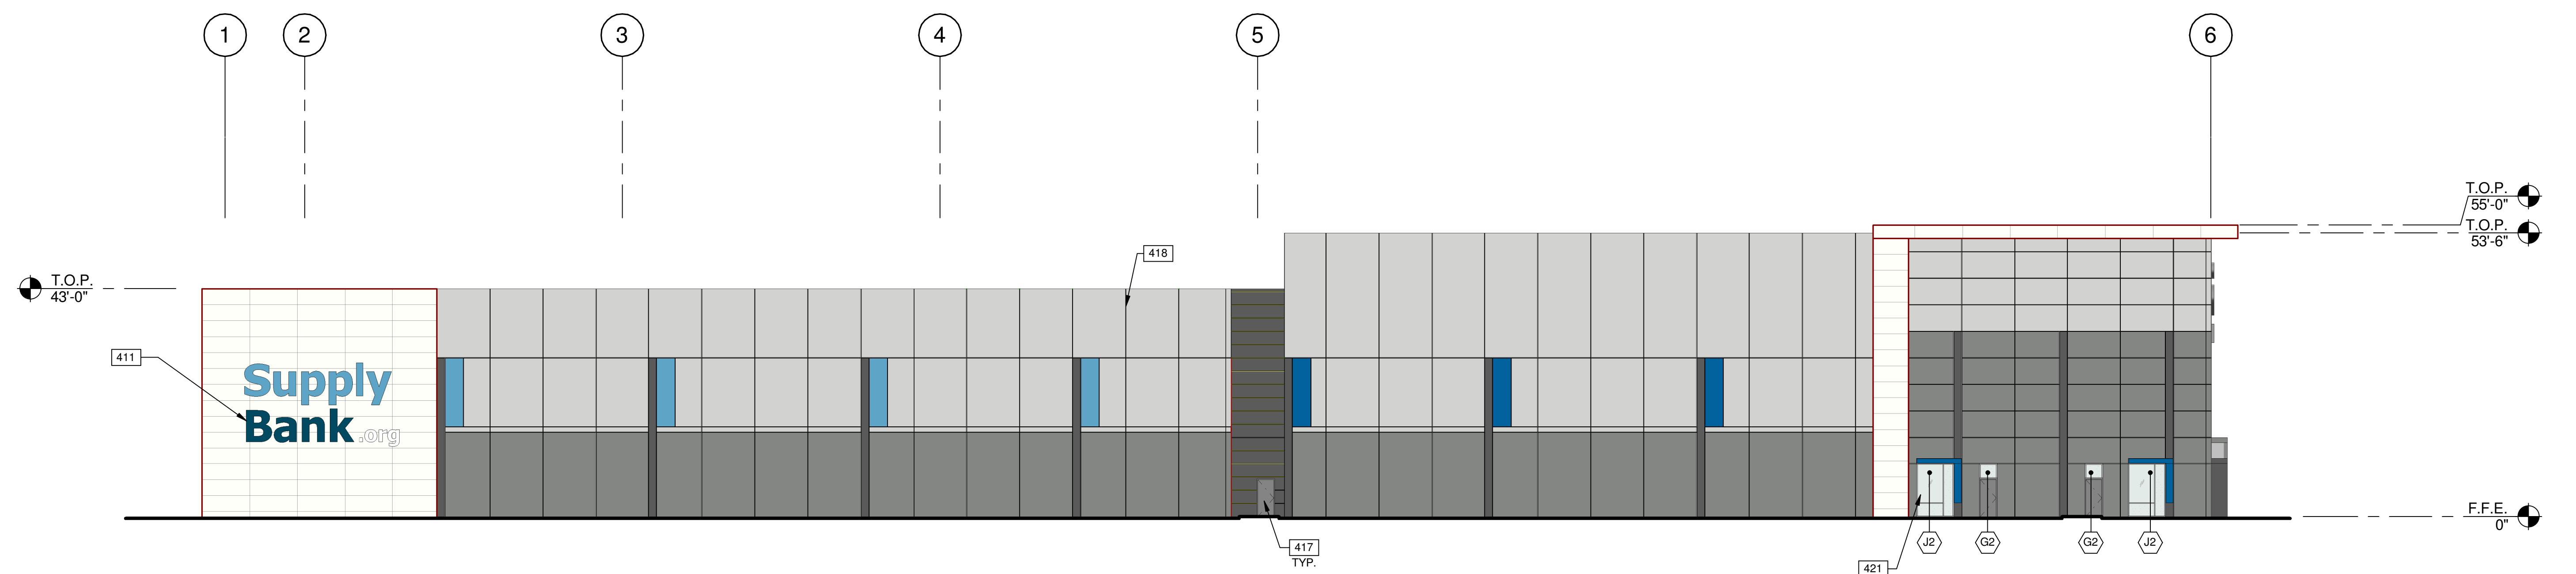

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SCALE: 1/16" = 1'-0"

#### NOTES

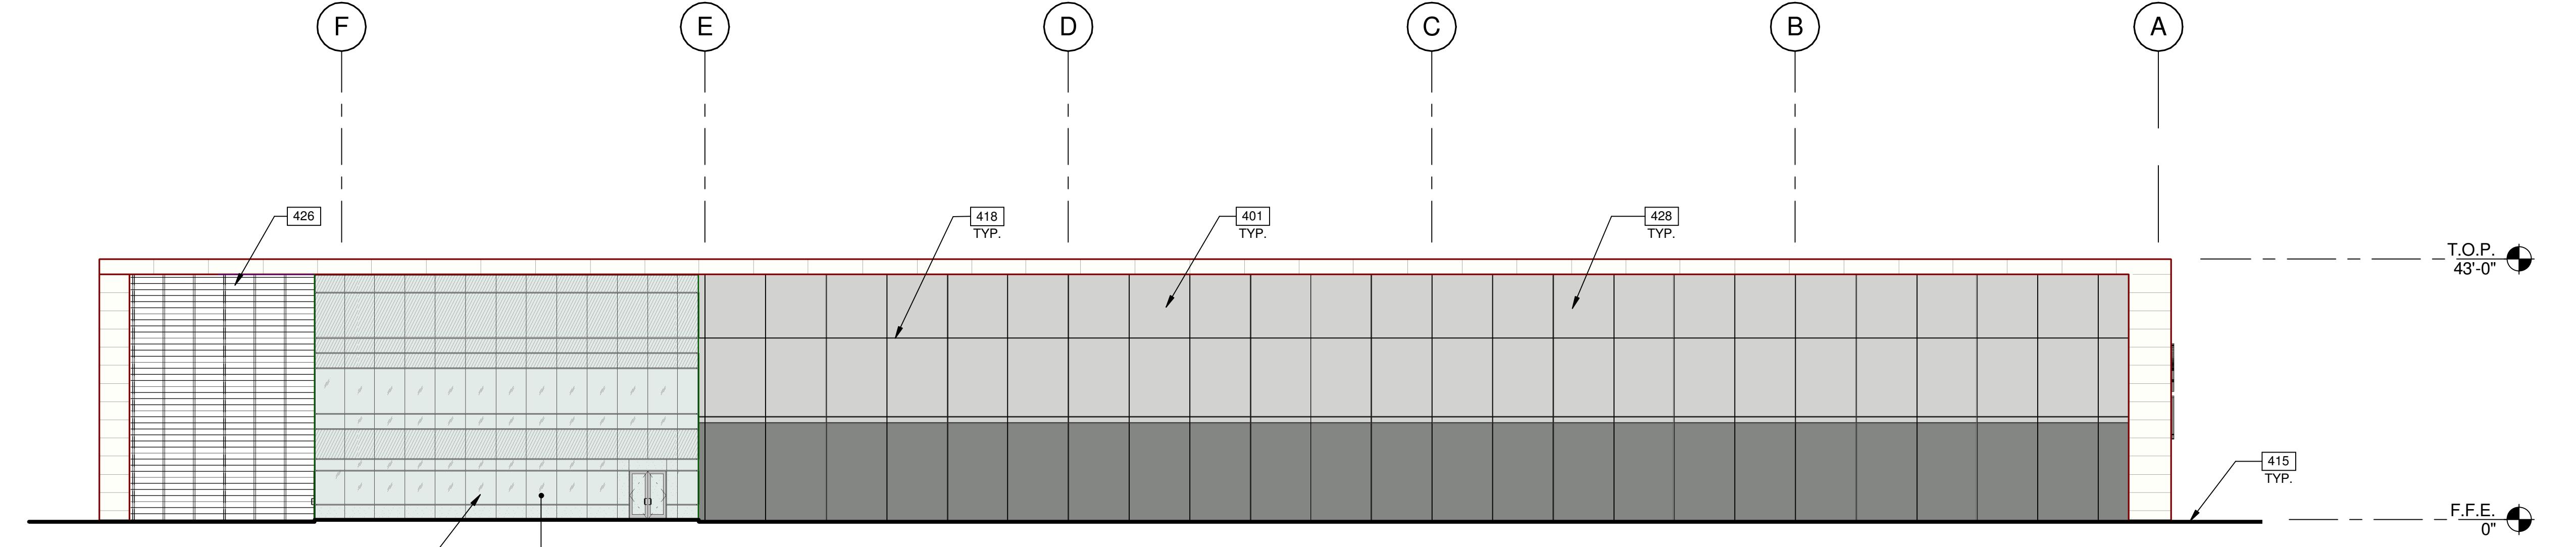- 401 CONCRETE WALL, PAINTED.
- 405 ALUMINUM STOREFRONT SYSTEM WITH 1" INSULATED GLASS.
- 411 SIGNAGE, UNDER SEPARATE PERMIT.
- 415 FINISH GRADE VARIES.
- 417 MAN DOOR.
- 418 3/4" V-REVEAL.
- 421 CLERESTORY WINDOW.
- 426 TRELLIS.
- 428 PAINTED MURAL - BY OTHERS.


BUILDING 2 - EXTERIOR ELEVATIONS	
DATE	04/03/2019
REF/MRKS	PLANNING SUBMITTAL
1	

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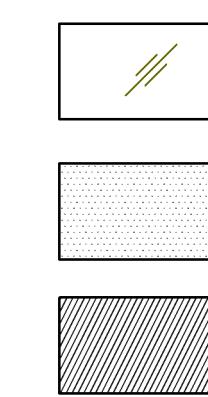
#### LEGEND

##### MATERIALS:



- WHITE PORCELAIN TILE RAIN SCREEN SYSTEM OVER CONCRETE WALL
- EXTERIOR SMOOTH PLASTER FINISH WITH INTEGRAL COLOR OVER METAL STUD WALL
- METAL CANOPY, PAINTED
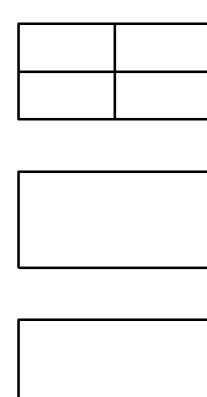
##### GLASS:




- VISION GLASS
- TEMPERED GLASS
- SPANDREL GLASS

##### COLORS:

- PROVIDE 6'-0" WIDE PAINT COLOR MOCK-UP FULL HEIGHT OF BUILDING FOR OWNER/ARCHITECT REVIEW.
- BASE COLOR: SHERWIN WILLIAMS SW 7064 - PASSIVE
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- ACCENT COLOR: SHERWIN WILLIAMS SW 6965 - HYPER BLUE
- ACCENT/SIGNAGE COLOR: SHERWIN WILLIAMS SW 6802 - JACARANDA
- ACCENT/SIGNAGE COLOR: SHERWIN WILLIAMS SW 6510 - LOYAL BLUE

ALL GLASS USED ON THE ENVELOPE OF THE BUILDING TO BE:  
20 ULTRACLEAR LOW IRON FLOAT GLASS  
23 GUARDING CRYSTALBLUE FLOAT GLASS (1" INSULATED ON CLEAR/SPANDREL WHERE INDICATED)  
SUNGUARD SPANDEL HT - WARM GRAY  
GLASS WIND LOAD RESISTANCE CALCULATIONS ARE UNDER SEPARATE PERMIT  
MULLION FINISH:  
KAWNEER CLEAR NO. 14 AND NO. 17 (OR COMPARABLE)  
TRELLIS:  
LONGBOARD - WESTERN CEDAR

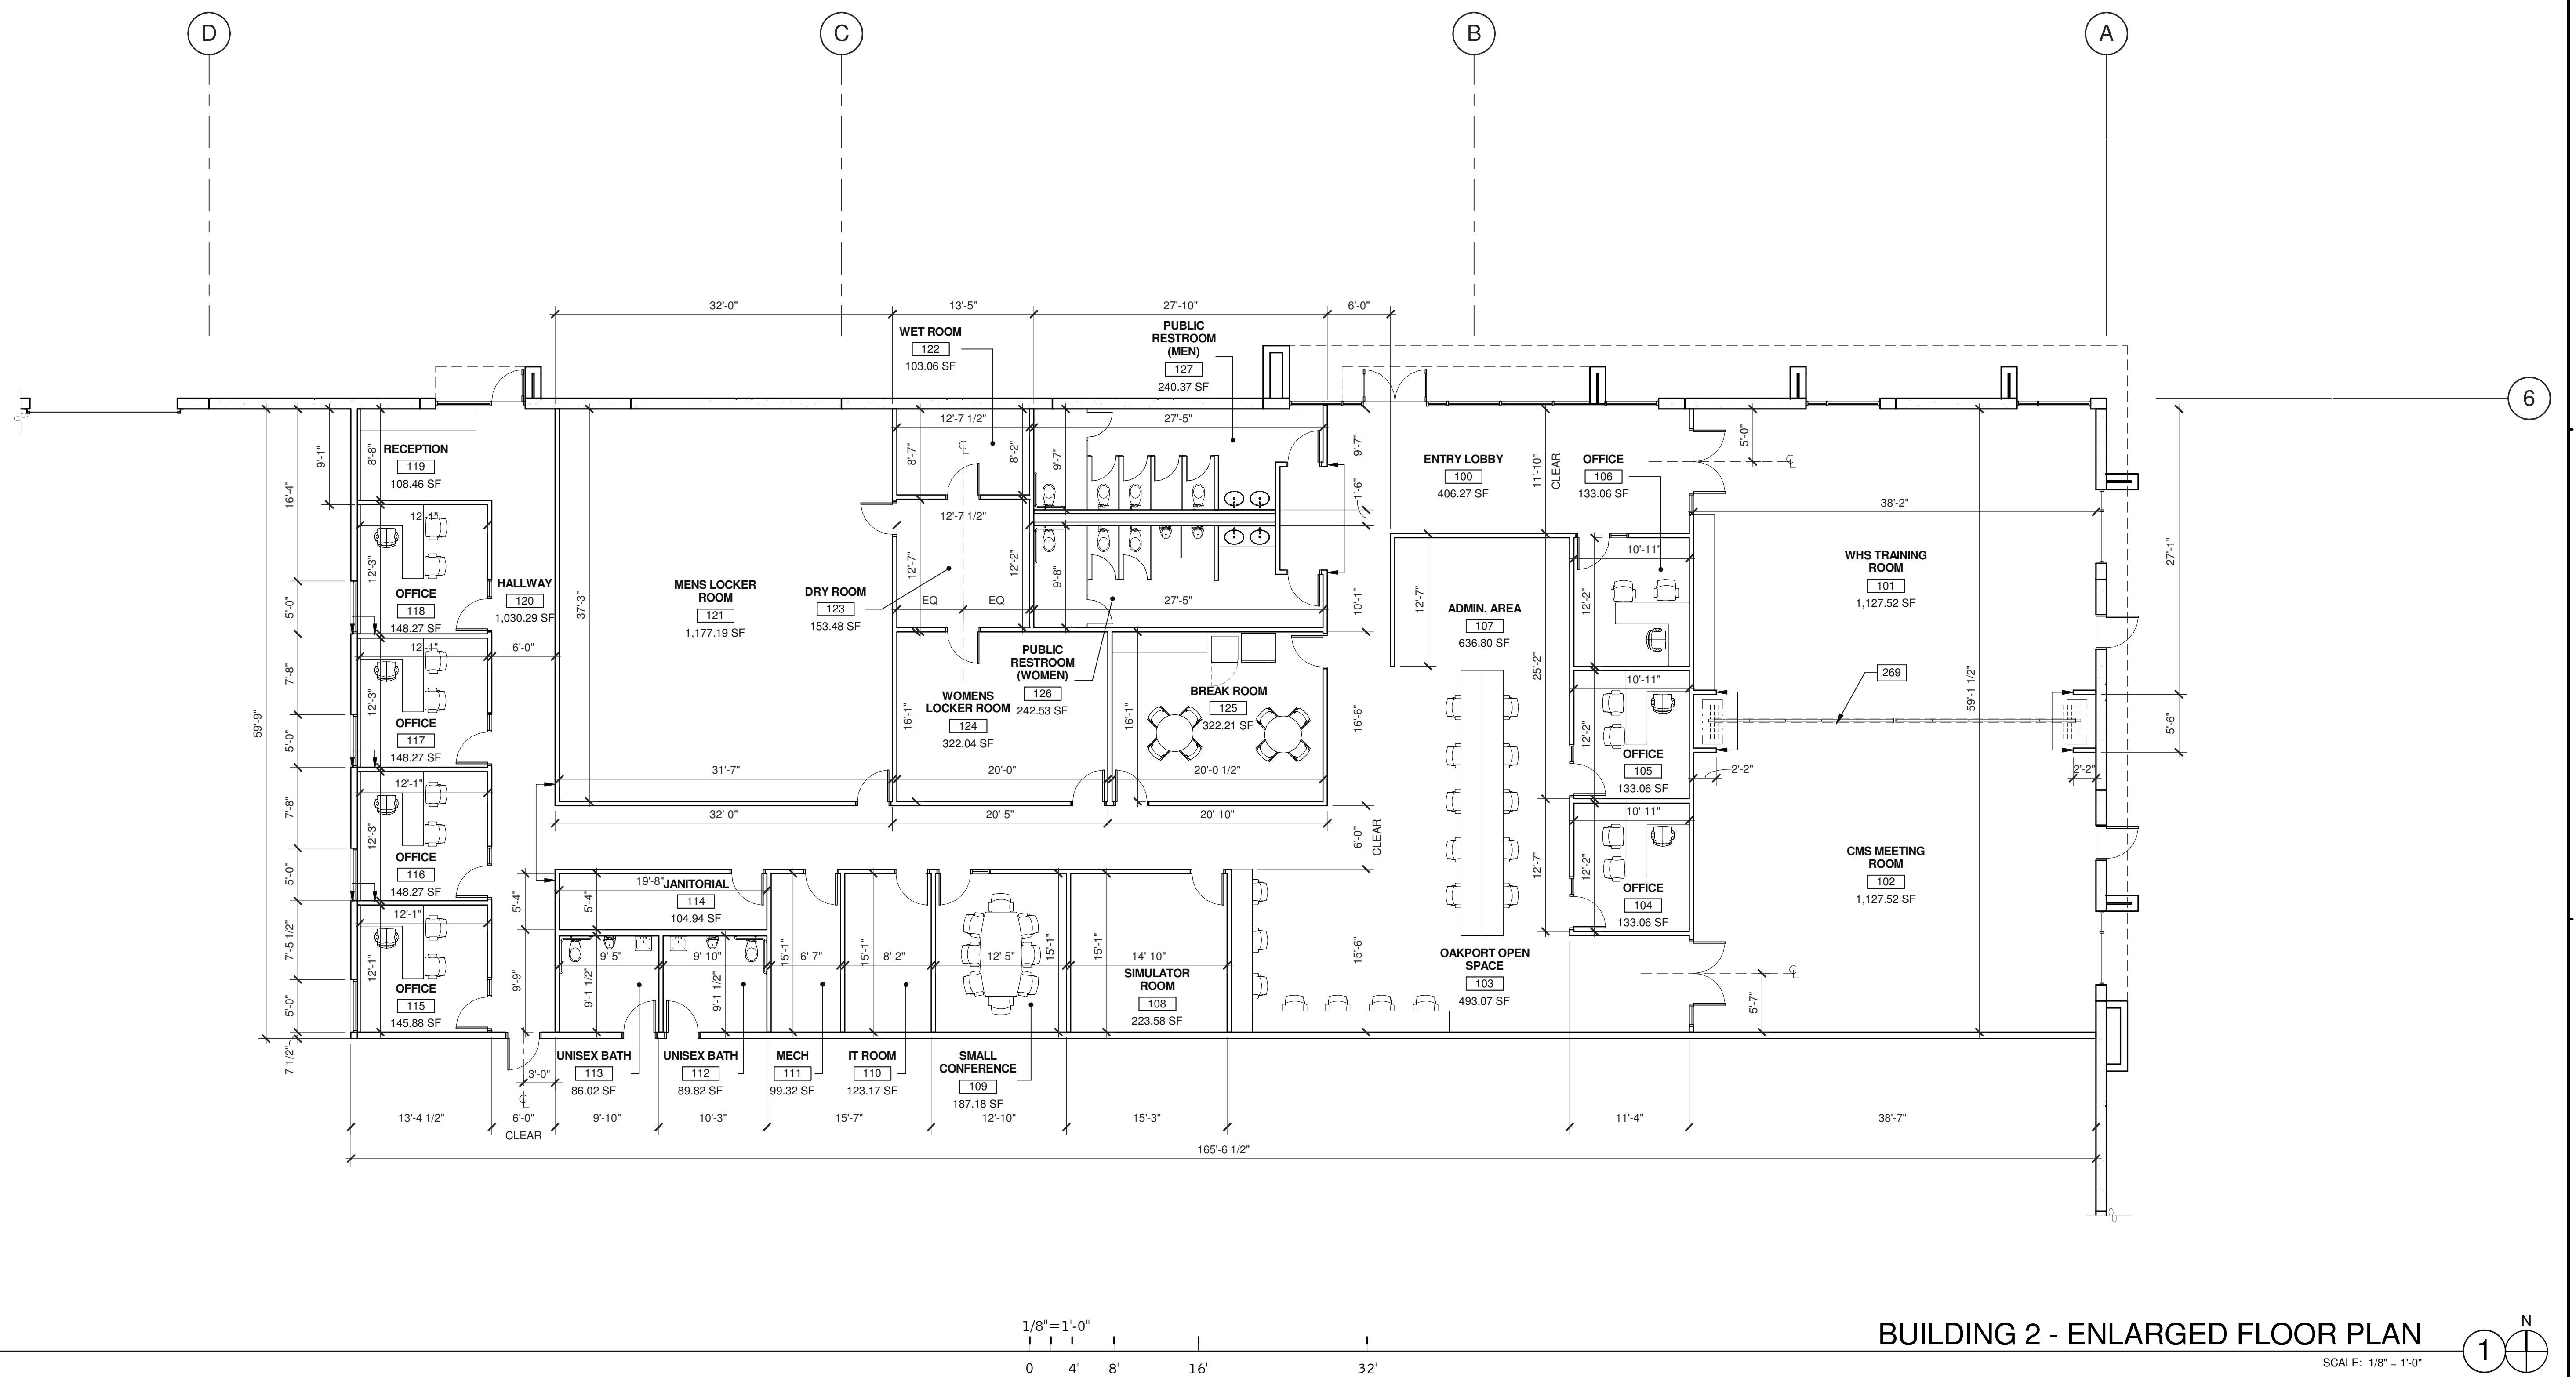

BUILDING 2 - ENLARGED FLOOR PLAN

1/8" = 1'-0"


# TES

## INTERIOR PARTITION.

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# A5.1-2



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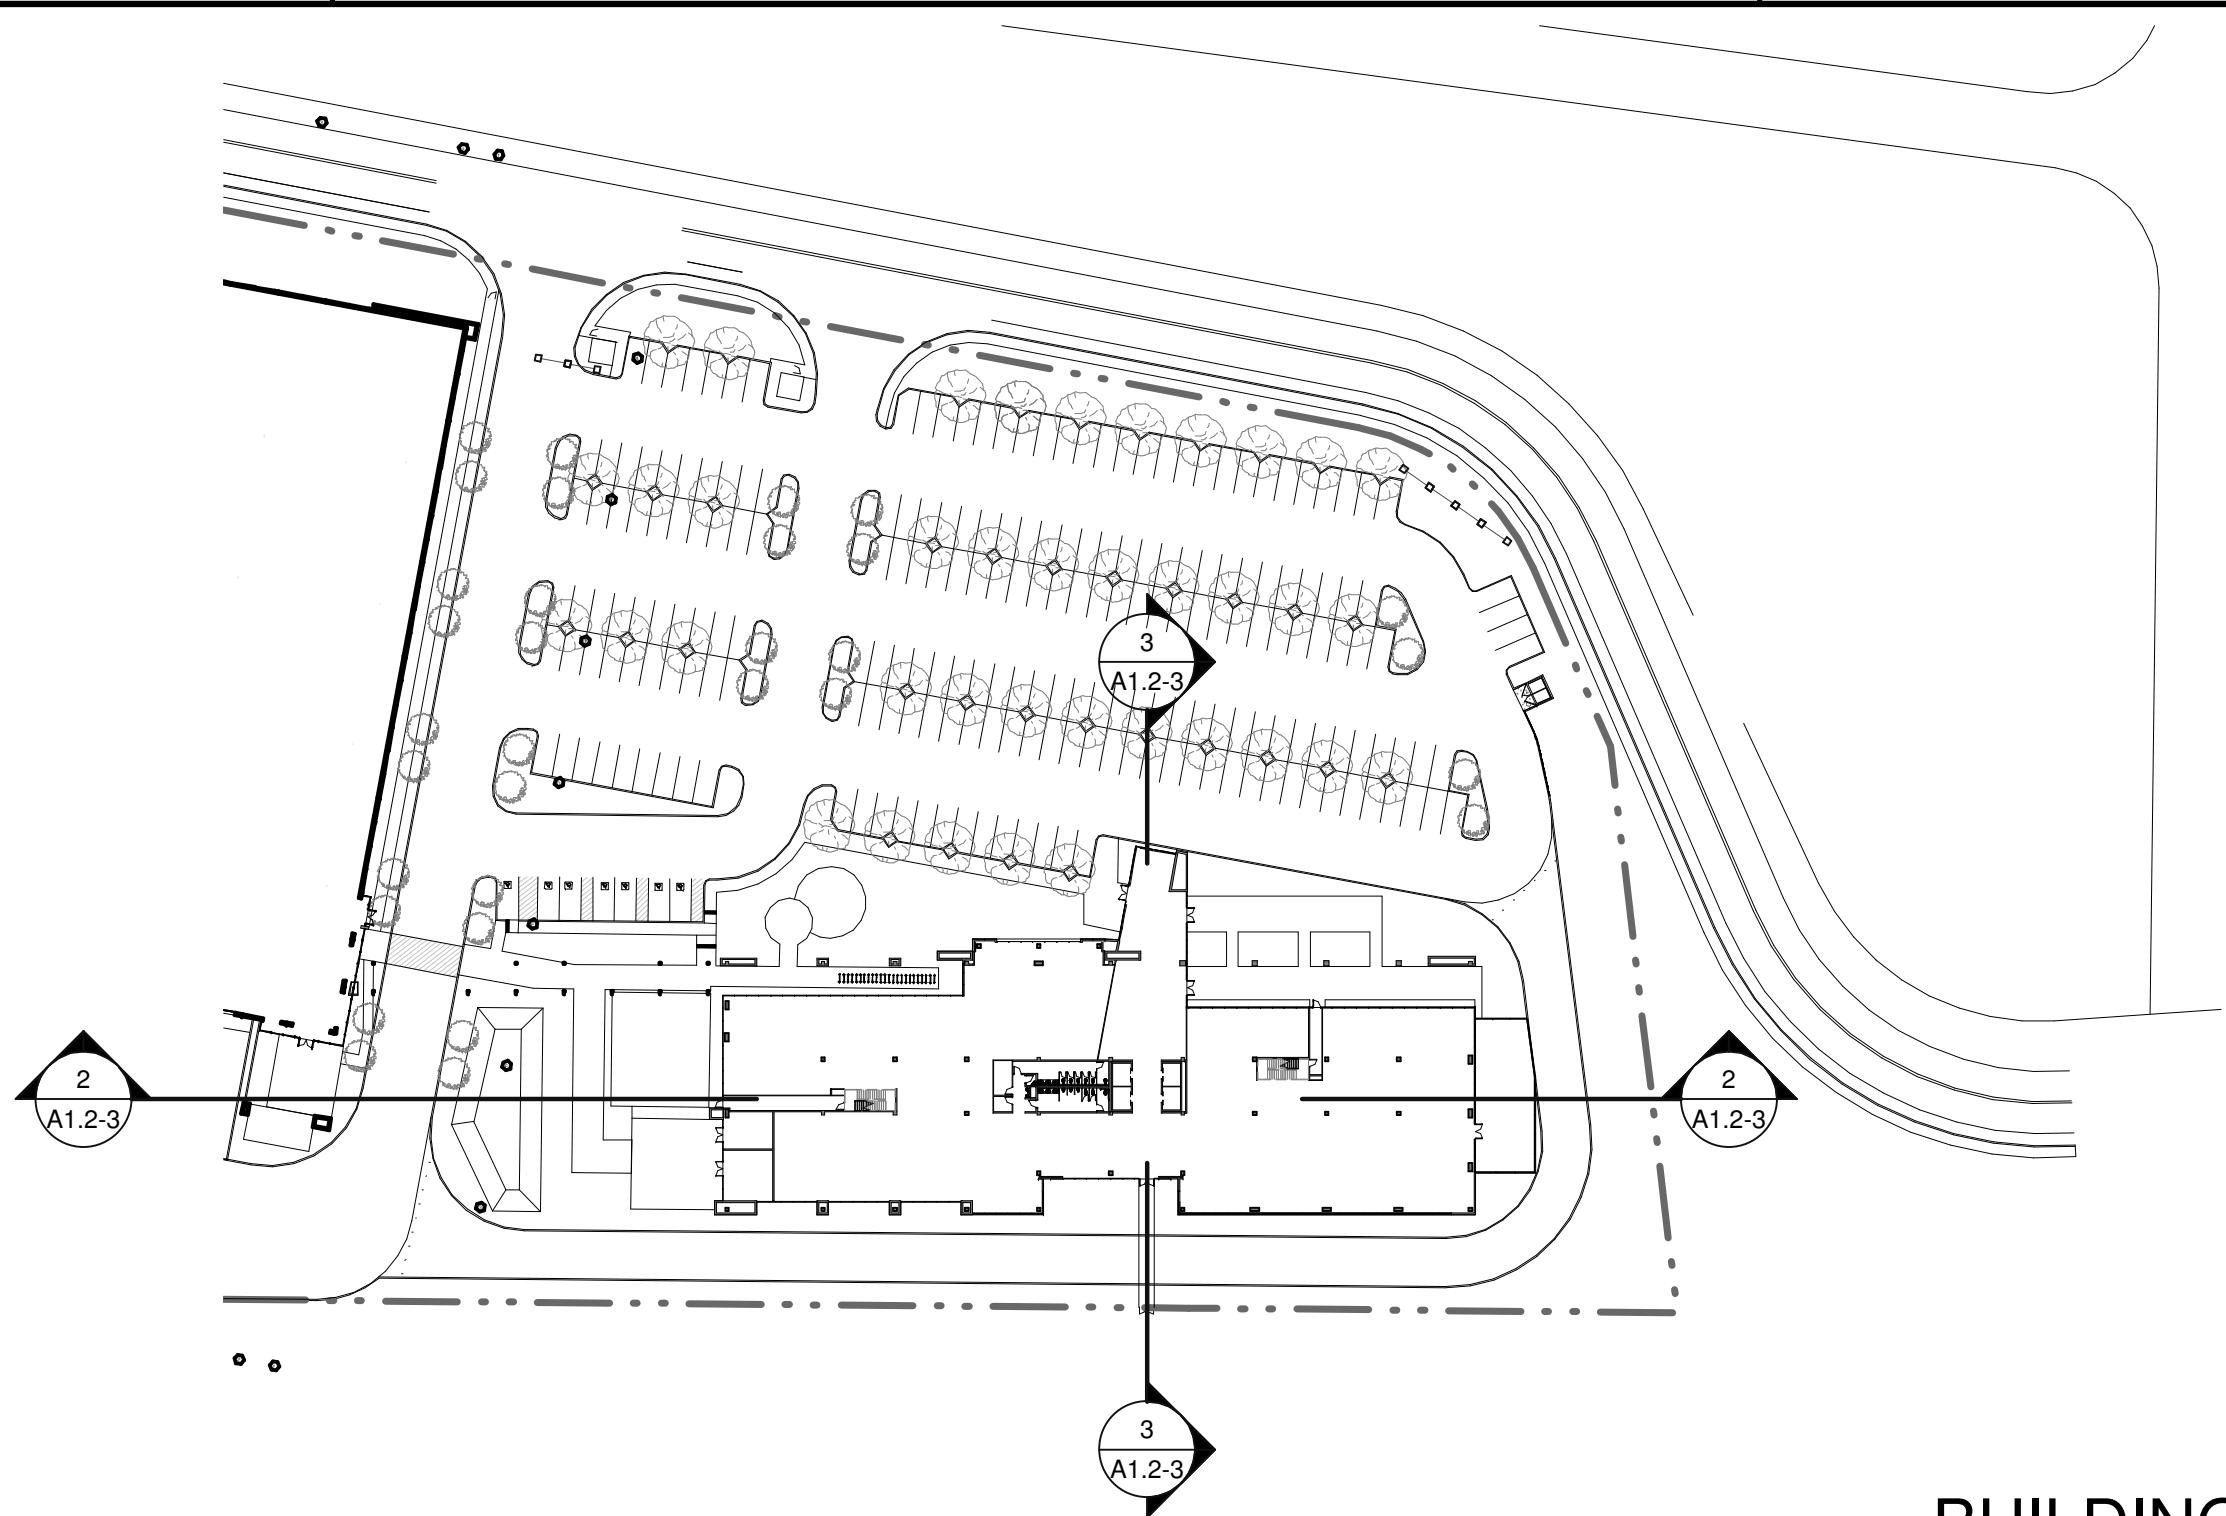
BUILDING 3 - ENLARGED SITE PLAN	
REF MARKS	REMARKS
1	04/03/2019 PLANNING SUBMITTAL
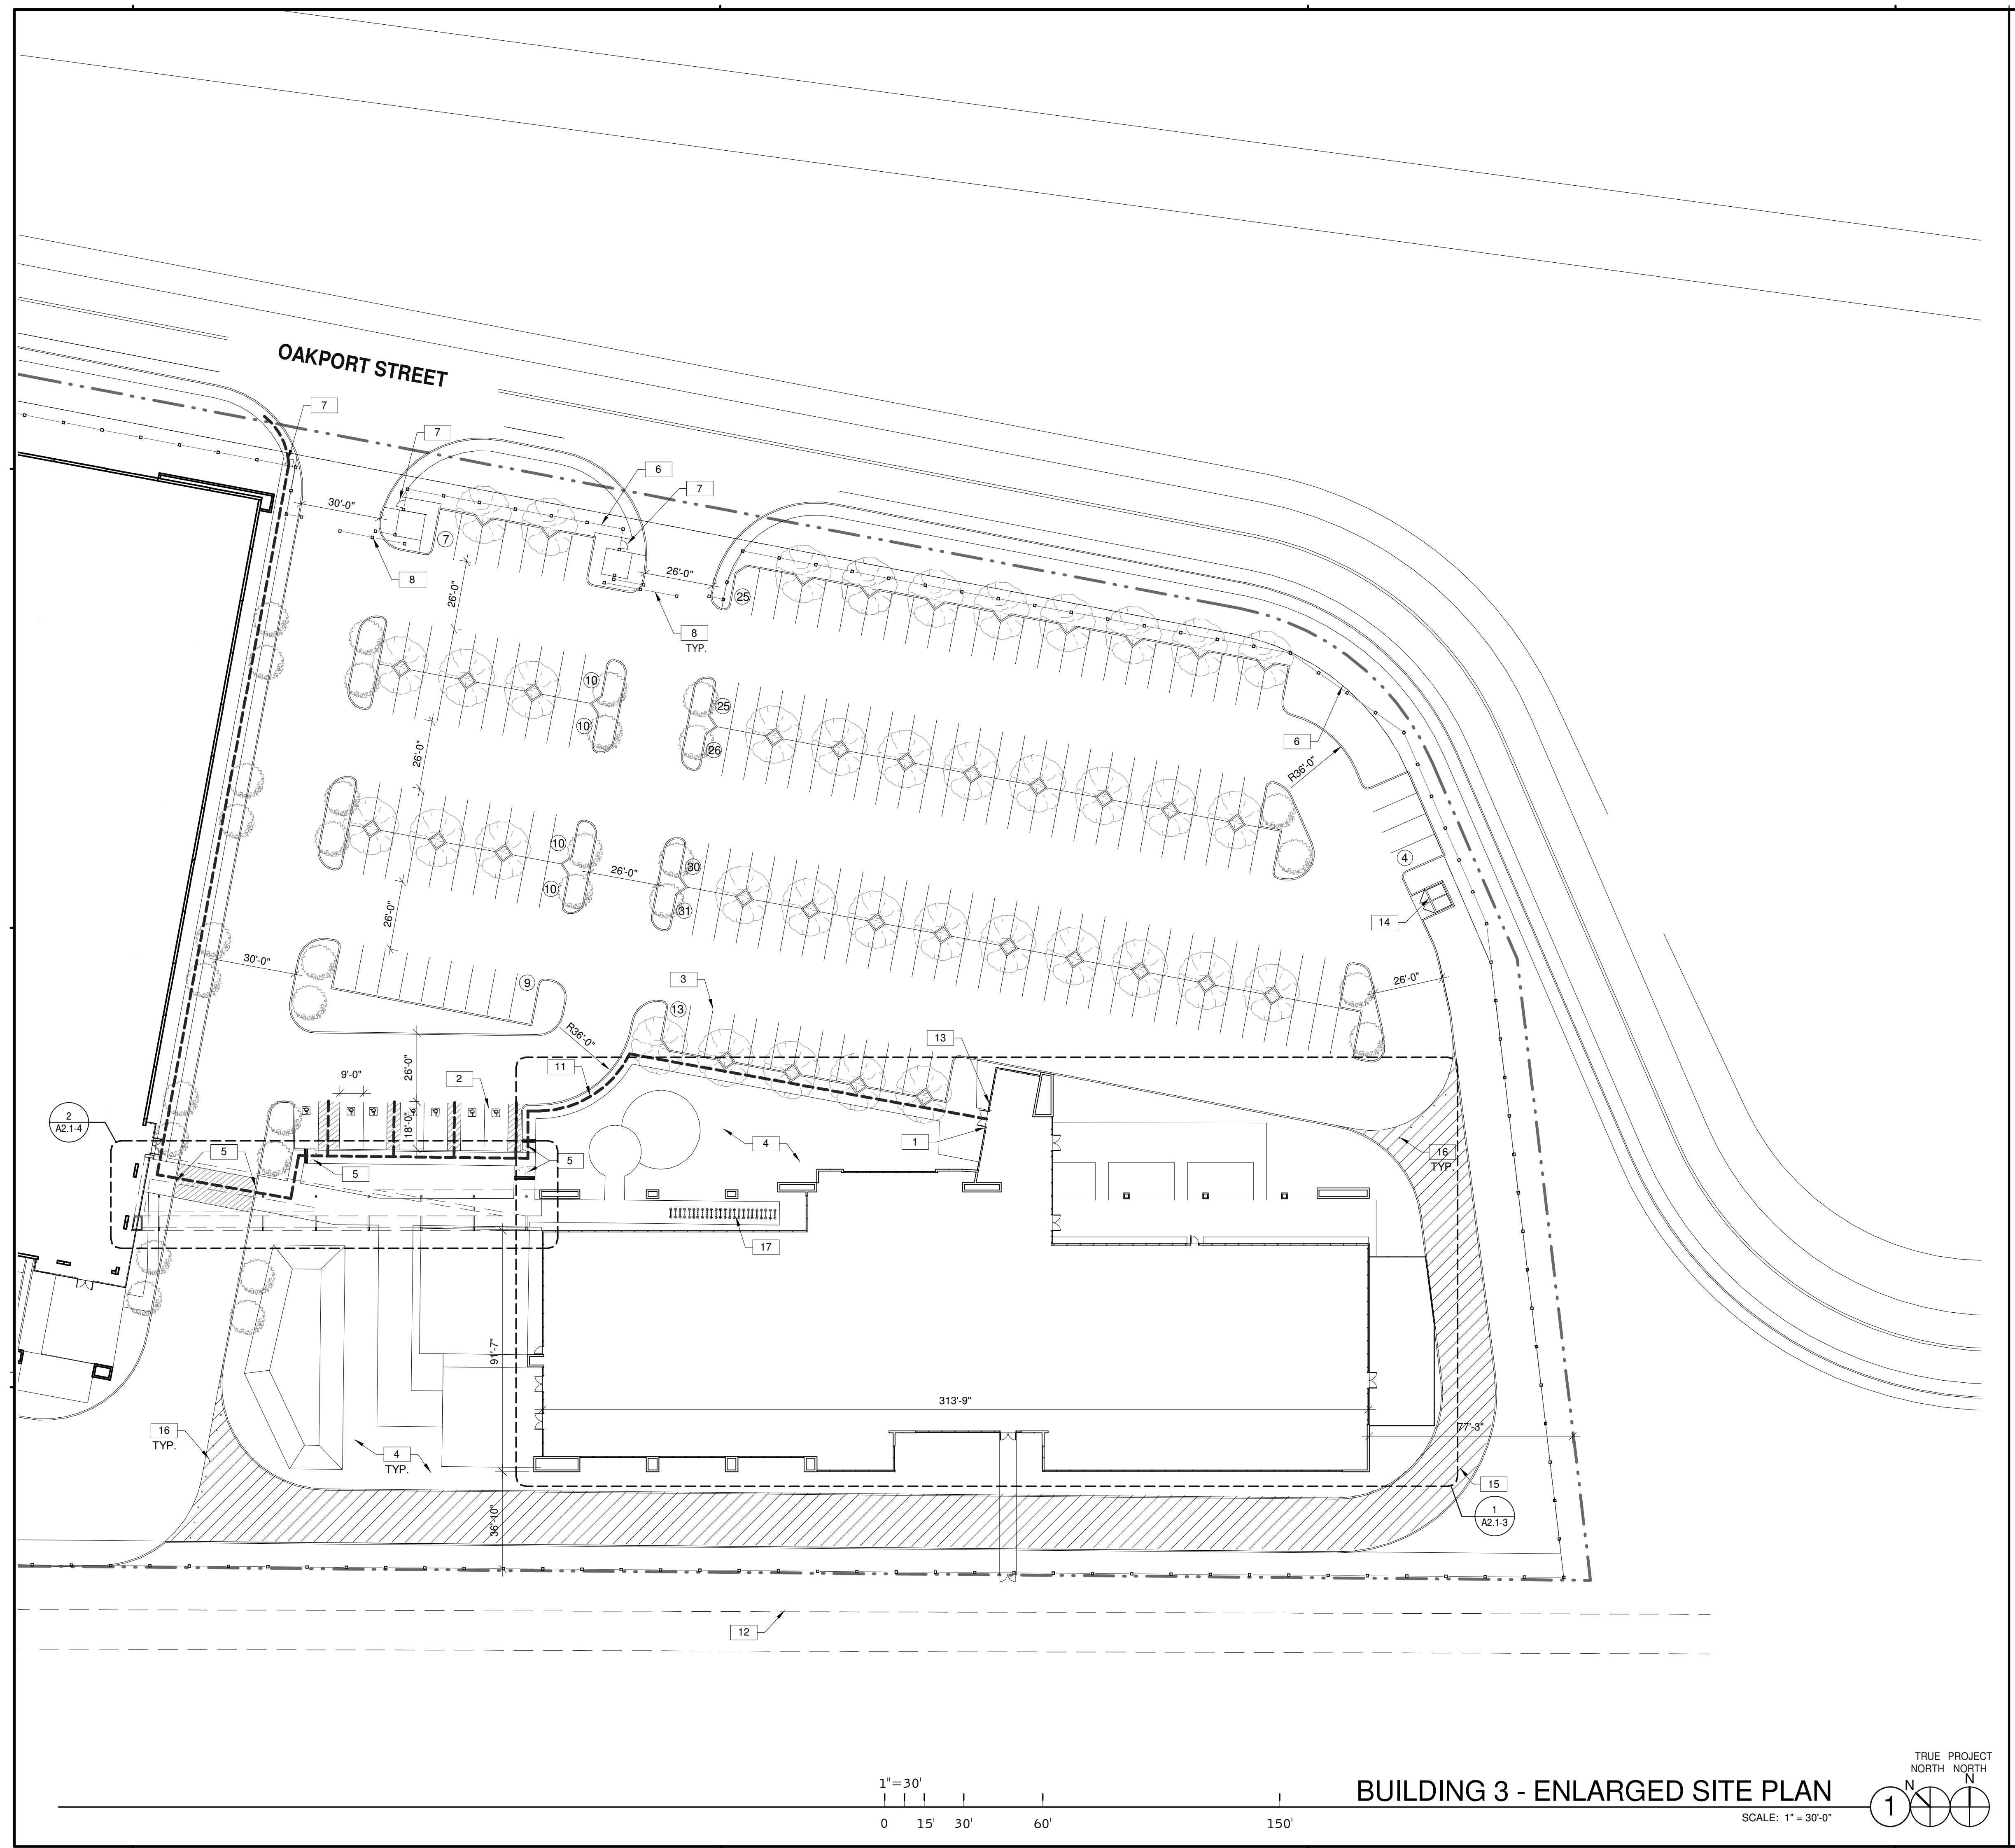
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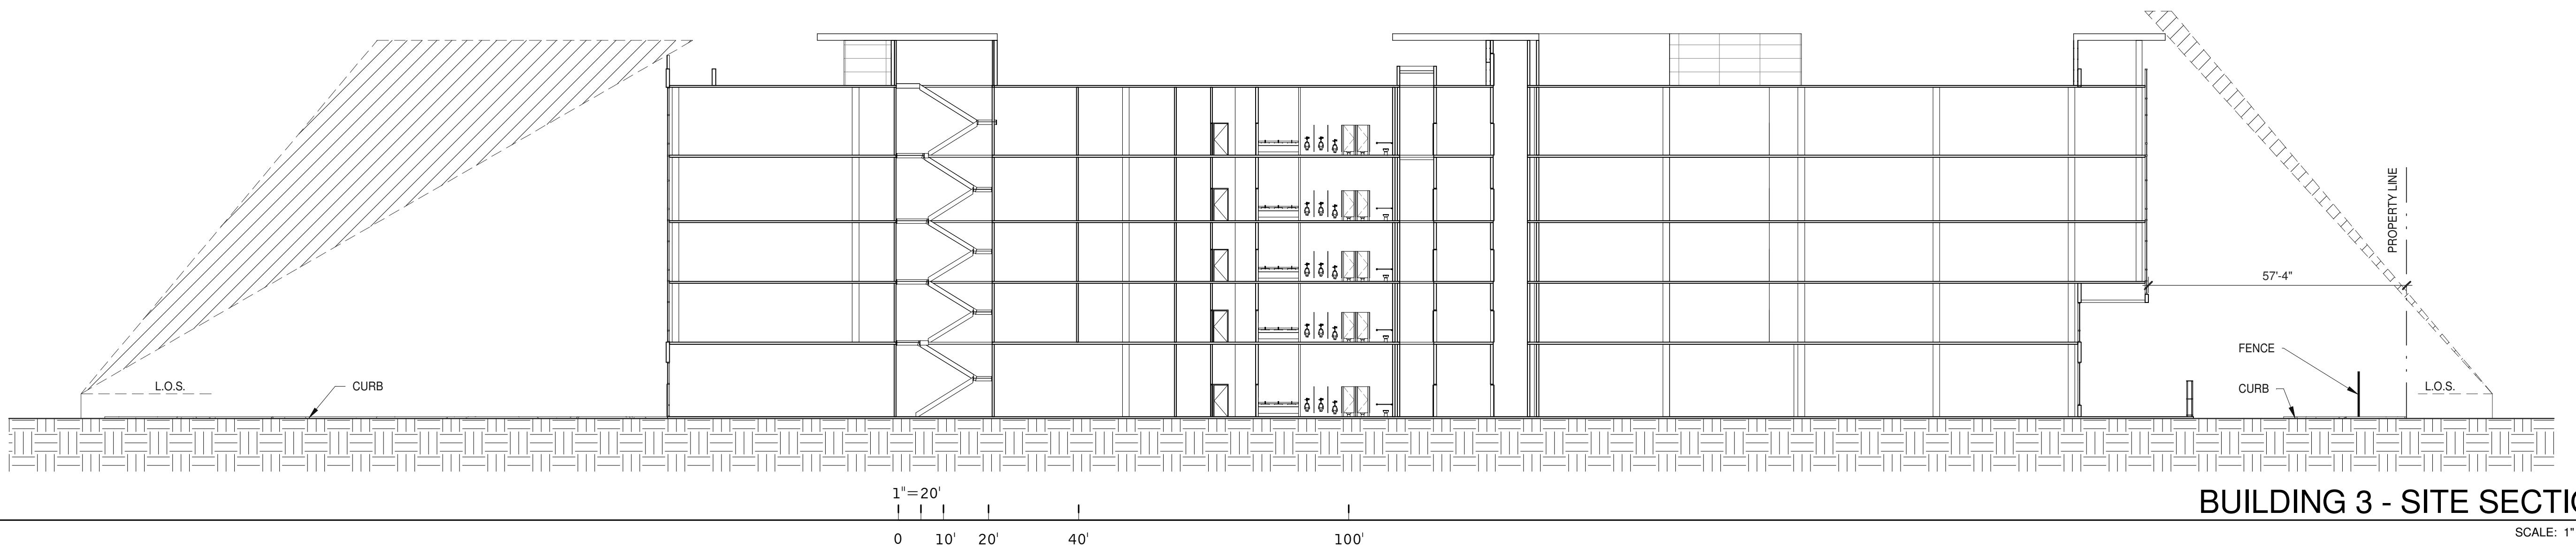
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BUILDING 3 - KEY PLAN - SITE SECTION

SCALE: 1" = 80'-0"


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BUILDING 3 - SITE SECTION

SCALE: 1" = 20'-0"

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BUILDING 3 - SITE SECTION

SCALE: 1" = 20'-0"

**A1.2-3**
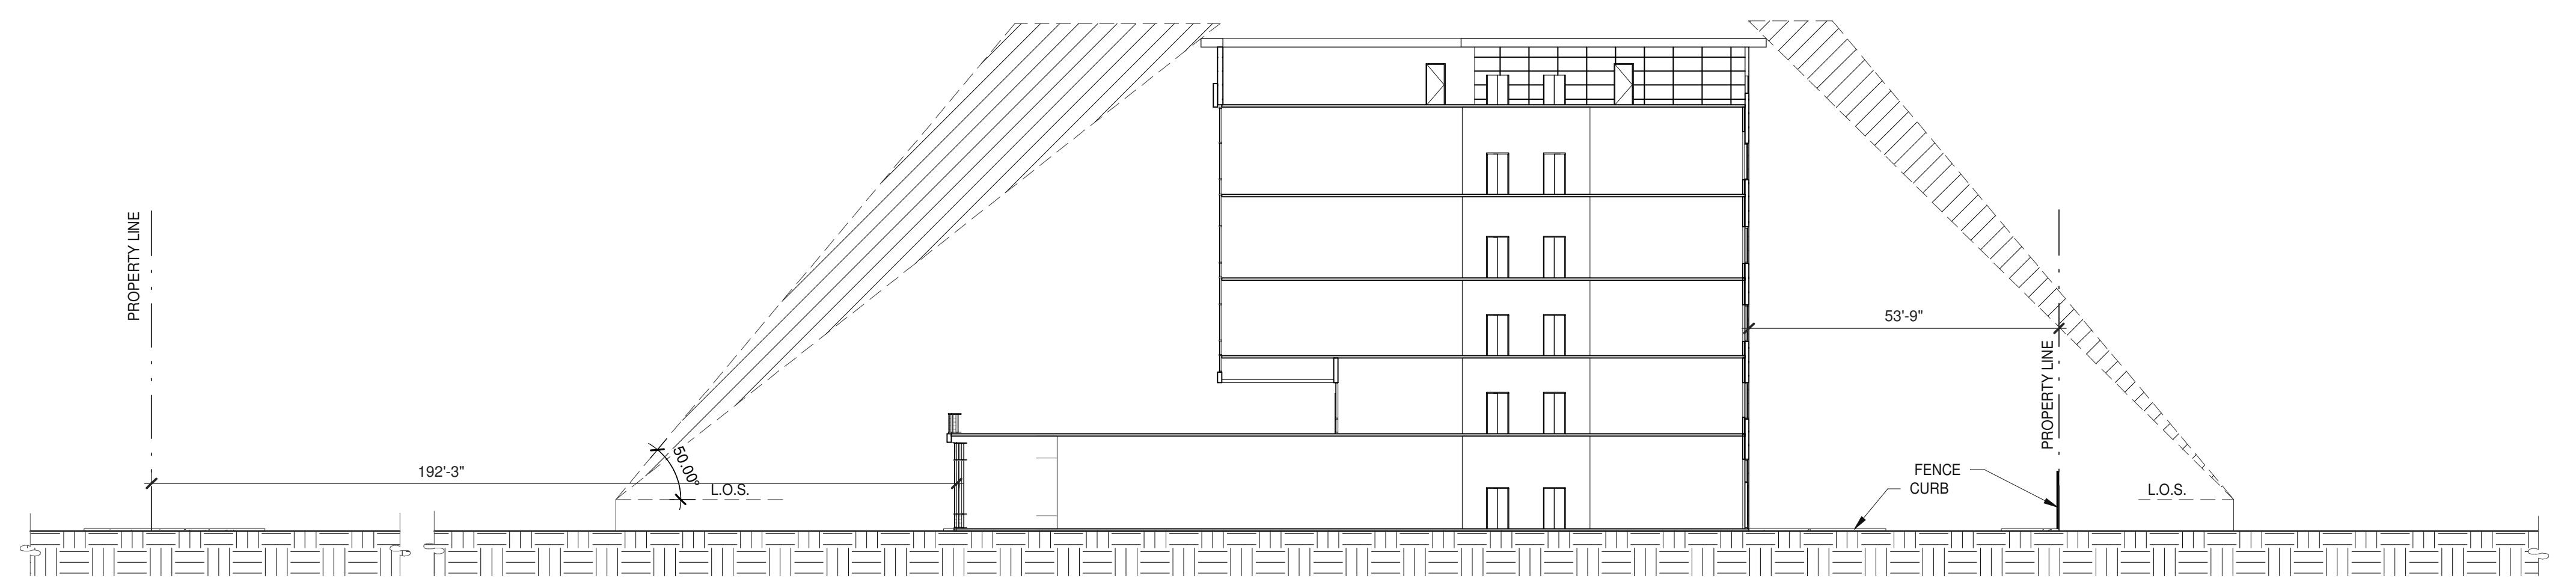
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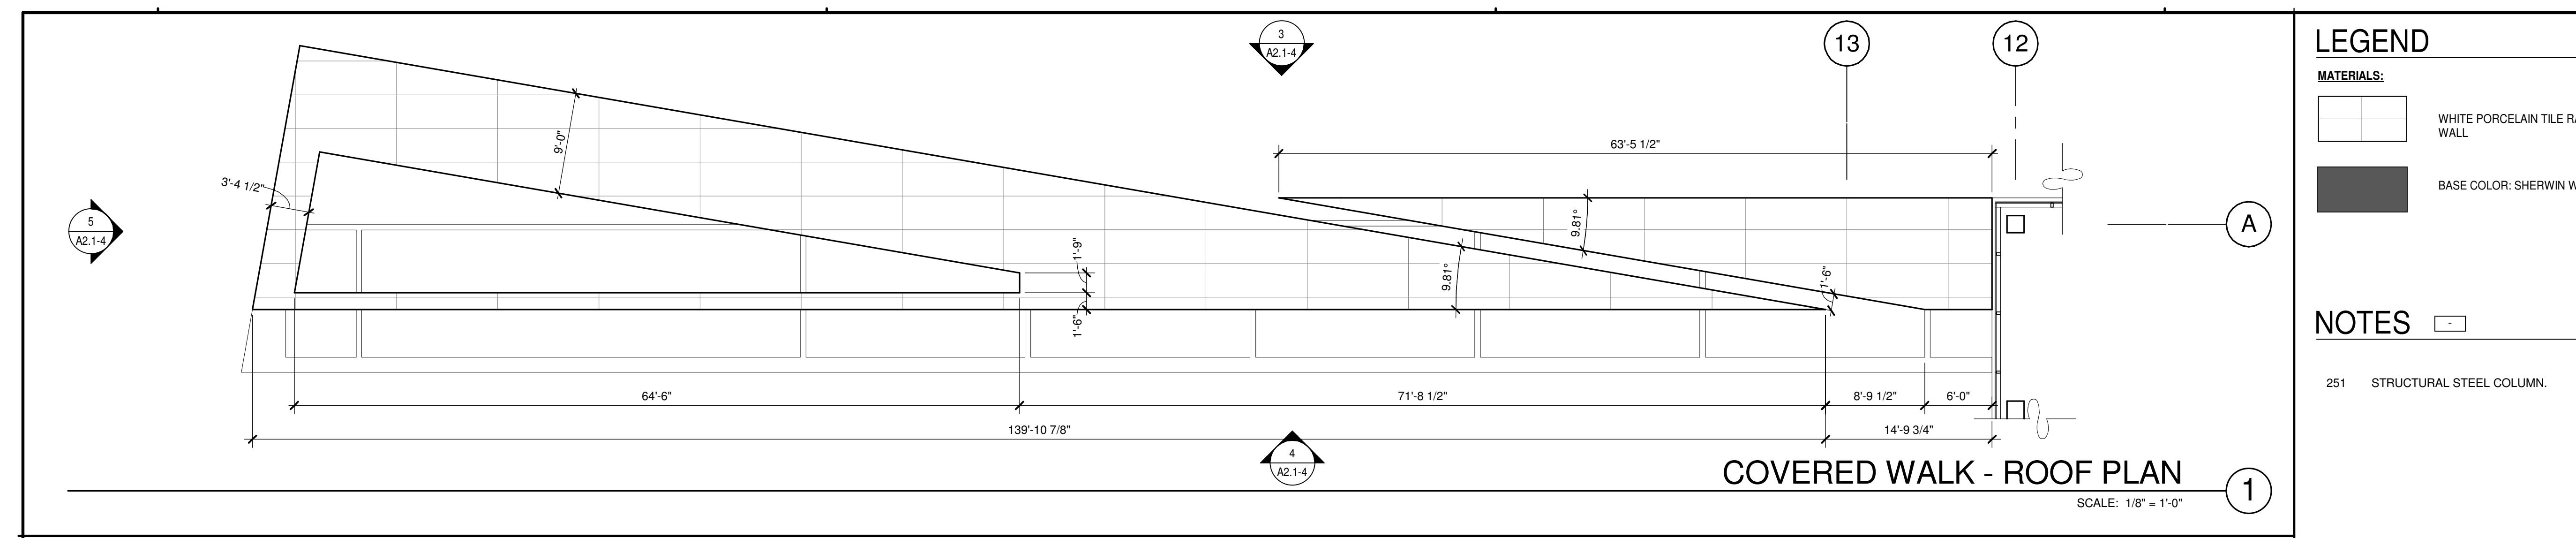
BUILDING 3 - SITE SECTIONS	
DATE	REMARKS
1 04/03/2019	PLANNING SUBMITTAL

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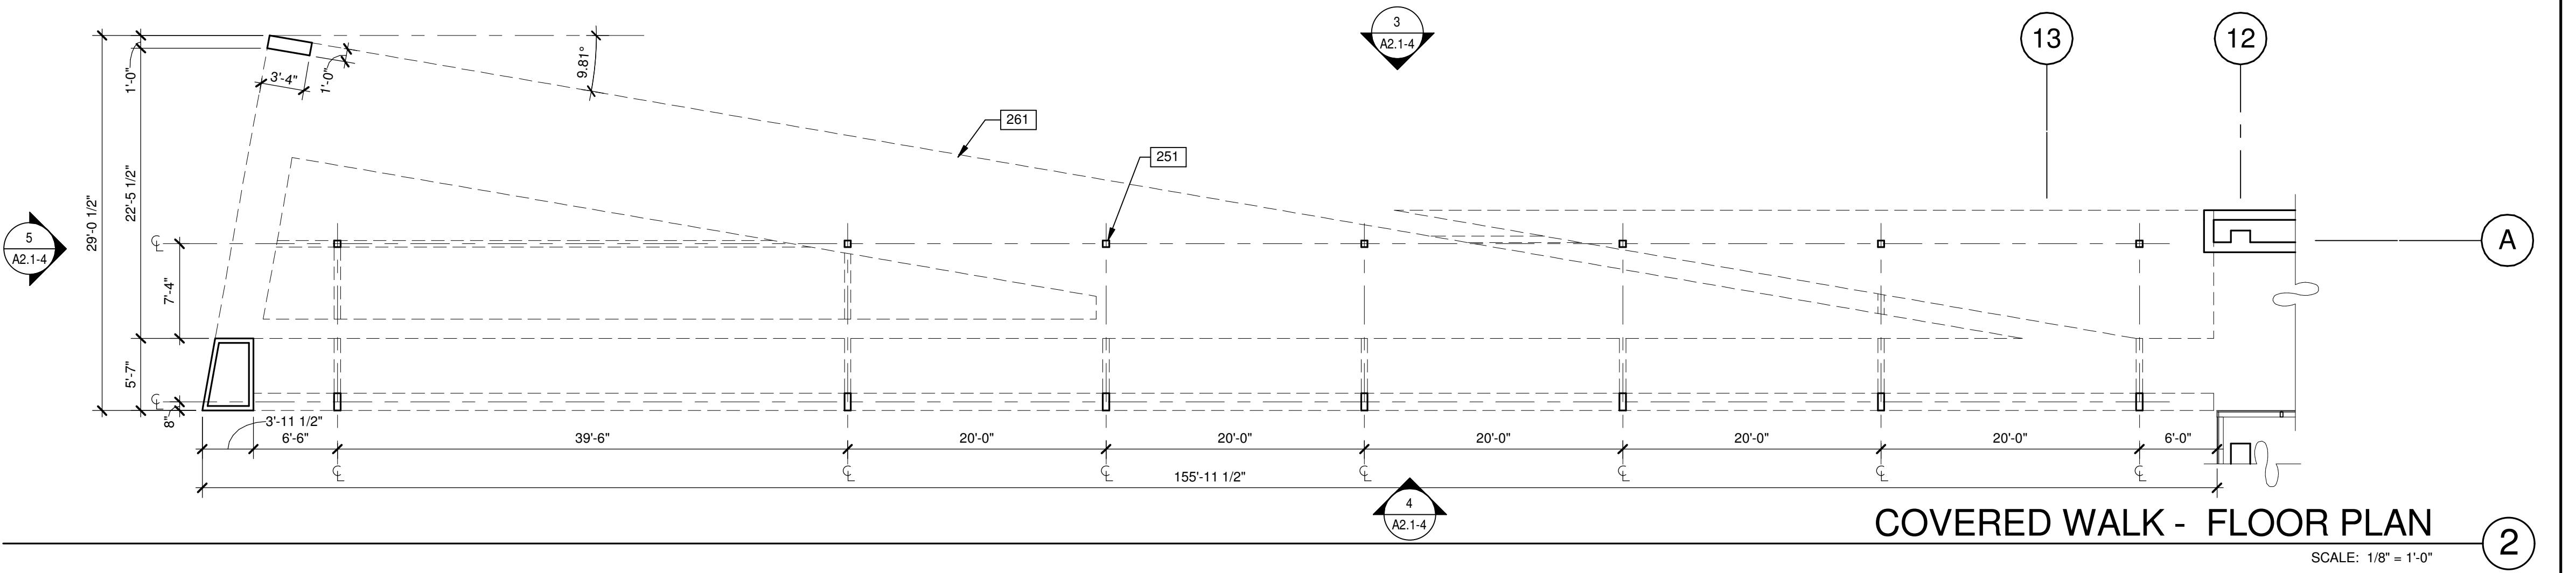
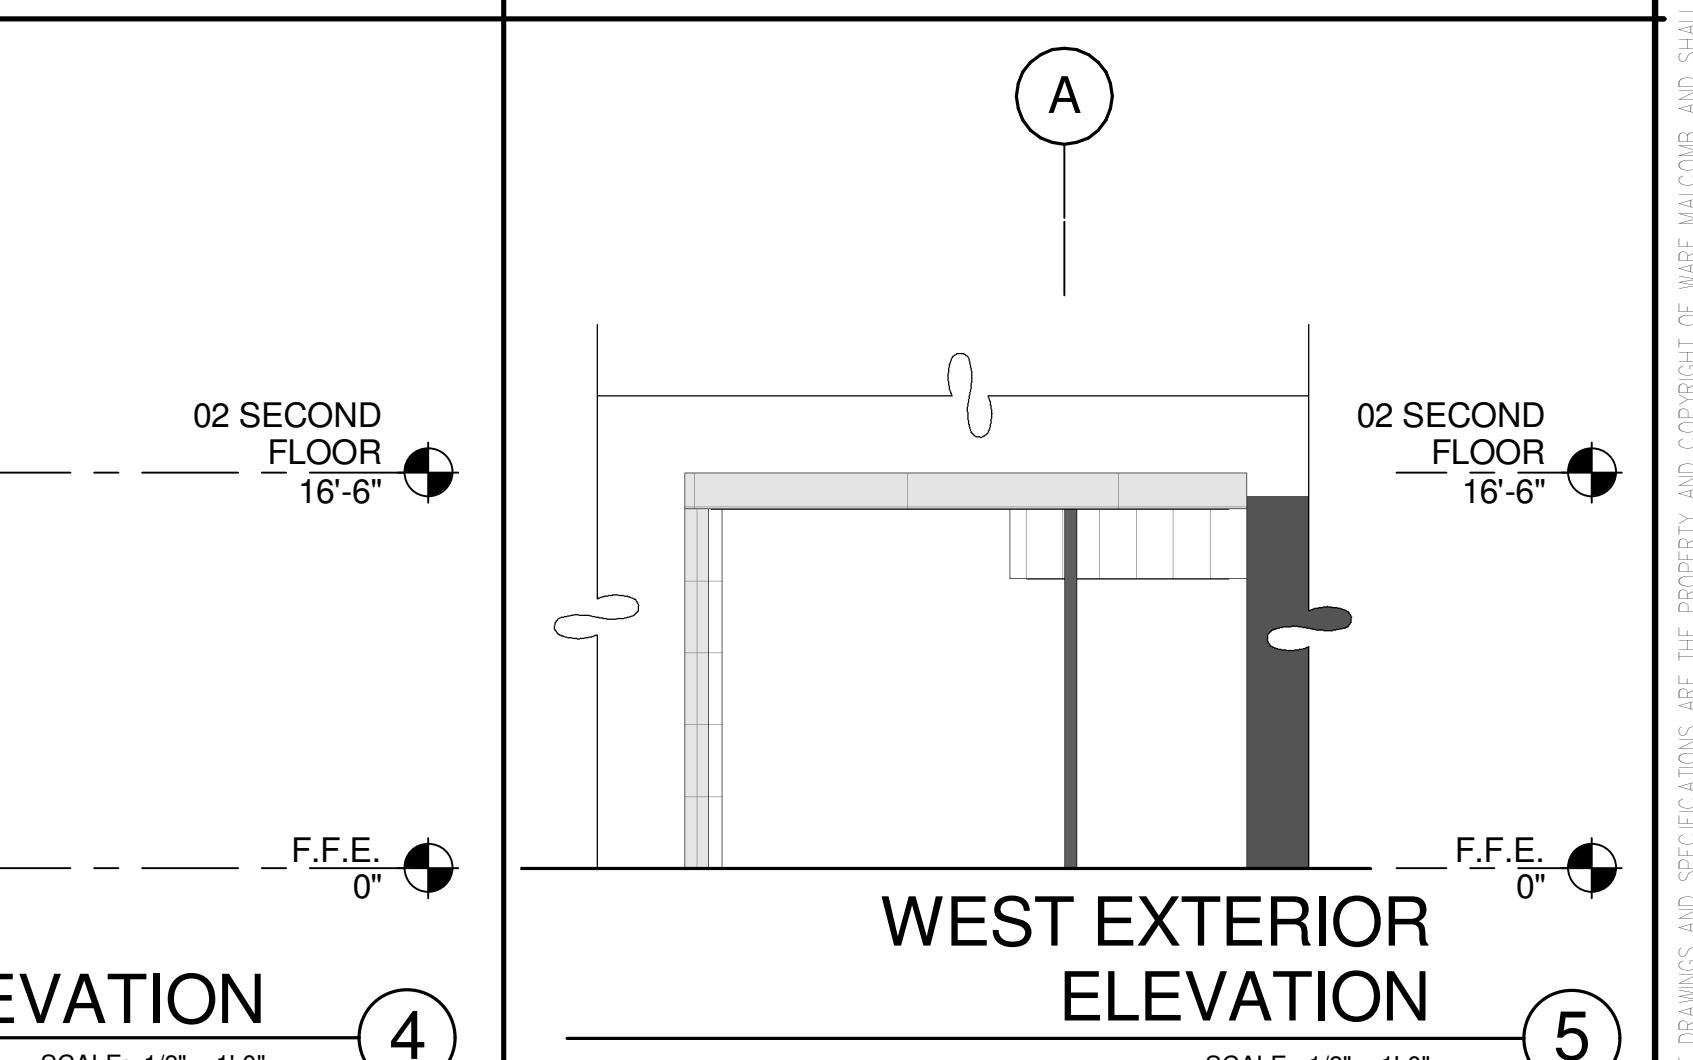
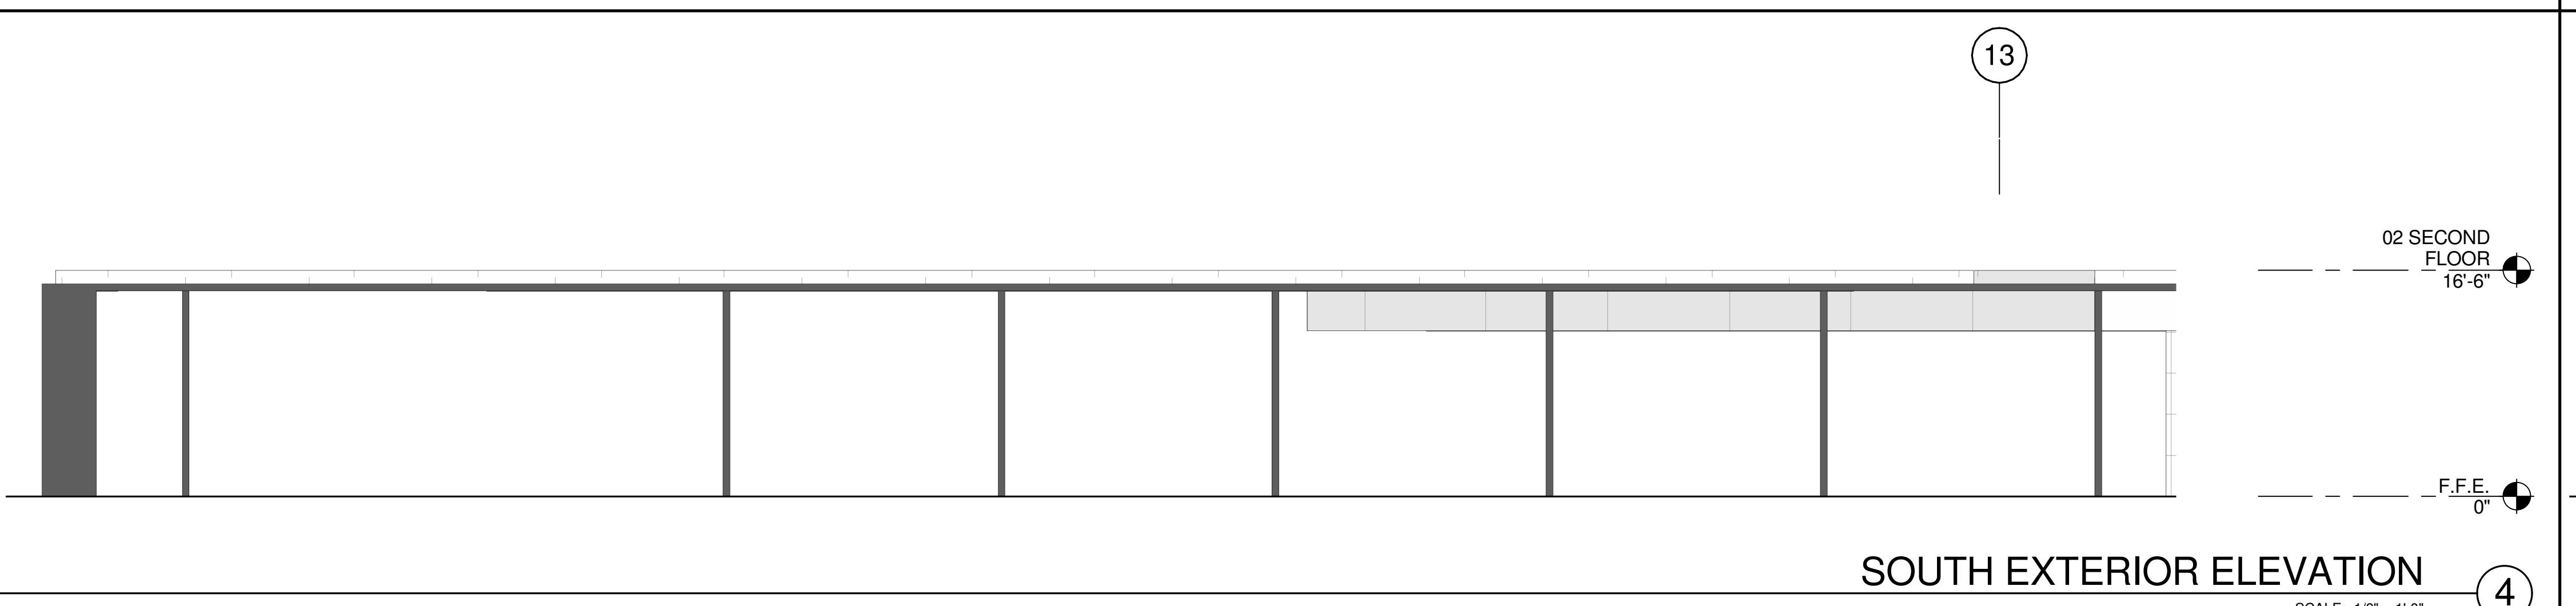
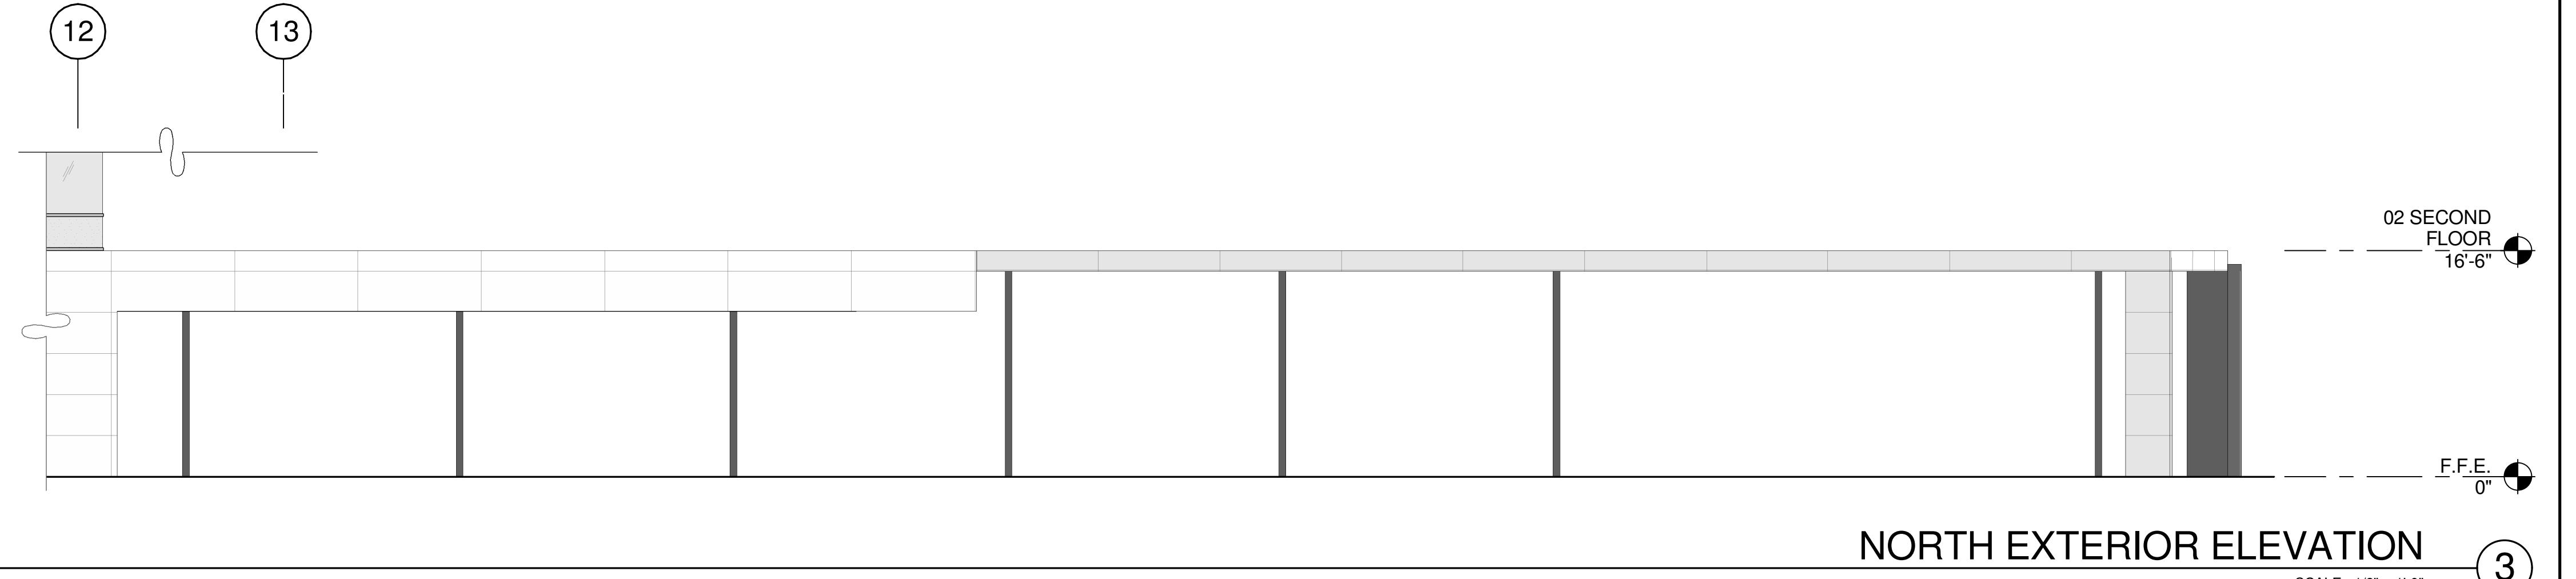
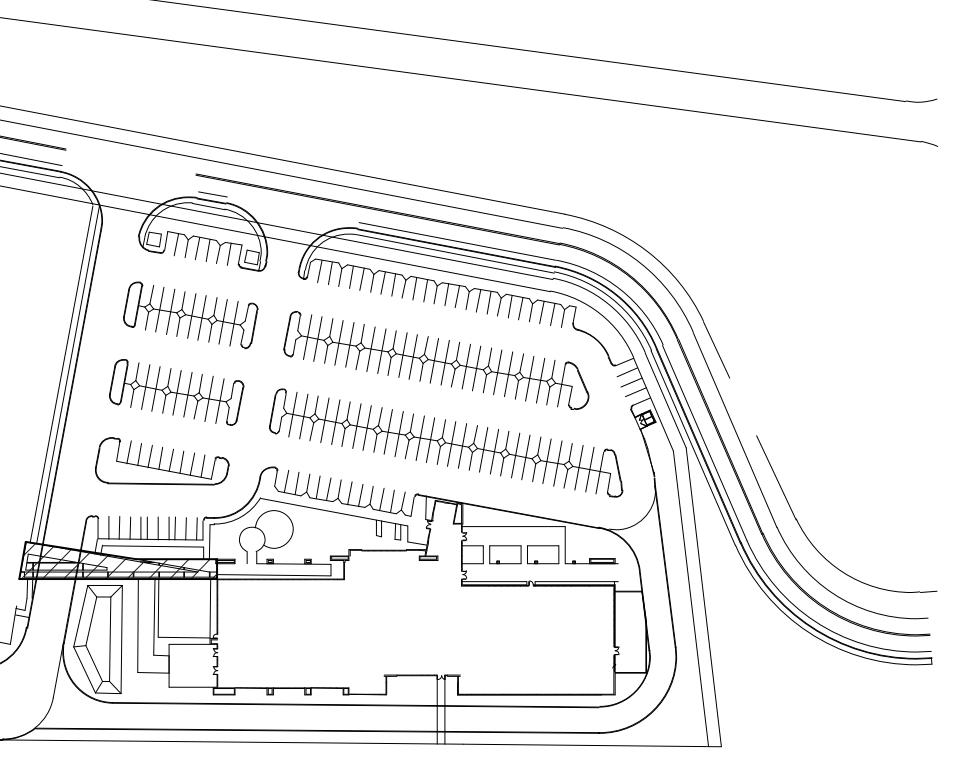
**LEGEND****MATERIALS:**

WHITE PORCELAIN TILE RAIN SCREEN SYSTEM OVER CONCRETE WALL

BASE COLOR: SHERWIN WILLIAMS SW 7674 PEPPERCORN

**NOTES**

251 STRUCTURAL STEEL COLUMN.

**KEY PLAN**

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**BUILDING 4 - FLOOR PLAN & EXT. ELEV.**


REMARKS:  
1 04/03/2019 PLANNING SUBMITTAL

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# SHEET

# A2.2-3

BIM 360://SNR17-0069-00\_66th Ave and Oakport St//0069\_B3\_ARCH.rvt

## WALL LEGEND

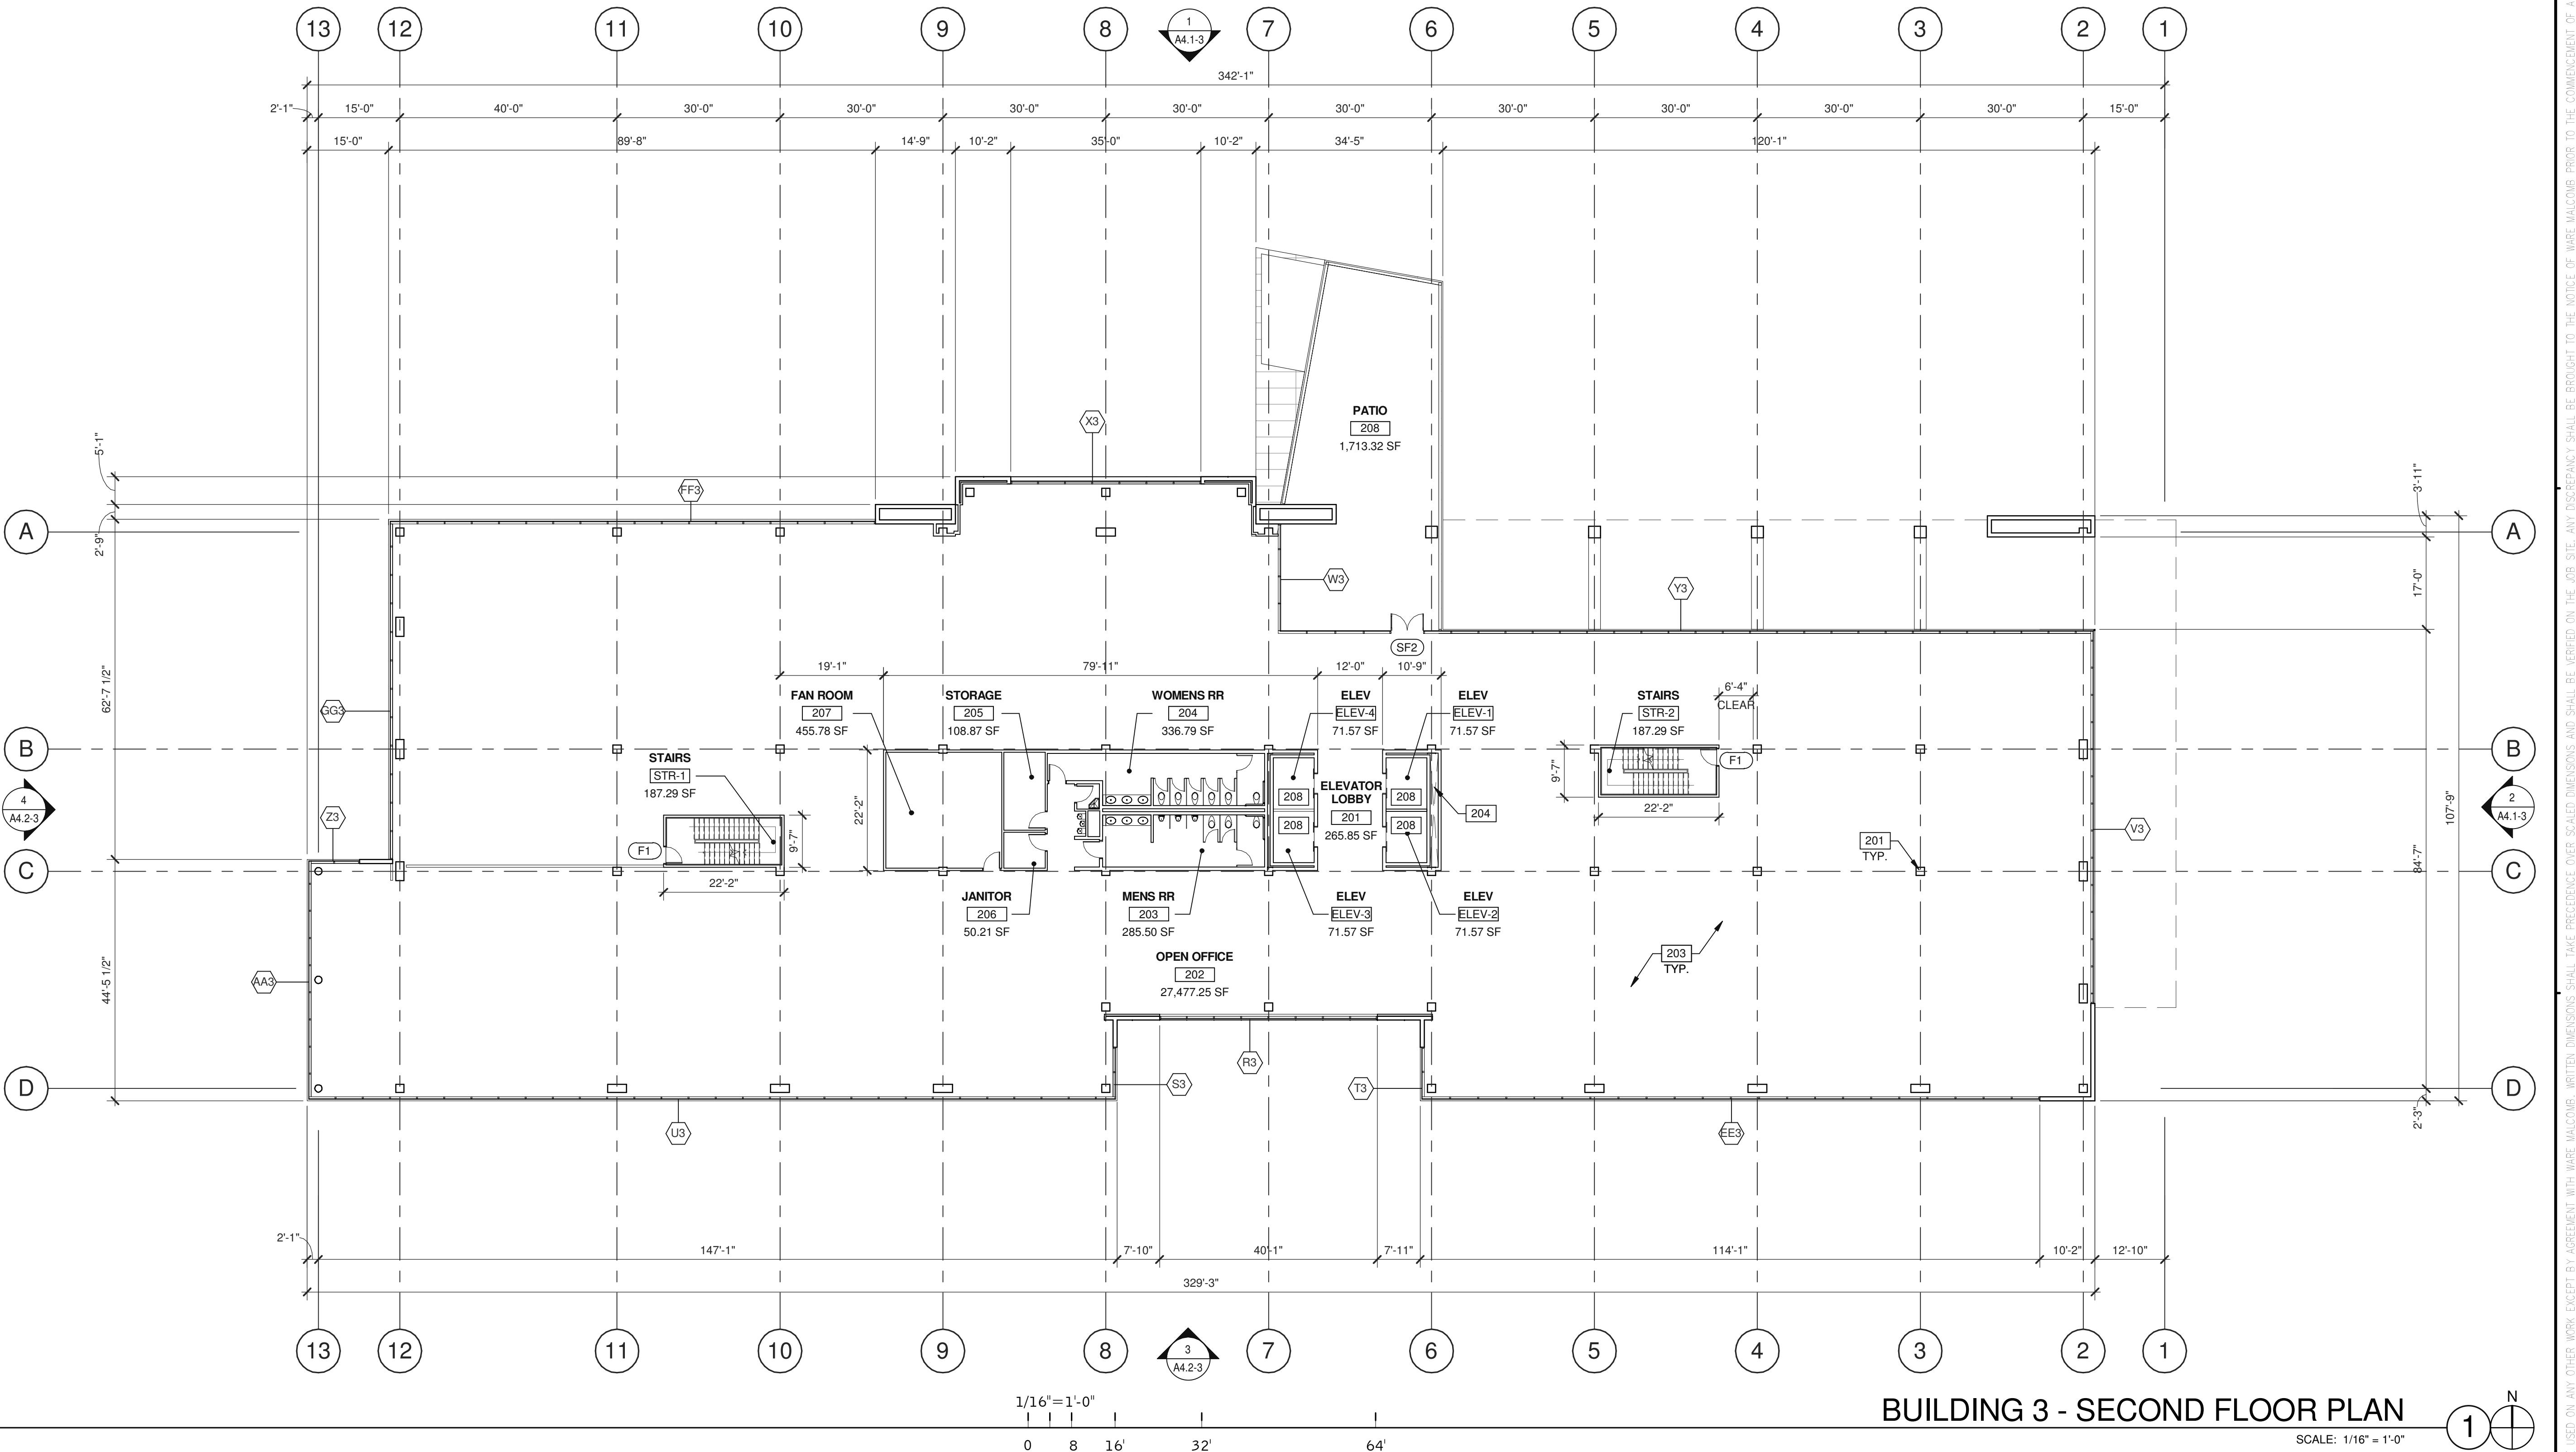-  CONCRETE WALL
  -  CONCRETE WALL WITH FURRING
  -  CONCRETE MASONRY WALL
  -  EXTERIOR PLASTER FINISH OVER METAL STUD WALL
  -  EXTERIOR ALUMINUM COMPOSITE METAL PANEL OVER METAL STUD WALL
  -  1HR FIRE-RESISTANCE RATED
  -  INTERIOR NON-RATED PARTITION

# DOOR TYPES

- 3'-0" x 8'-0"  
CLEAR ANOD. ALUM. STOREFRONT  
DOOR W/TEMPERED GLAZING  
(NARROW STILE)
  
  - 6'-0" x 8'-0" (PAIR)  
CLEAR ANOD. ALUM. STOREFRONT  
DOOR W/TEMPERED GLAZING


DOOR W/TEMPERED GLAZING  
(NARROW STILE)

FRAME: MANUFACTURER

HARDWARE:

2 SETS	PIVOT SET
2 SETS	INTER PIVOT
1 EA	EXIT DEVICE
1 EA	MORTISE CYLINDER
2 SETS	OFFSET PULL
2 EA	OH CLOSER
1 EA	THRESHOLD
1 EA	DECAL

**NOTE: WEATHERSEAL BY DOOR MANUFACTURER**

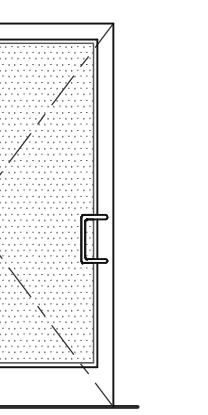


# DOOR NOTES

**BUTT HINGES:**  
SOSS - STANDARD WEIGHT, PLAIN BEARING, STEEL HINGES OR APPROVED EQUAL.  
ALL EXTERIOR OUTSWING DOOR BUTTS SHALL BE MADE OF NON-FERROUS MATERIAL AND SHALL HAVE STAINLESS STEEL HINGE PINS.

- I DUPRIN 99 SERIES PANIC DEVICE OR APPROVED EQUAL**  
**USING DEVICES:** NORTON 8500 BF SERIES OR APPROVED EQUAL  
**PS:** TRIMCO W1200 SERIES DOOR STOP  
**E BOLT AND PAD LOCK:** INSTALL SLIDE BOLT ABOVE LEVEL OF DOOR GUARD

# OTES

- STRUCTURAL COLUMN.  
CONCRETE OVER METAL DECK FLOOR.  
MECHANICAL SHAFT.  
3500 LB TRACTION

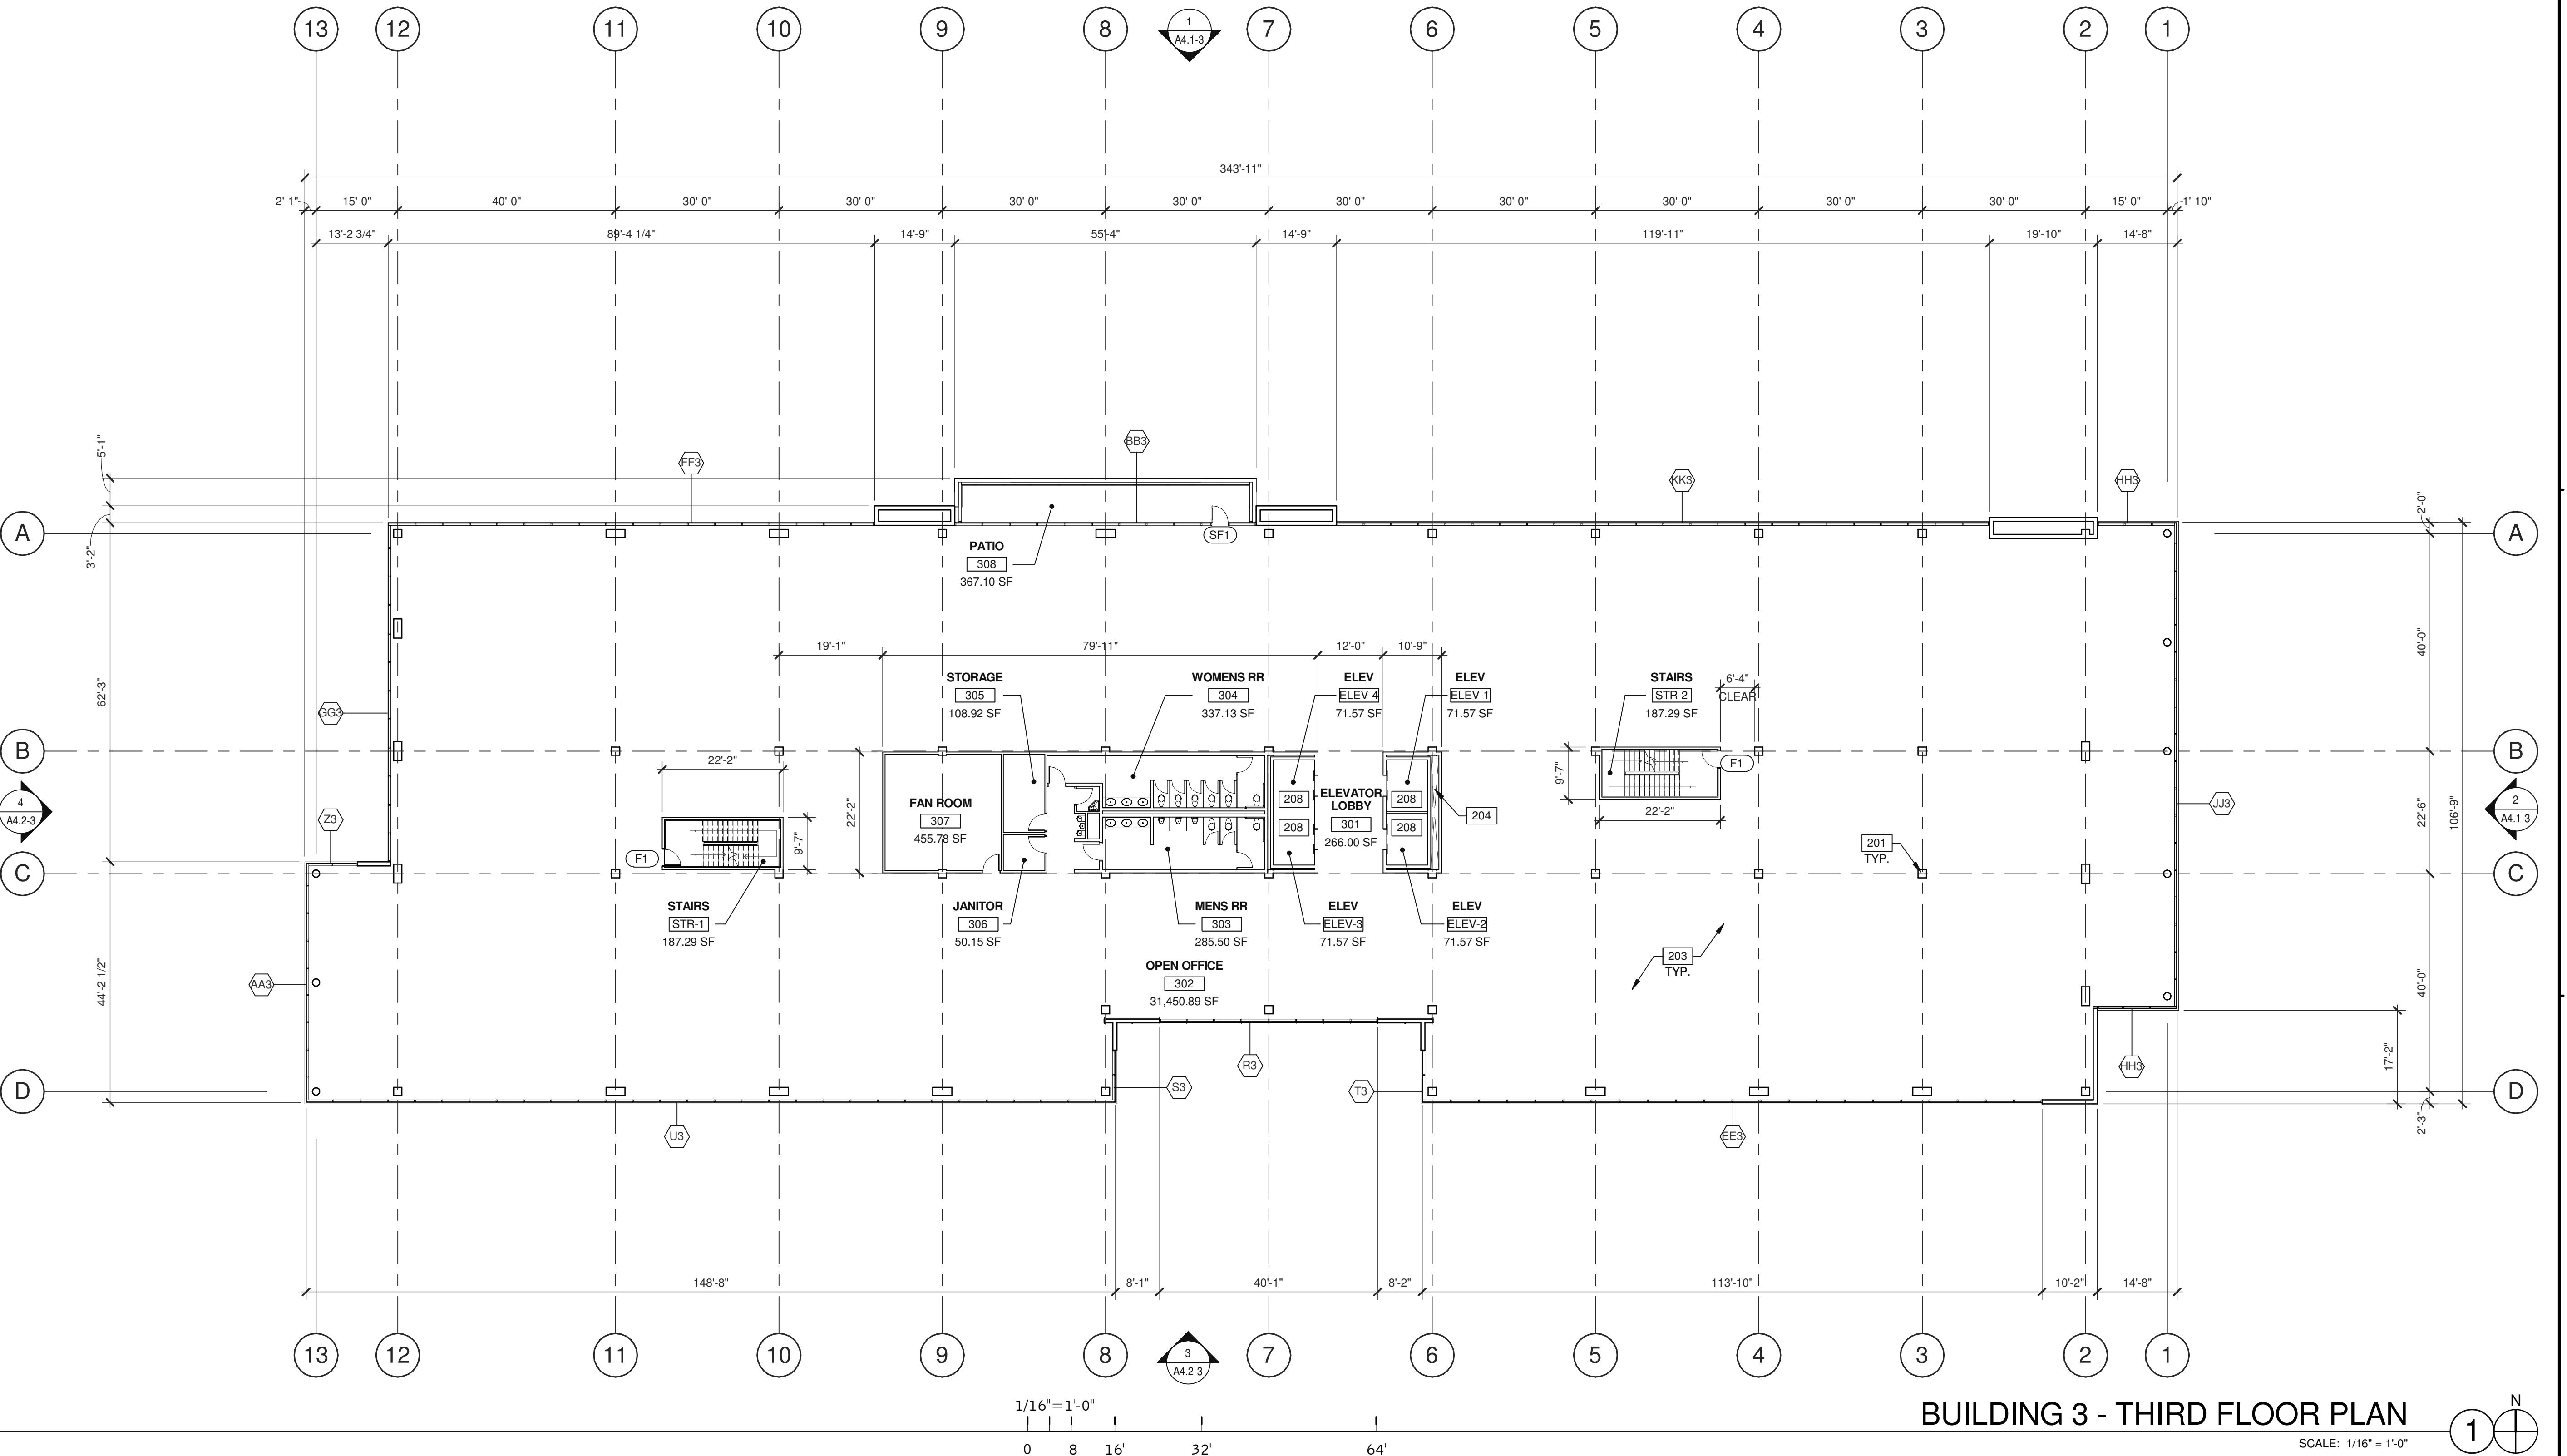

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<b>BUILDING 3 - THIRD FLOOR PLAN</b>	
DATE: 04/03/2019	REMARKS: PLANNING SUBMITTAL


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<b>A2.3-3</b>	
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**WALL LEGEND**

- CONCRETE WALL
- CONCRETE WALL WITH FURRING
- CONCRETE MASONRY WALL
- EXTERIOR PLASTER FINISH OVER METAL STUD WALL
- EXTERIOR ALUMINUM COMPOSITE METAL PANEL OVER METAL STUD WALL
- 1HR FIRE-RESISTANCE RATED
- INTERIOR NON-RATED PARTITION

**DOOR TYPES**



(SF1) 3'-0" x 8'-0" CLEAR ANOD. ALUM. STOREFRONT DOOR W/TEMPERED GLAZING (NARROW STILE)

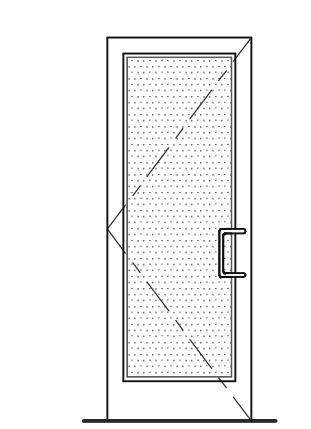(SF2) 6'-0" x 8'-0" (PAIR) CLEAR ANOD. ALUM. STOREFRONT DOOR W/TEMPERED GLAZING (NARROW STILE)

FRAME: MANUFACTURER

HARDWARE:  
2 SETS PIVOT SET  
2 SETS INTER PIVOT  
1 EA EXIT DEVICE  
1 EA CYLINDER  
2 SETS OFFSET PULL  
2 EA OH CLOSER  
1 EA THRESHOLD  
1 EA DECAL

NOTE: WEATHERSEAL BY DOOR MANUFACTURER

(F1) 3'-0" x 7'-0" PAINTED INSULATED HOLLOW METAL DOOR

(F2) 6'-0" x 7'-0" PAINTED INSULATED HOLLOW METAL DOOR

FRAME: PAINTED HOLLOW METAL

HARDWARE:  
3 EA HINGES  
1 EA EXIT DEVICE  
1 EA CYLINDER  
1 EA CLOSER  
1 EA PERIMETER SEAL  
1 EA BOTTOM DRIP  
1 EA THRESHOLD  
1 EA LOCK GUARD  
1 EA HVY DUTY FLOOR STOP

**NOTES**

- 201 STRUCTURAL COLUMN.
- 203 CONCRETE OVER METAL DECK FLOOR.
- 204 MECHANICAL SHAFT.
- 208 3500 LB TRACTION.

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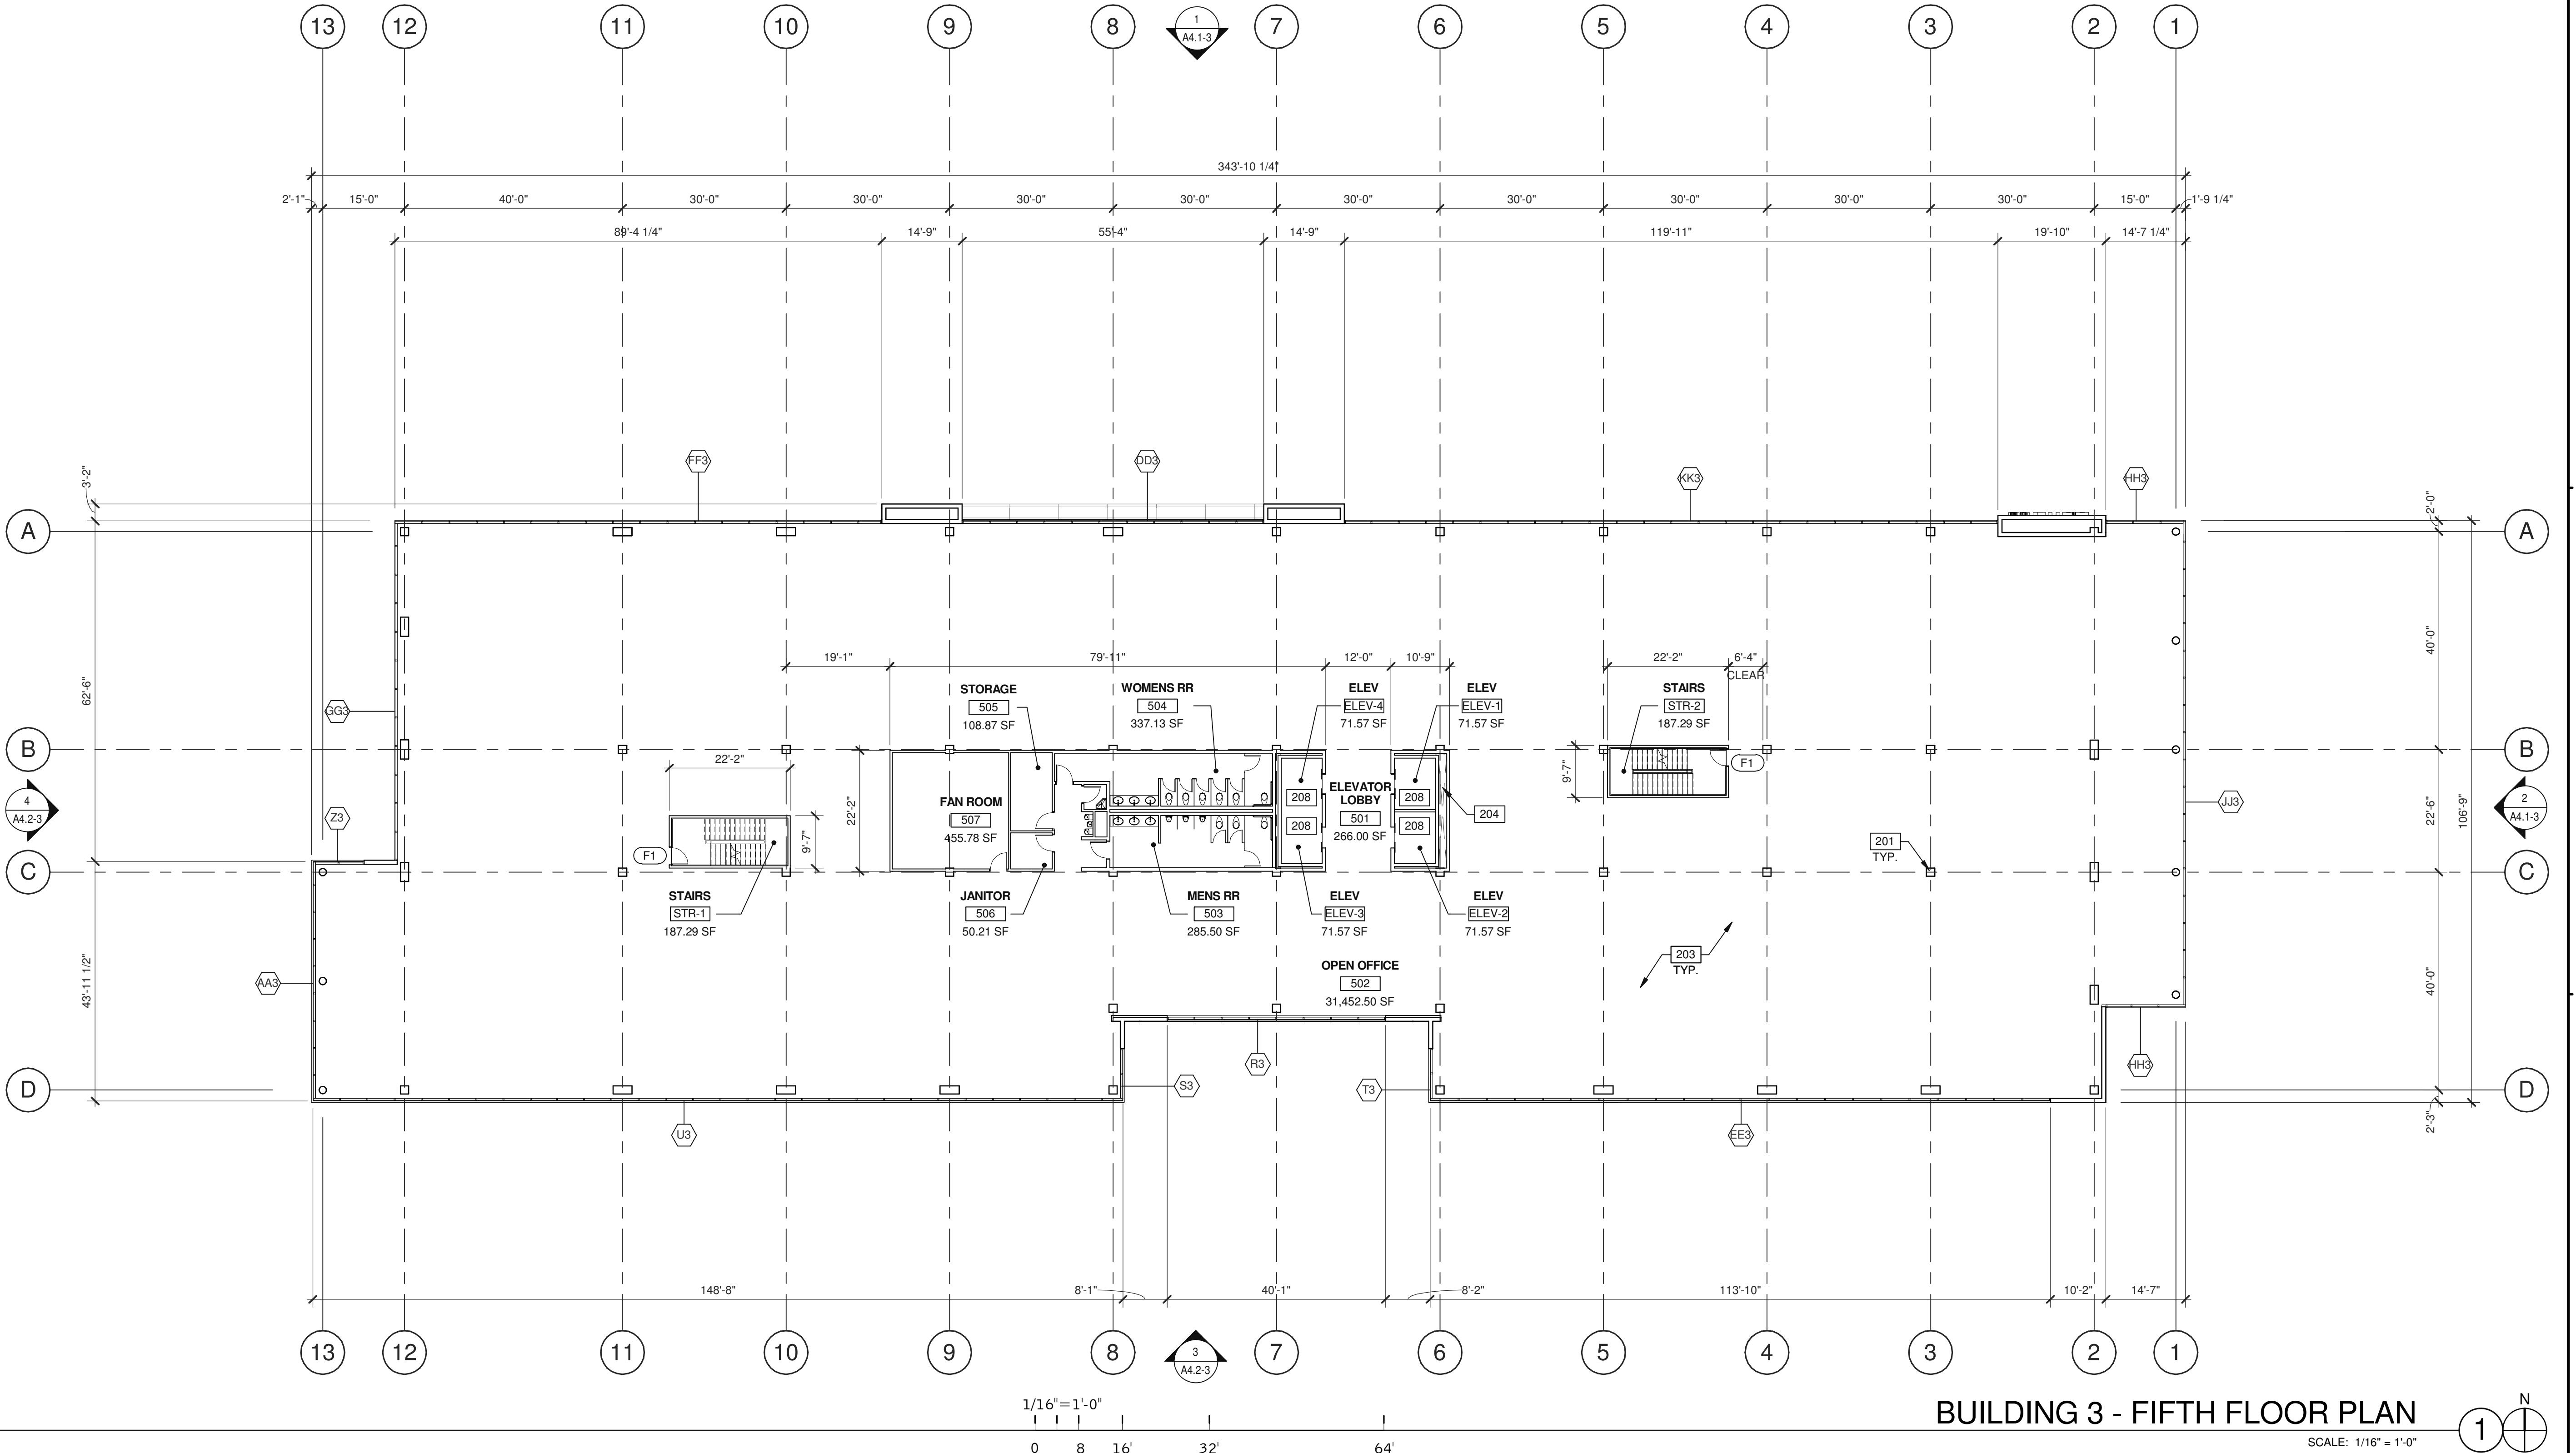
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BUILDING 3 - FIFTH FLOOR PLAN

SCALE: 1/16" = 1'-0"

## BUILDING 3 - FIFTH FLOOR PLAN

REF MARKS	
DATE	04/03/2019
1	PLANNING SUBMITTAL


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JOB NO.:	SNR17-0069-00

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A2.5-3

**WALL LEGEND**

- CONCRETE WALL
- CONCRETE WALL WITH FURRING
- CONCRETE MASONRY WALL
- EXTERIOR PLASTER FINISH OVER METAL STUD WALL
- EXTERIOR ALUMINUM COMPOSITE METAL PANEL OVER METAL STUD WALL
- 1HR FIRE-RESISTANCE RATED
- INTERIOR NON-RATED PARTITION

**DOOR TYPES**

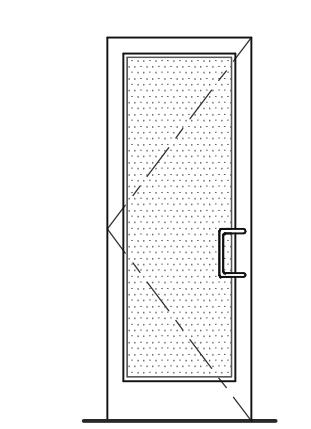(SF1) 3'-0" x 8'-0"  
CLEAR ANOD. ALUM. STOREFRONT  
DOOR W/TEMPERED GLAZING  
(NARROW STILE)

(SF2) 6'-0" x 8'-0" (PAIR)  
CLEAR ANOD. ALUM. STOREFRONT  
DOOR W/TEMPERED GLAZING  
(NARROW STILE)

FRAME: MANUFACTURER

HARDWARE:  
2 SETS PIVOT SET  
2 SETS INTER PIVOT  
1 EA EXIT DEVICE  
1 EA CYLINDER  
2 SETS OFFSET PULL  
2 EA OH CLOSER  
1 EA THRESHOLD  
1 EA DECAL

NOTE: WEATHERSEAL BY DOOR  
MANUFACTURER

(F1) 3'-0" x 7'-0"  
PAINTED INSULATED  
HOLLOW METAL DOOR

(F2) 6'-0" x 7'-0"  
PAINTED INSULATED  
HOLLOW METAL DOOR


FRAME: PAINTED HOLLOW METAL

HARDWARE:  
3 EA HINGES  
1 EA EXIT DEVICE  
1 EA CYLINDER  
1 EA CLOSER  
1 EA PERIMETER SEAL  
1 EA BOTTOM Drip  
1 EA THRESHOLD  
1 EA LOCK GUARD  
1 EA HVY DUTY FLOOR STOP

**NOTES**

- 201 STRUCTURAL COLUMN.  
203 CONCRETE OVER METAL DECK FLOOR.  
204 MECHANICAL SHAFT.  
208 3500 LB TRACTION.

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**ABBREVIATIONS**

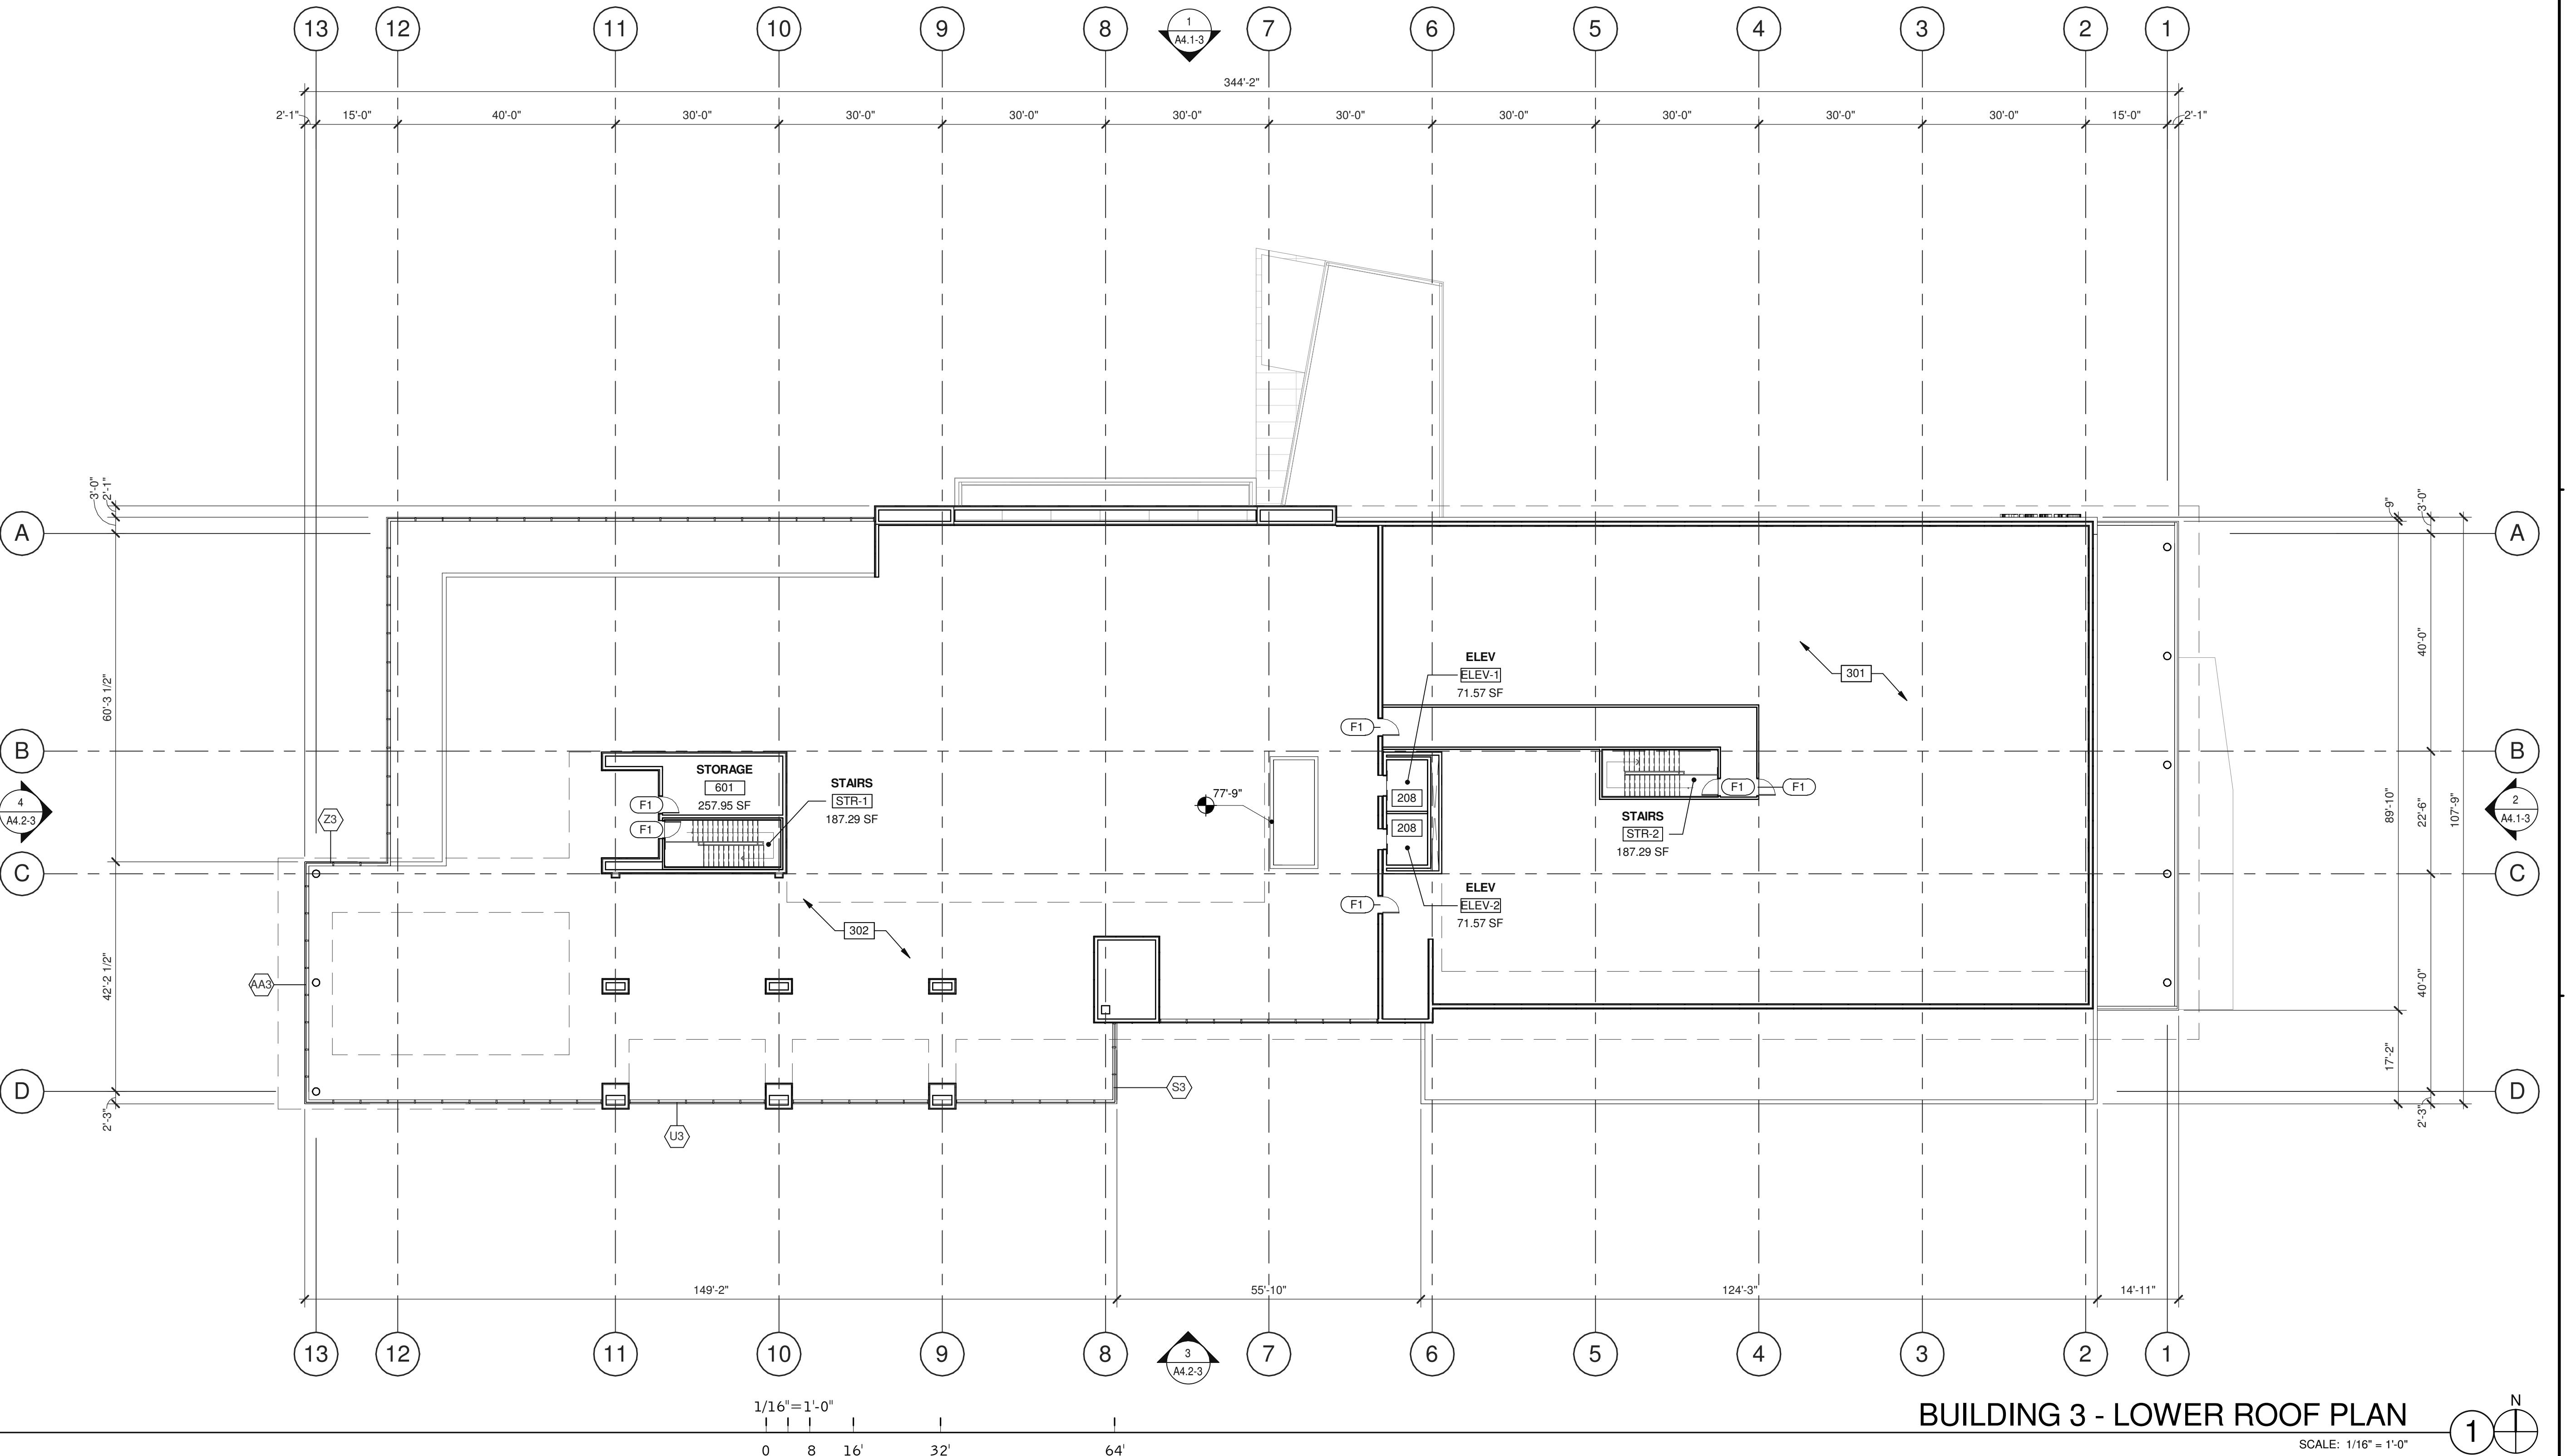T.O.P.	= TOP OF PARAPET
H.P.	= TOP OF ROOFING - HIGH POINT
M.P.	= TOP OF ROOFING - MID POINT
L.P.	= TOP OF ROOFING - LOW POINT

**NOTES**

- 208 3500 LB TRACTION,  
301 SINGLE-PLY ROOFING OVER RIGID INSULATION OVER METAL DECK.  
302 VEGETATED ROOF REFER TO LANDSCAPE SHEET L1.8.

**BUILDING 3 - LOWER ROOF PLAN**

DATE	04/03/2019
REMARKS	PLANNING SUBMITTAL

P/A/P/M:	J. BABINE
DRAWN BY::	E.S.
JOB NO.:	SNR17-0069-00

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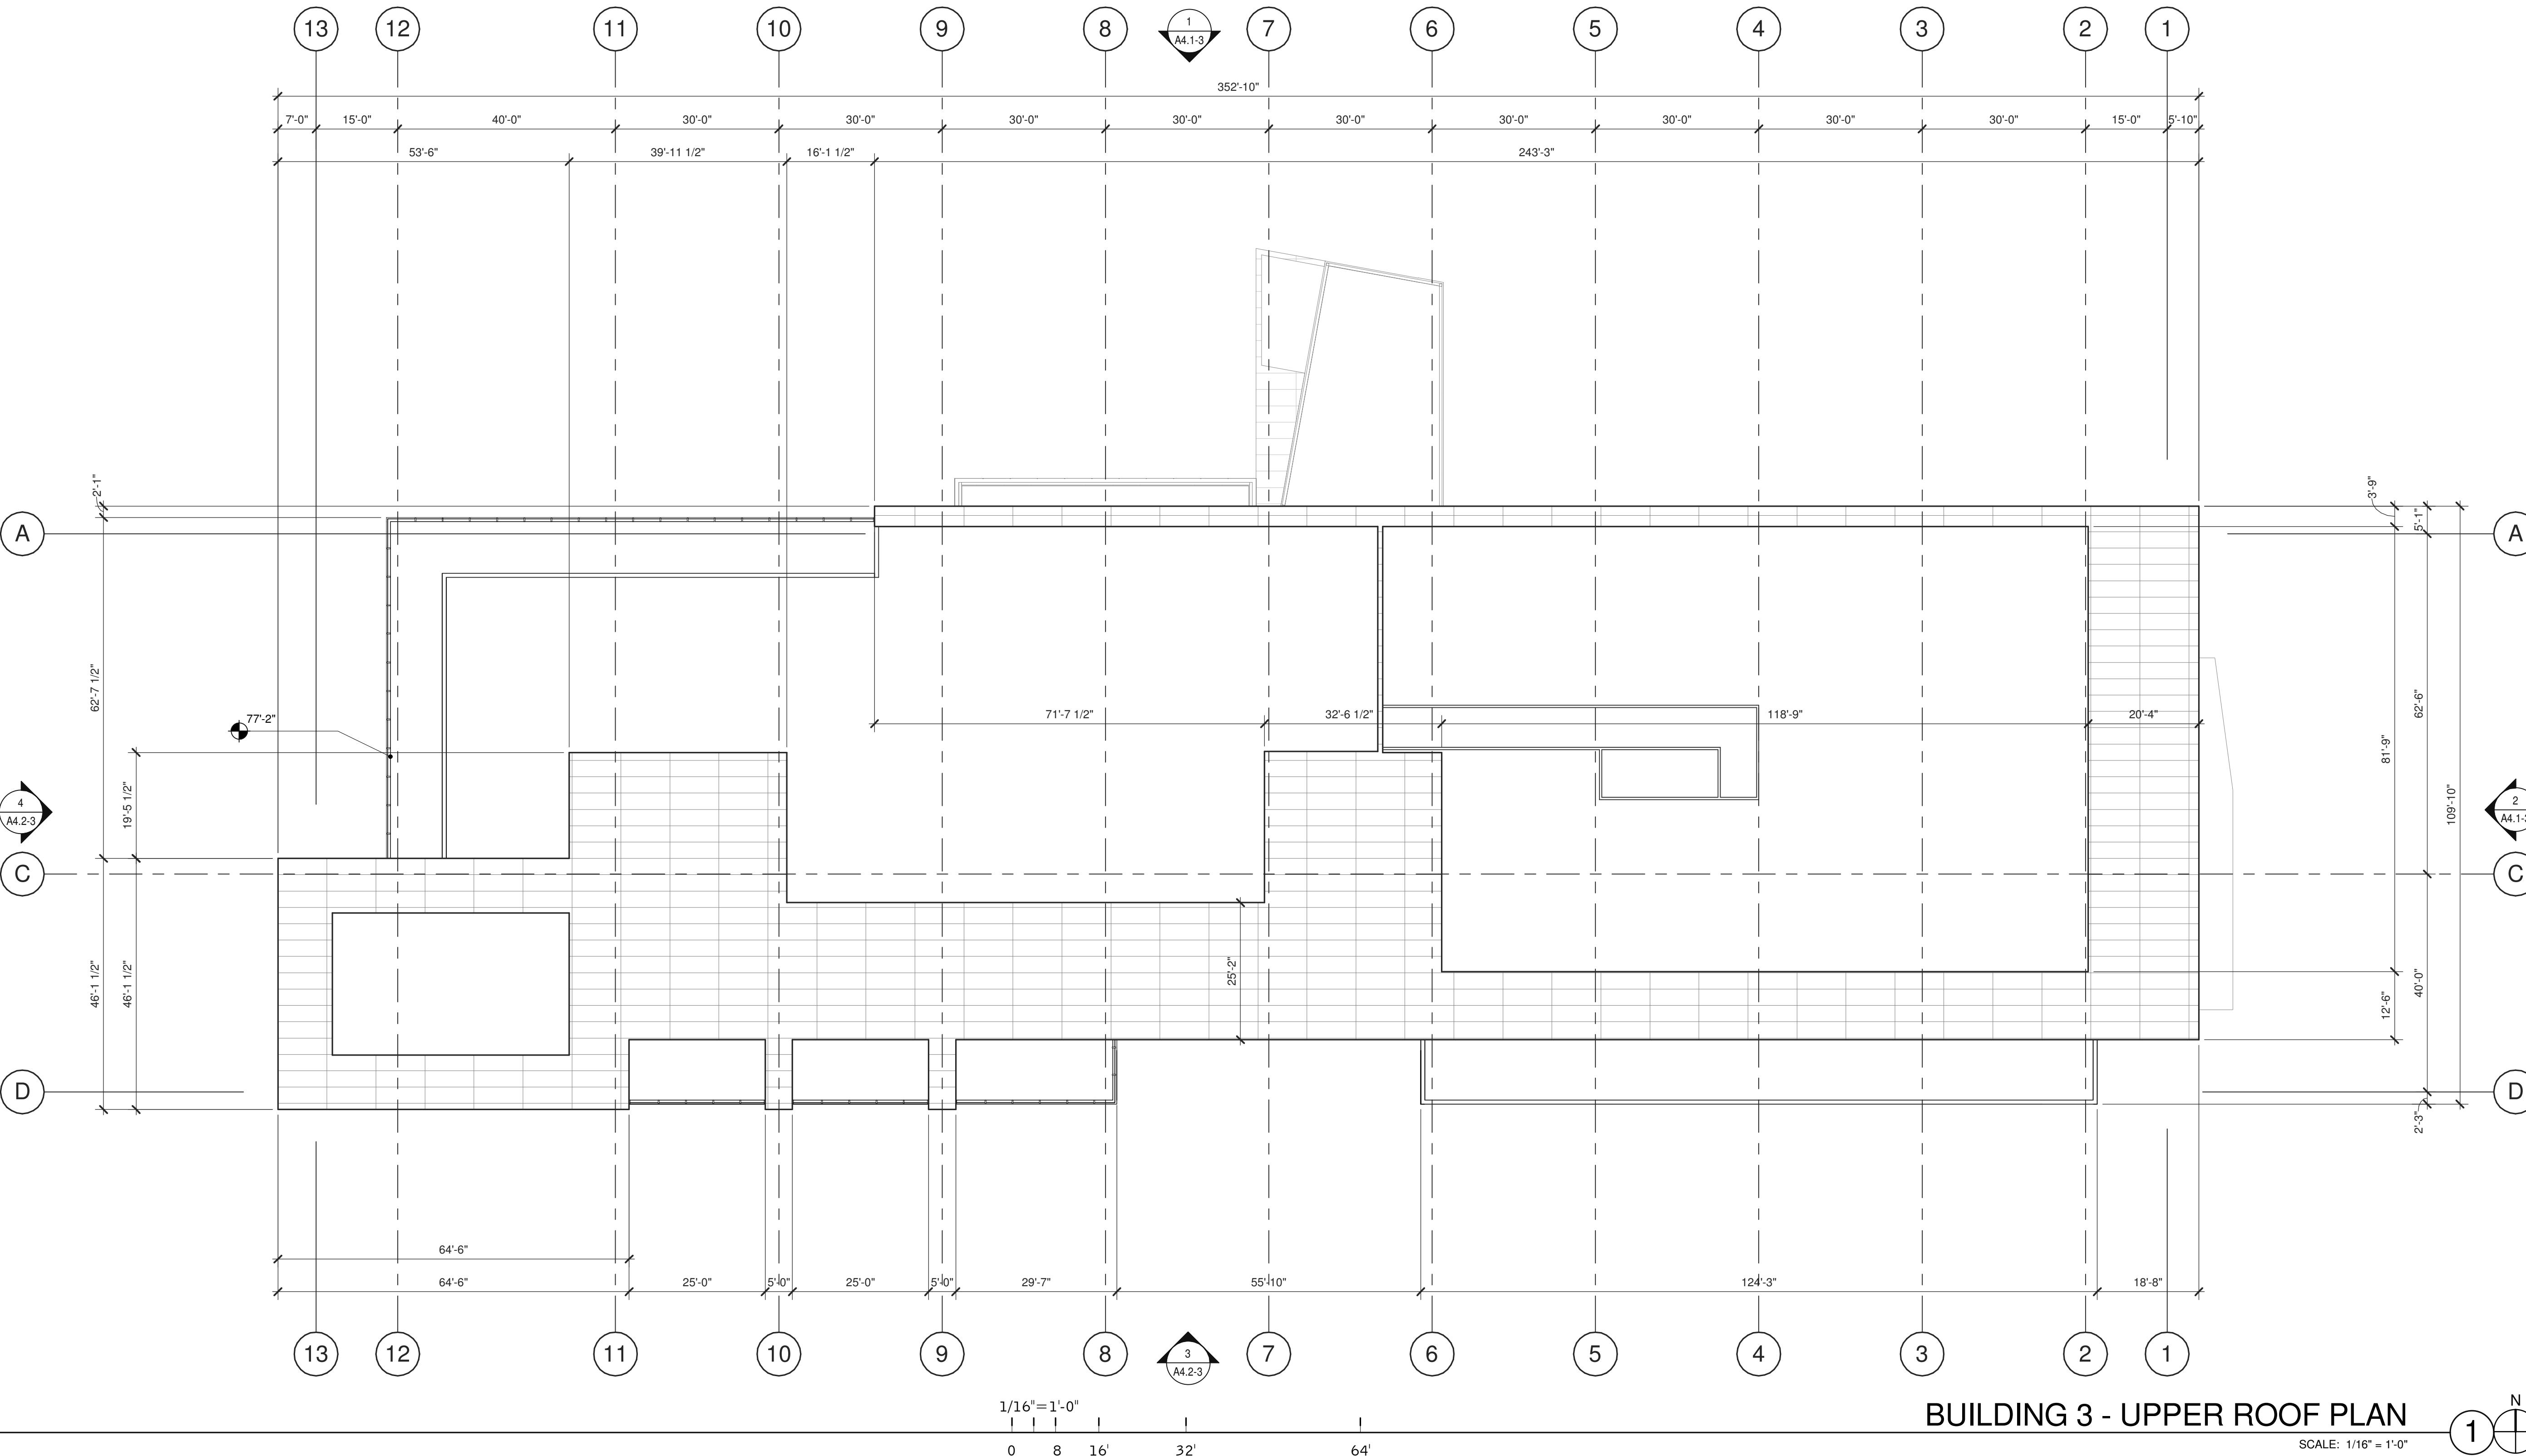
A3.1-3

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**ABBREVIATIONS**

T.O.P.	= TOP OF PARAPET
H.P.	= TOP OF ROOFING - HIGH POINT
M.P.	= TOP OF ROOFING - MID POINT
L.P.	= TOP OF ROOFING - LOW POINT

**NOTES****MATERIALS:**

WHITE PORCELAIN TILE RAIN SCREEN SYSTEM OVER CONCRETE WALL

**BUILDING 3 - UPPER ROOF PLAN**

REMARKS

PLANNING SUBMITTAL

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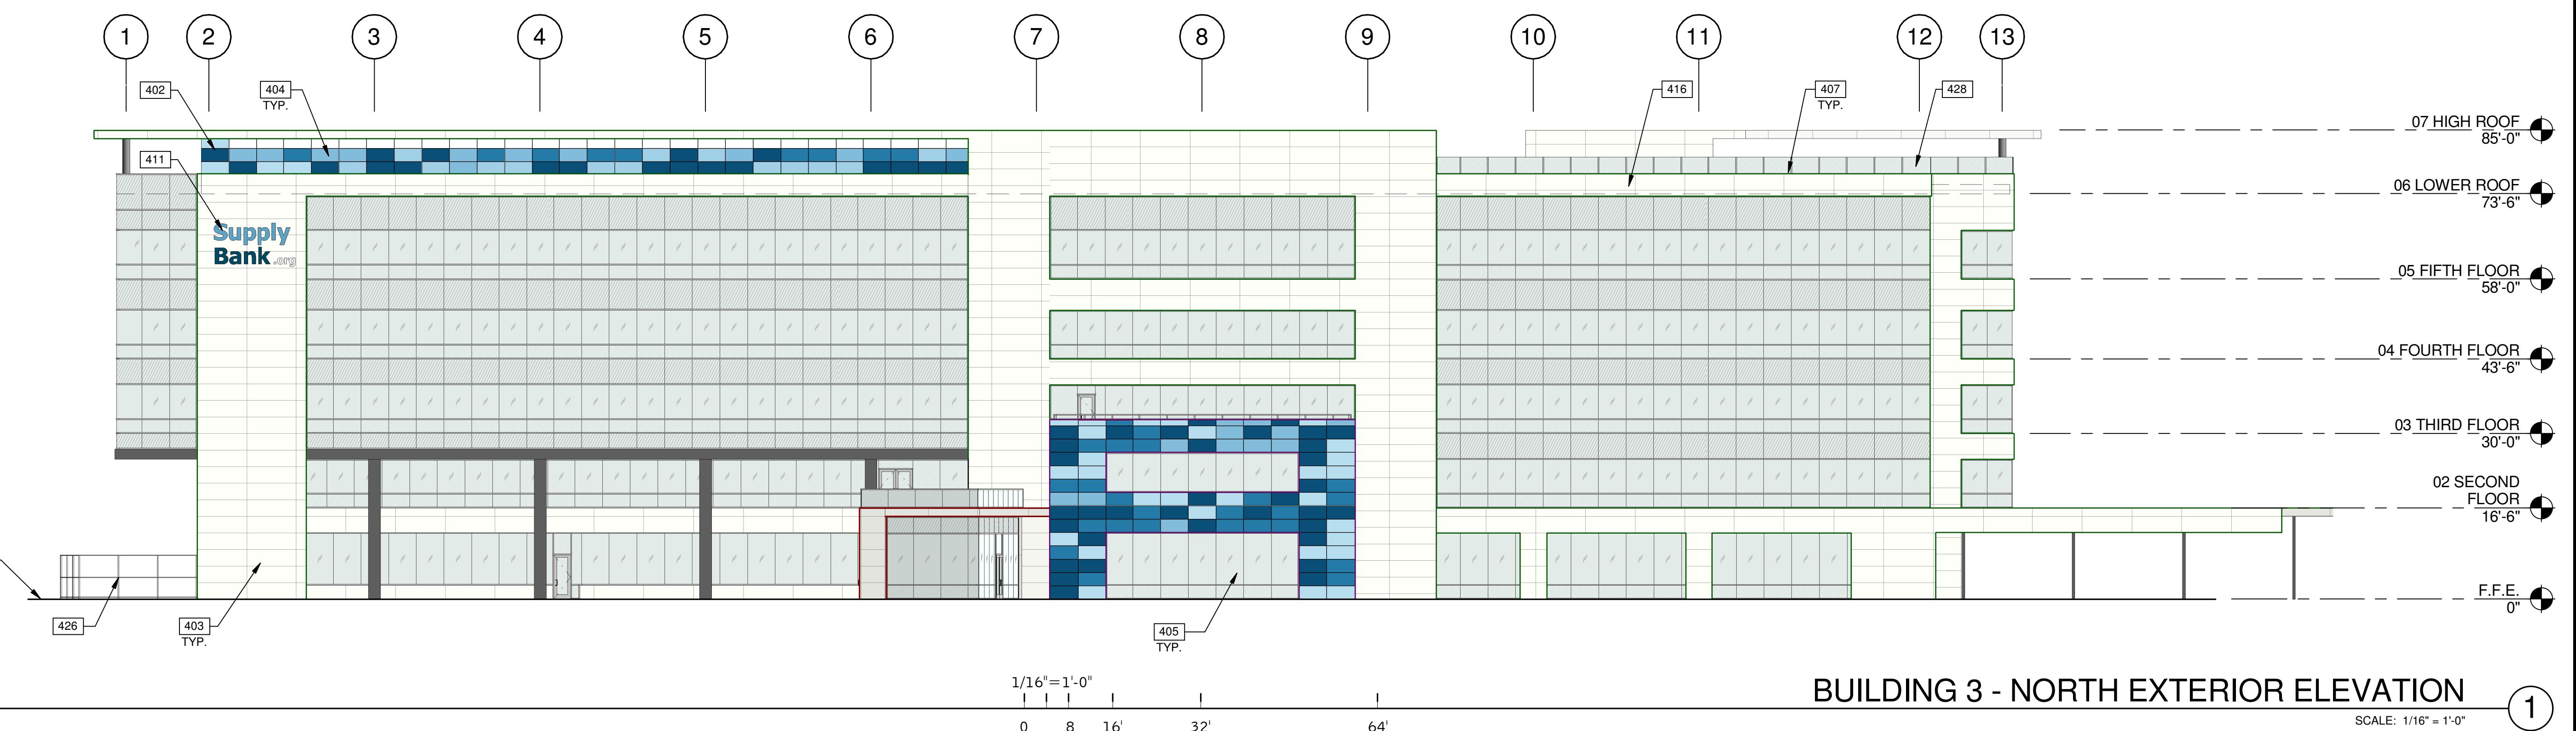
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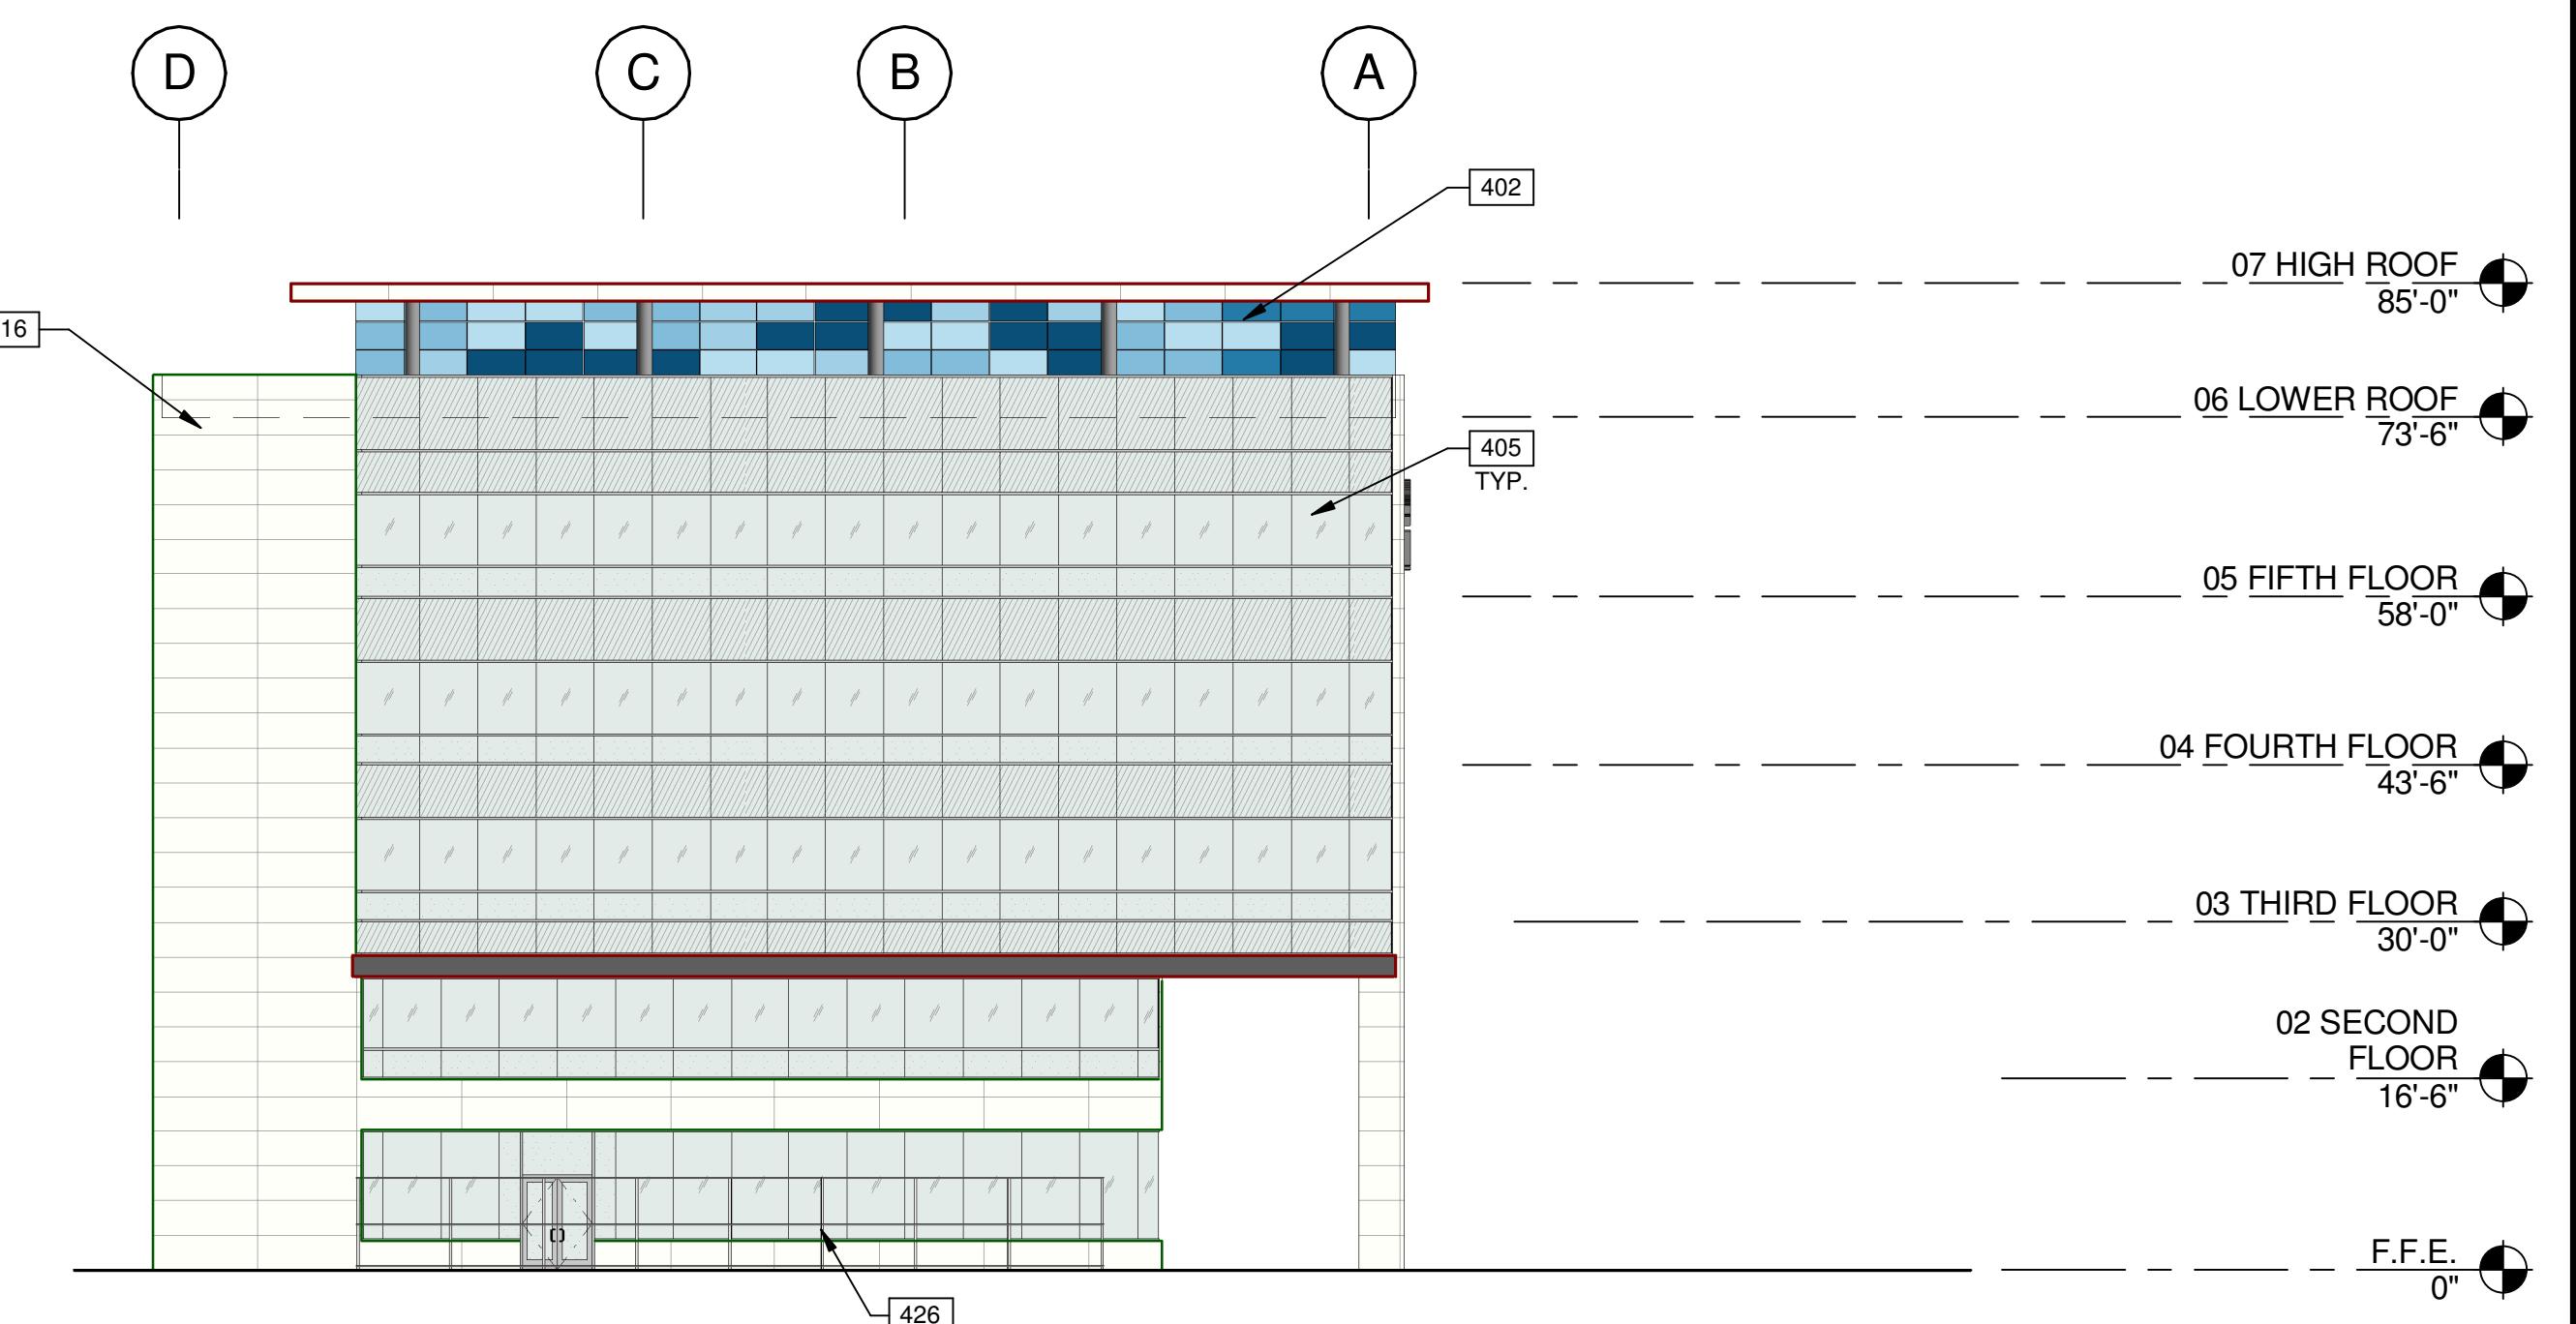
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BUILDING 3 - NORTH EXTERIOR ELEVATION

SCALE: 1/16" = 1'-0"




BUILDING 3 - EAST EXTERIOR ELEVATION

SCALE: 1/16" = 1'-0"

## LEGEND

## MATERIALS:

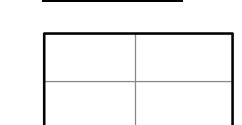


WHITE PORCELAIN TILE RAIN SCREEN SYSTEM OVER CONCRETE WALL


## GLASS:



VISION GLASS

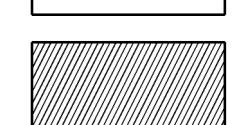

SPANDEL GLASS

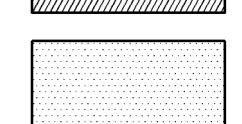

TEMPERED GLASS

ALL GLASS USED ON THE ENVELOPE OF THE BUILDING TO BE:  
 20 ULTRACLEAR LOW IRON FLOAT GLASS  
 23 GUARDING CRYSTALBLUE FLOAT GLASS (1" INSULATED ON CLEAR/SPANDEL WHERE INDICATED)  
 SUNGUARD SPANDEL HT - WARM GRAY  
 GLASS WIND LOAD RESISTANCE CALCULATIONS ARE UNDER SEPARATE PERMIT  
 MULLION FINISH:  
 KAWNEER CLEAR NO. 14 AND NO. 17 (OR COMPARABLE)

## COLORS:

402

PRE-FINISHED ALUMINUM COMPOSITE METAL PANEL OVER METAL STUD FRAMING.

403

EXTERIOR PORCELAIN TILE RAINSCREEN.

404

ALUMINUM WALL JOINT.

405

ALUMINUM STOREFRONT SYSTEM WITH 1" INSULATED GLASS.

407

CONTINUOUS METAL CAP TO MATCH BUILDING COLOR.

411

SIGNAGE, UNDER SEPARATE PERMIT.

415

FINISH GRADE VARIES.

416

LINE OF ROOF BEYOND.

426

TRELLIS.

428

PAINTED MURAL - BY OTHERS.

## NOTES

REMARKS

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DATE

04/03/2019

1

JOB NO.

SNR17-0069-00

PA/PM:

J. BABINE

DRAWN BY:

E.S.

JOB NO.:

SNR17-0069-00

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A4.1-3

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BUILDING 3 - EXTERIOR ELEVATIONS

REMARKS

PLANNING SUBMITTAL

DATE

04/03/2019

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JOB NO.


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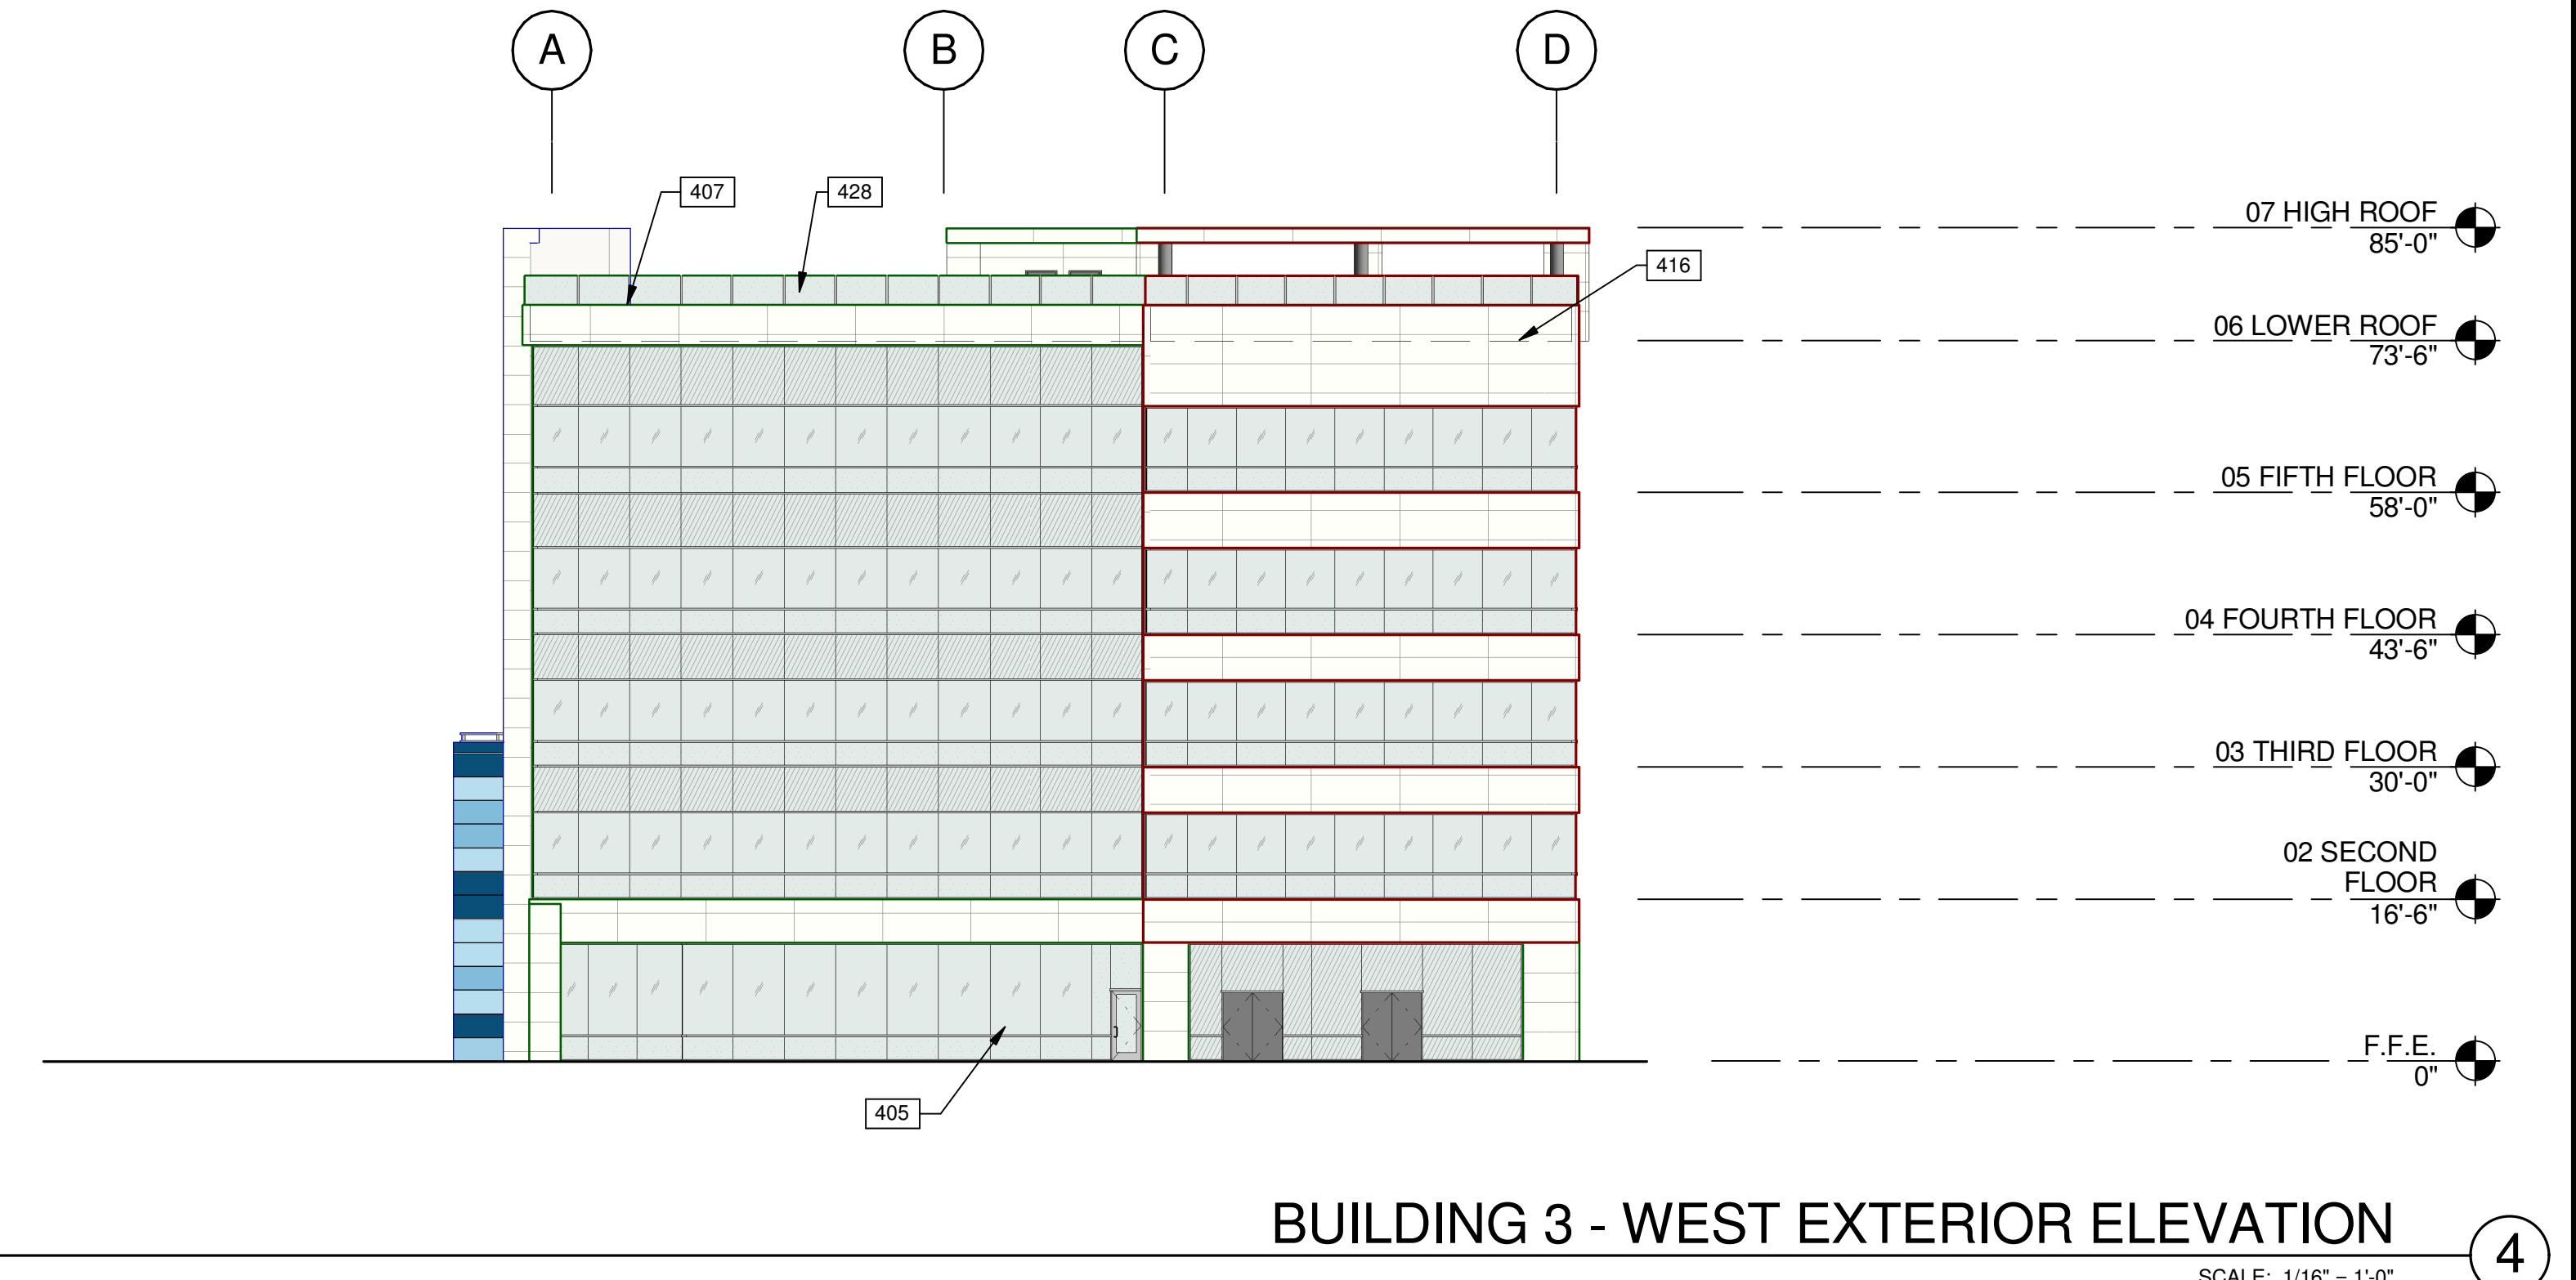
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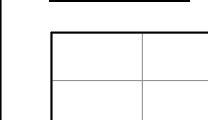
BUILDING 3 - EXTERIOR ELEVATIONS	
DATE	REMARKS
04/03/2019	PLANNING SUBMITTAL
1	

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DRAWN BY:	E.S.
JOB NO.:	SNR17-0069-00

SHEET	A4.2-3
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### LEGEND

#### MATERIALS:

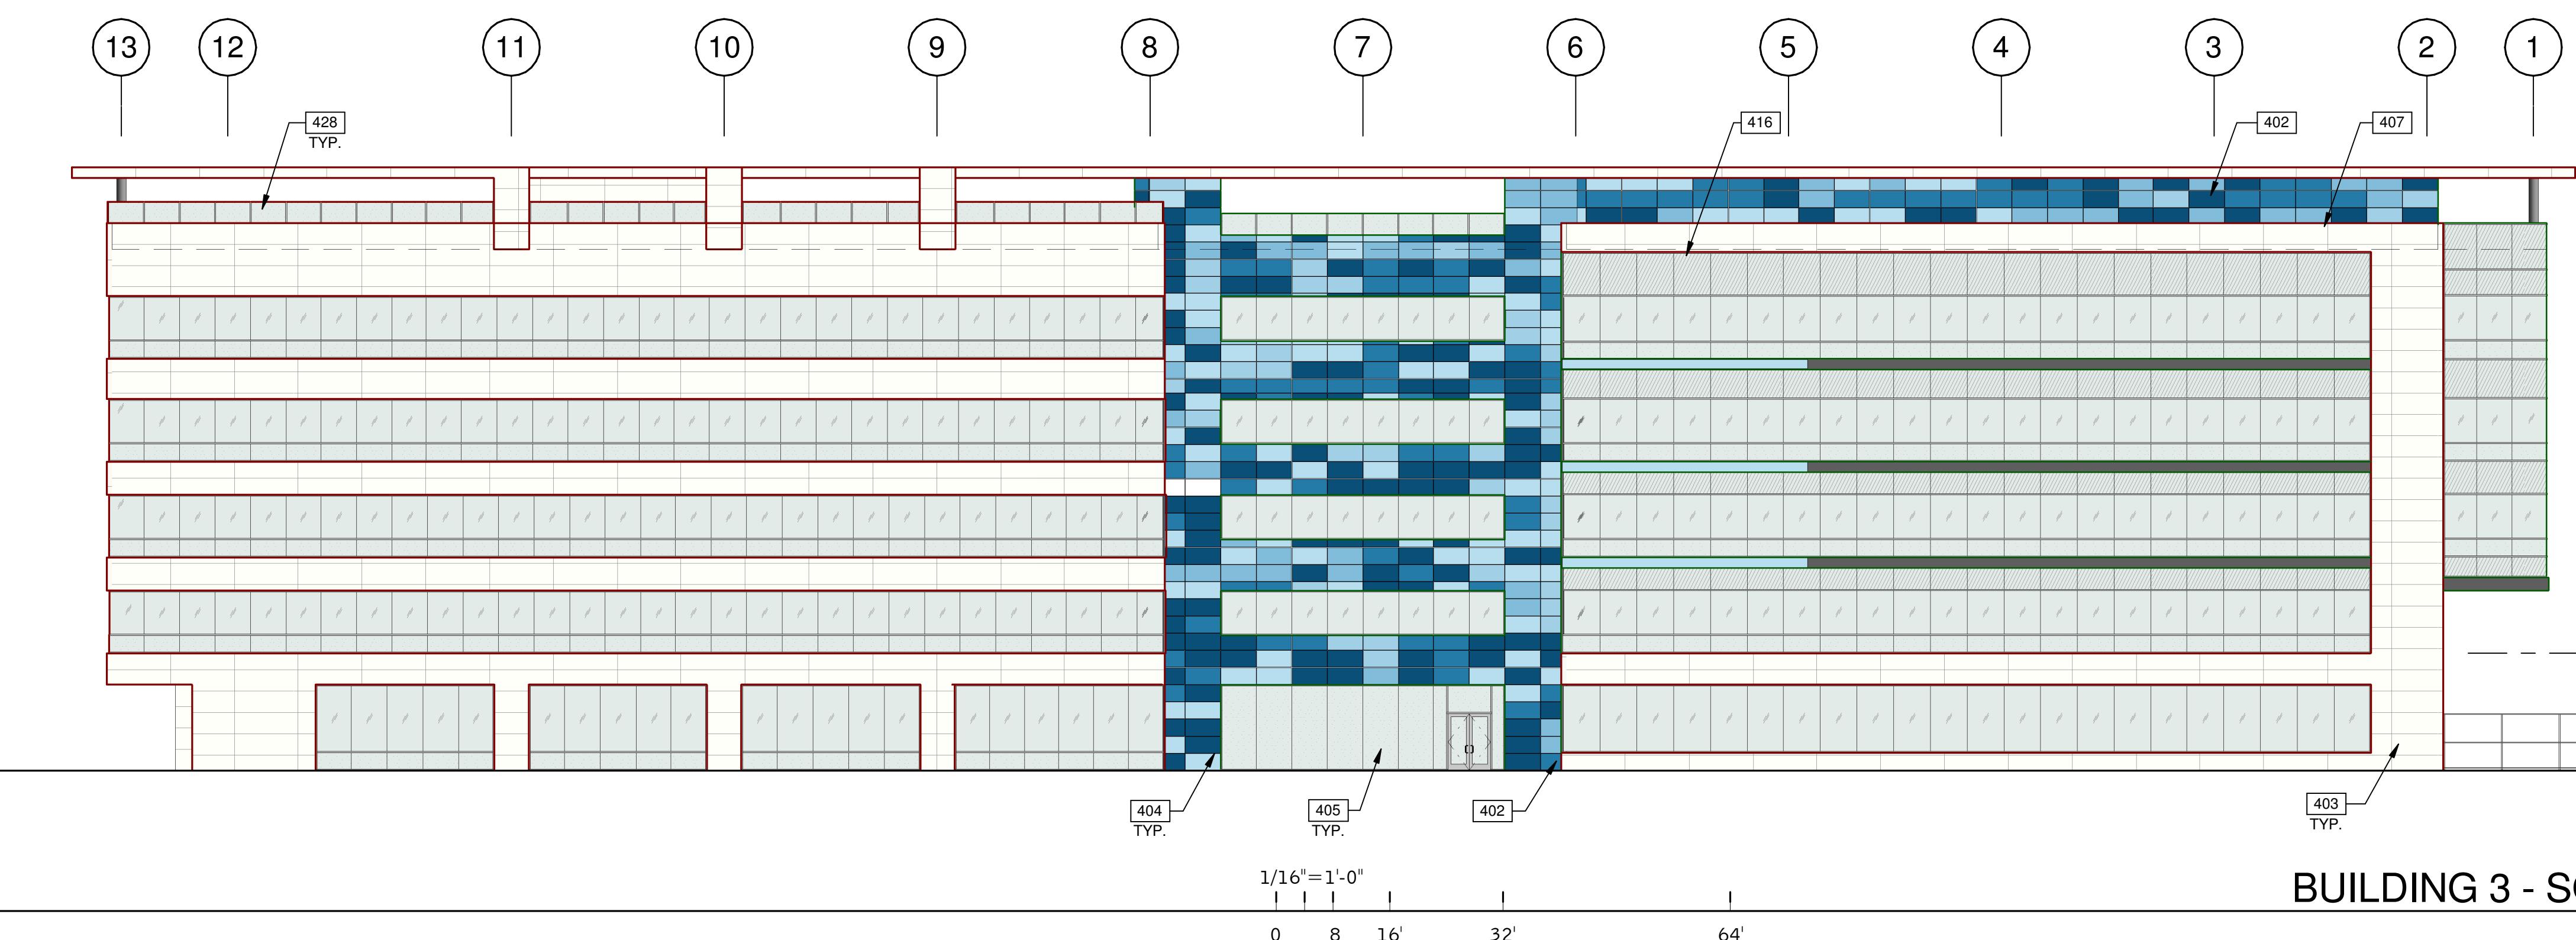


WHITE PORCELAIN TILE RAIN SCREEN SYSTEM OVER CONCRETE WALL


#### Glass:



VISION GLASS

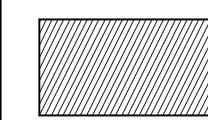

SPANDREL GLASS

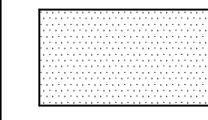


TEMPERED GLASS

ALL GLASS USED ON THE ENVELOPE OF THE BUILDING TO BE:  
20 ULTRACLEAR LOW IRON FLOAT GLASS  
23 GUARDING CRYSTALBLUE FLOAT GLASS (1" INSULATED ON CLEAR/SPANDREL WHERE INDICATED)  
SUNGUARD SPANDREL HT - WARM GRAY  
GLASS WIND LOAD RESISTANCE CALCULATIONS ARE UNDER SEPARATE PERMIT

MULLION FINISH:  
KAWNEER CLEAR NO. 14 AND NO. 17 (OR COMPARABLE)


#### COLORS:

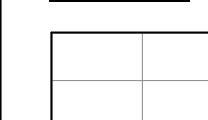

BASE COLOR: SHERWIN WILLIAMS SW 7674 PEPPERCORN



ACCENT COLOR: SHERWIN WILLIAMS SW 6800 SOMETHING BLUE

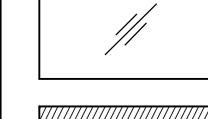


ACCENT COLOR: SHERWIN WILLIAMS SW 9063 PORCH CEILING




ACCENT COLOR: SHERWIN WILLIAMS SW 6801 REGALE BLUE




ACCENT COLOR: SHERWIN WILLIAMS SW 6803 DANUBE

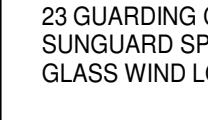

ACCENT COLOR: SHERWIN WILLIAMS SW 6804 DIGNITY BLUE

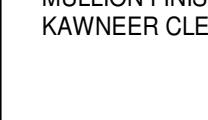

ACCENT/SIGNAGE COLOR: SHERWIN WILLIAMS SW 6802 JACARANDA

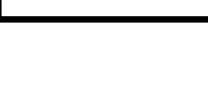






ACCENT/SIGNAGE COLOR: SHERWIN WILLIAMS SW 6510 LOYAL BLUE

### NOTES

- 402 PRE-FINISHED ALUMINUM COMPOSITE METAL PANEL OVER METAL STUD FRAMING.
- 403 EXTERIOR PORCELAIN TILE RAINSCREEN.
- 404 ALUMINUM WALL JOINT.
- 405 ALUMINUM STOREFRONT SYSTEM WITH 1" INSULATED GLASS.
- 407 CONTINUOUS METAL CAP TO MATCH BUILDING COLOR.
- 415 FINISH GRADE VARIES.
- 416 LINE OF ROOF BEYOND.
- 428 PAINTED MURAL - BY OTHERS.

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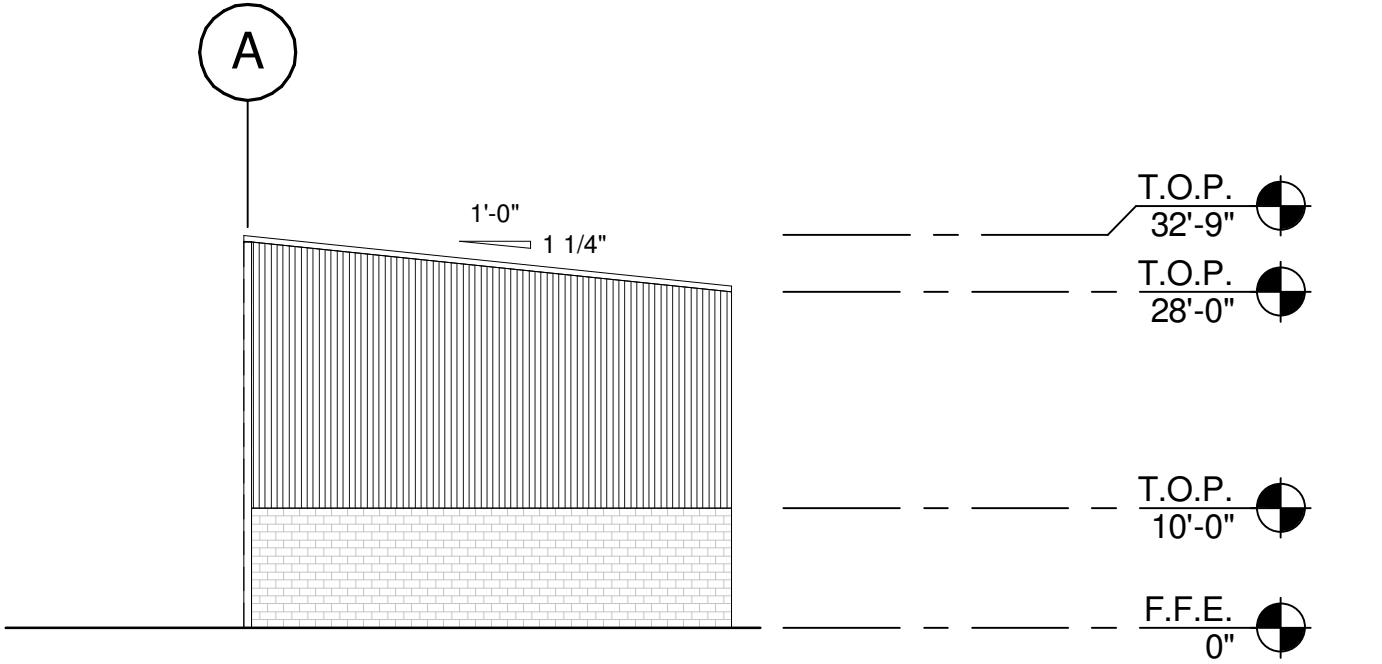
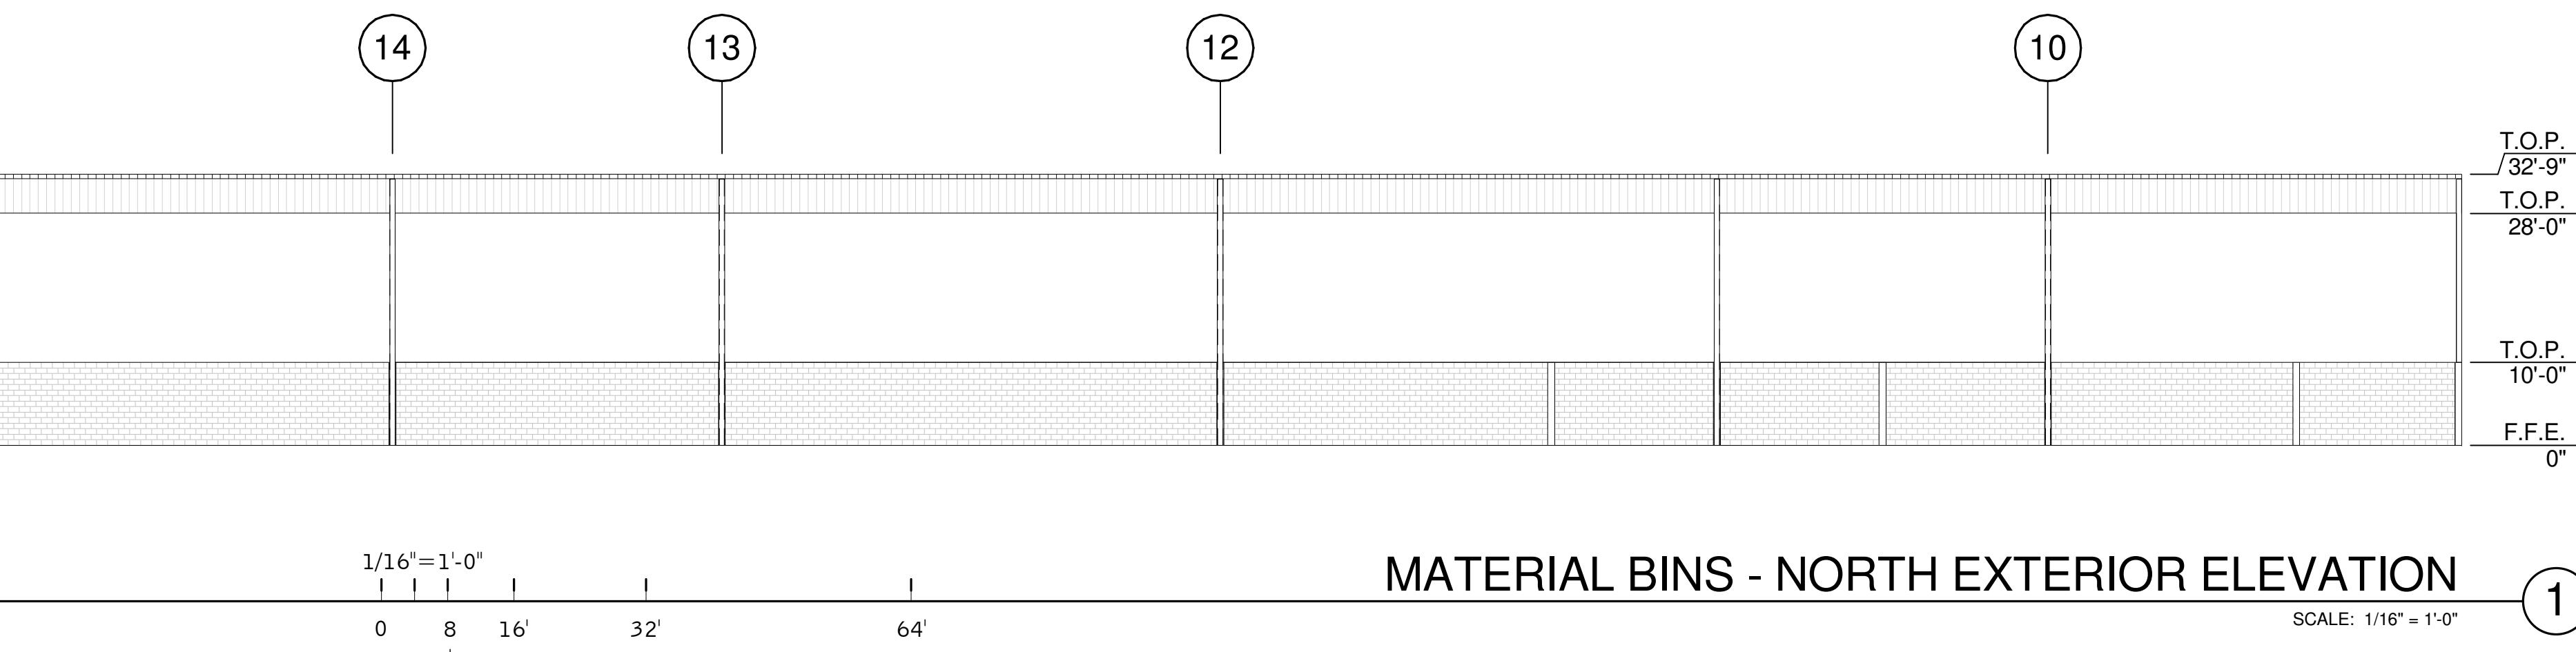
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PIPE LAYDOWN EXTERIOR ELEVATIONS	
DATE	REMARKS
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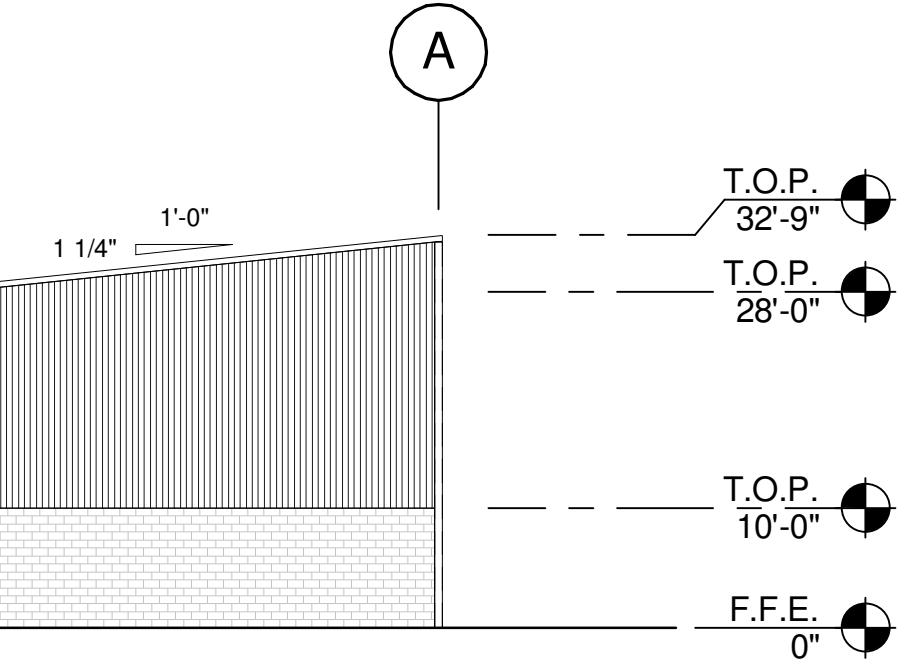
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**A4.1-5**

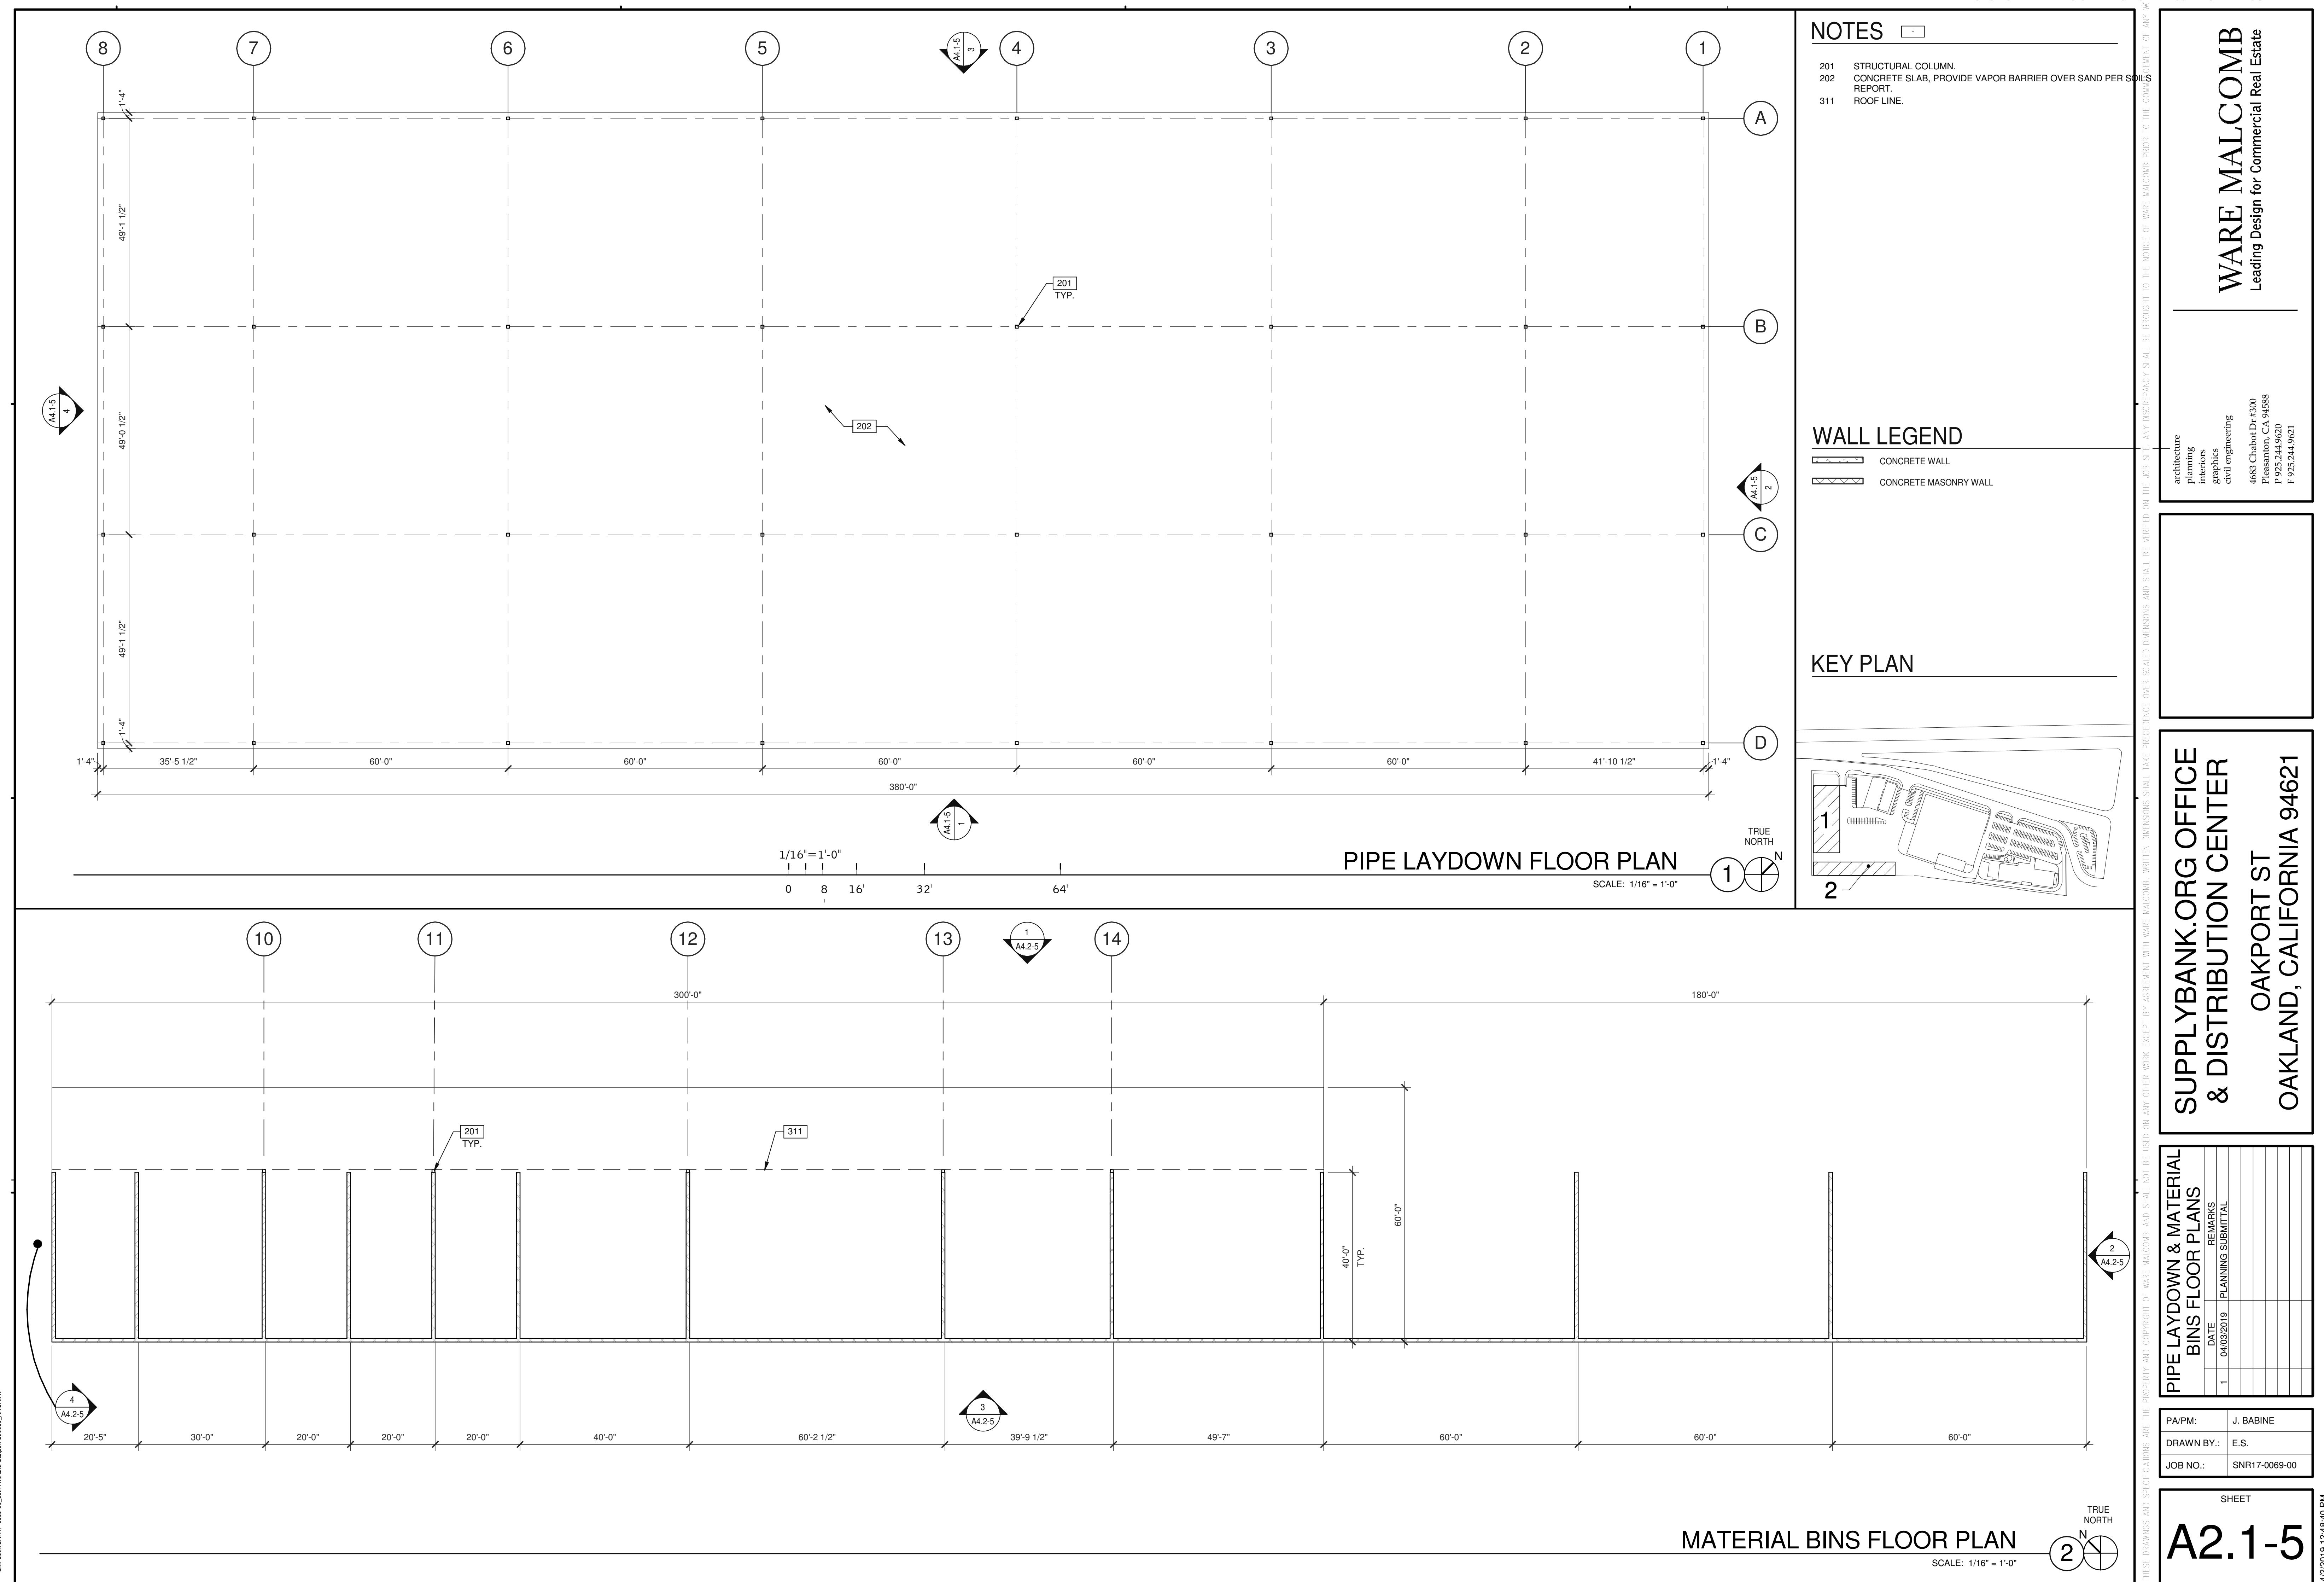

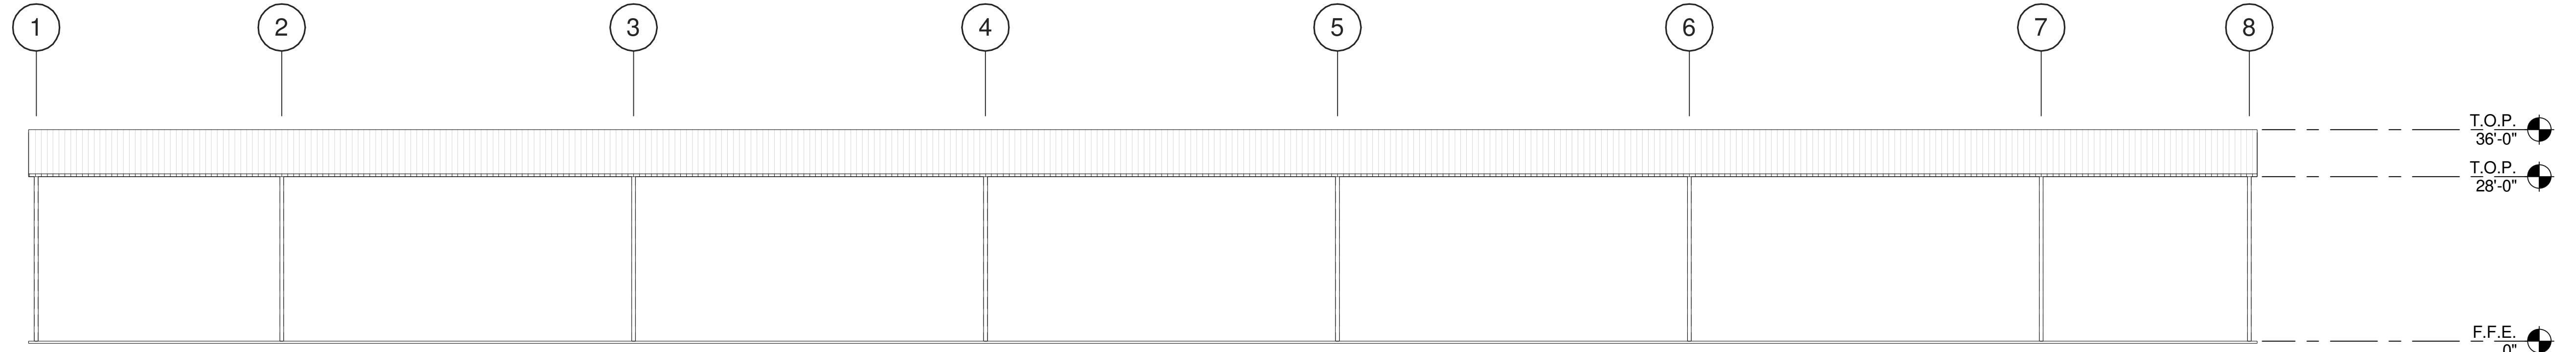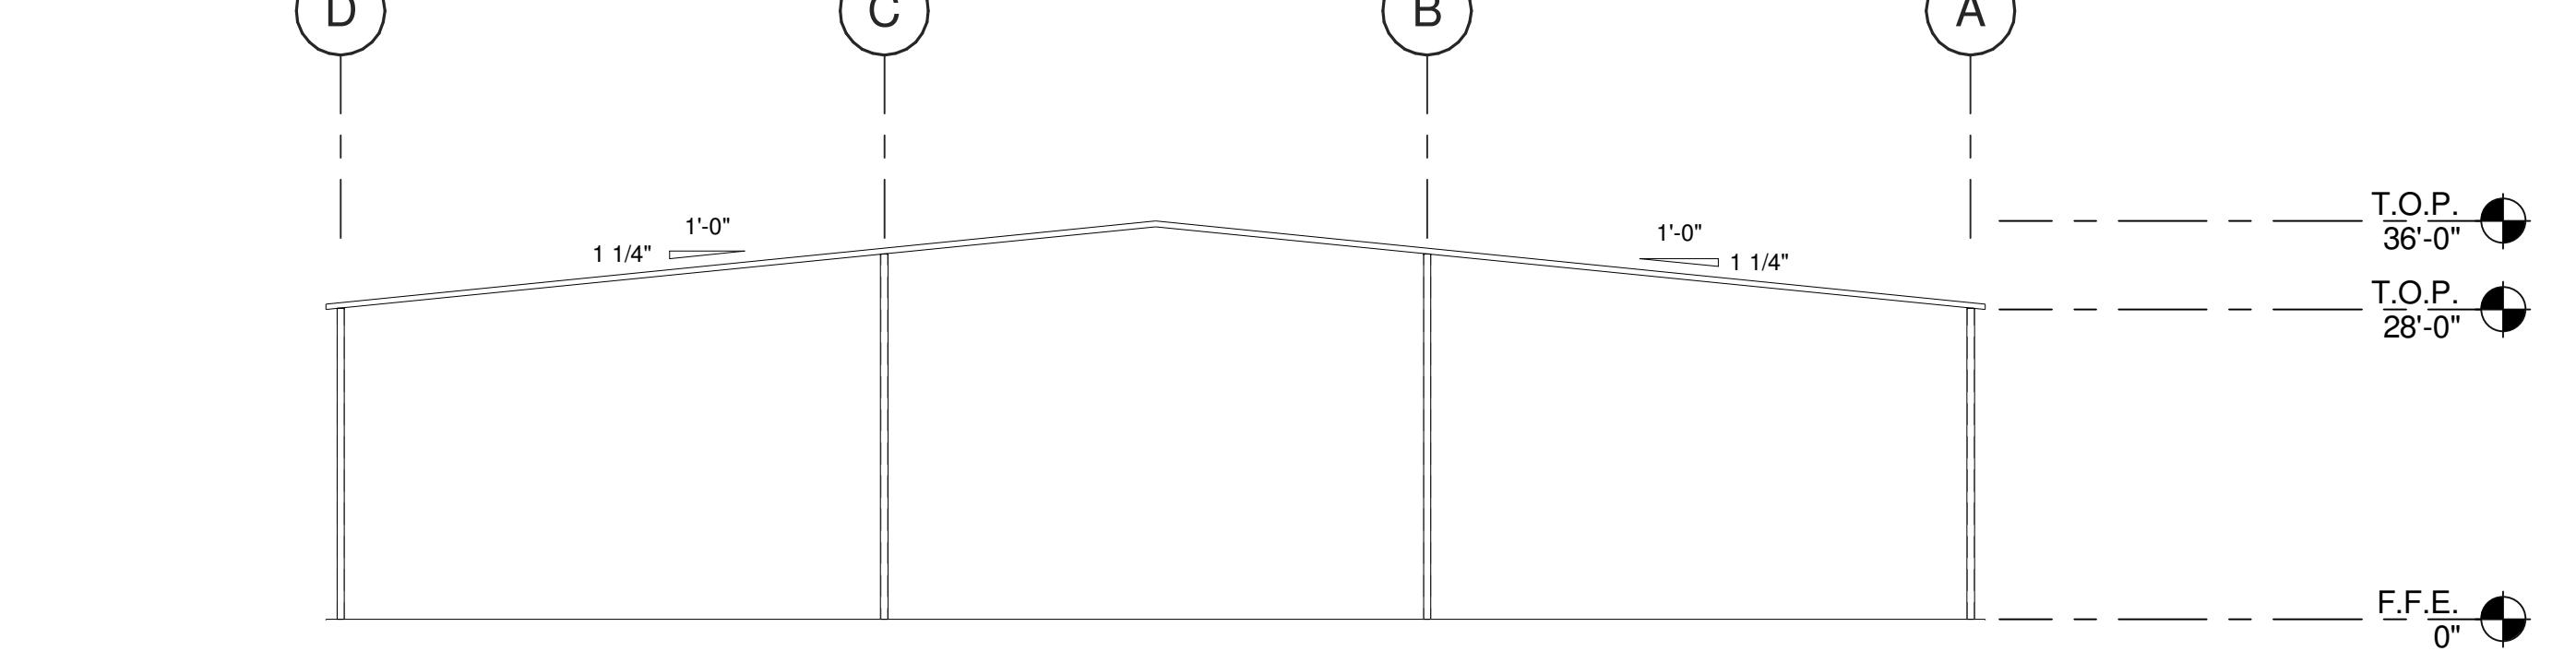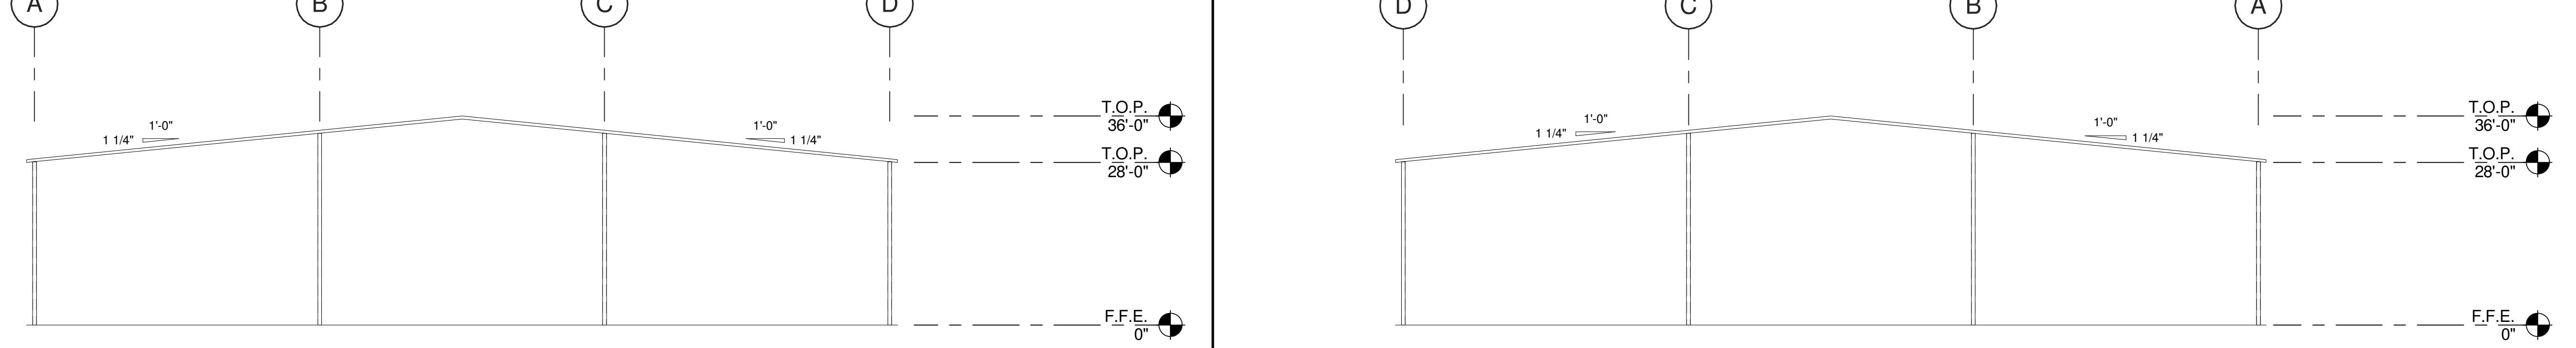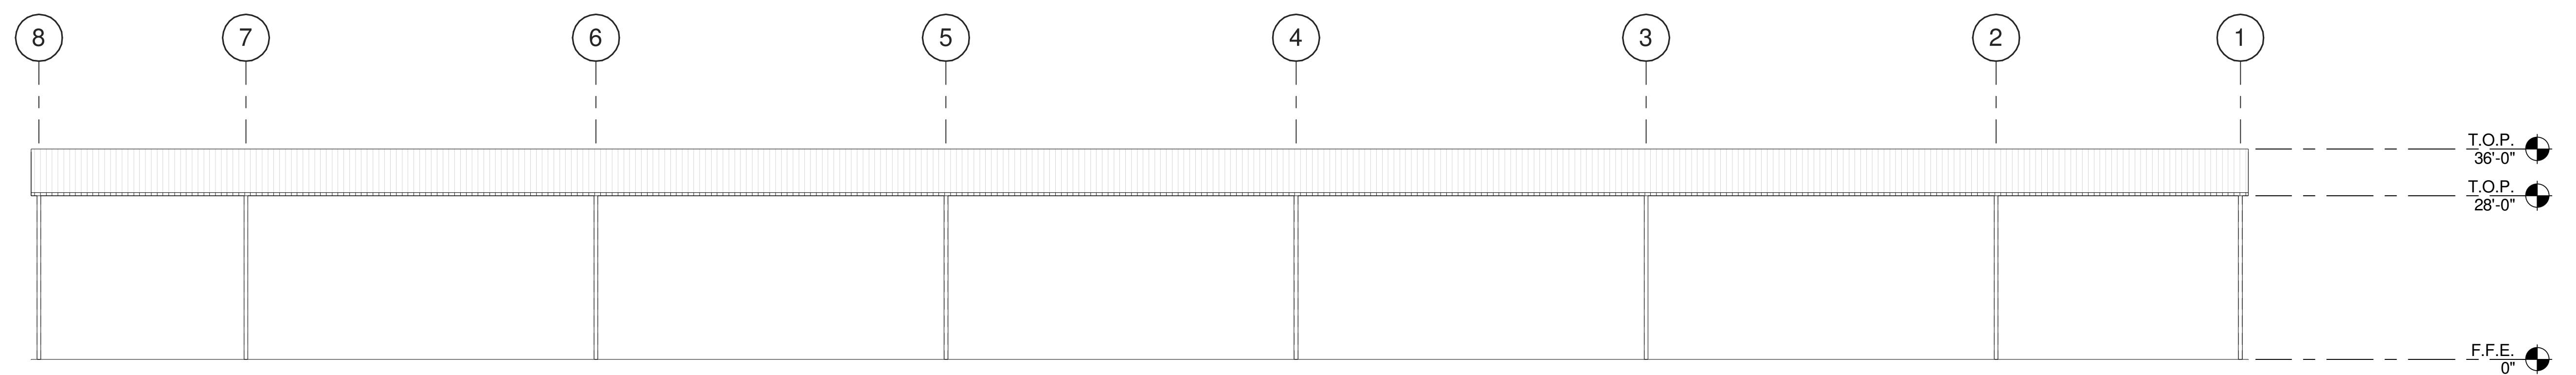
MATERIAL BINS - WEST EXTERIOR ELEVATION

SCALE: 1/16" = 1'-0"





MATERIAL BINS - EAST EXTERIOR ELEVATION

SCALE: 1/16" = 1'-0"

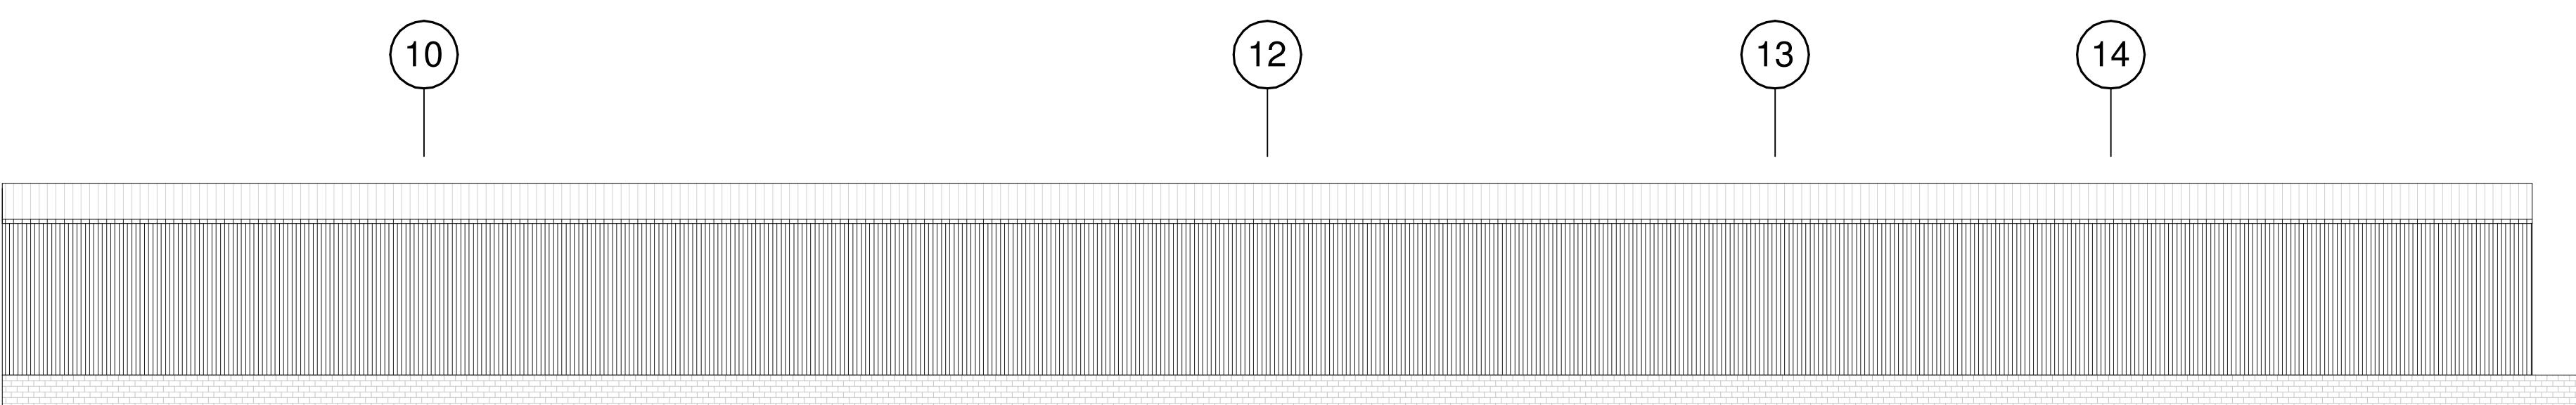

MATERIAL BINS - SOUTH EXTERIOR ELEVATION

SCALE: 1/16" = 1'-0"

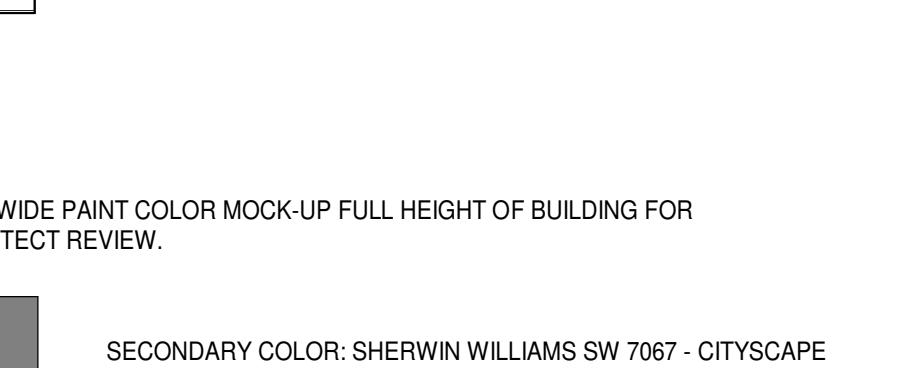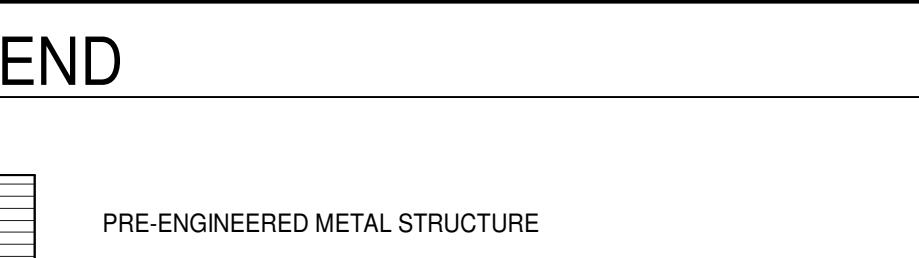

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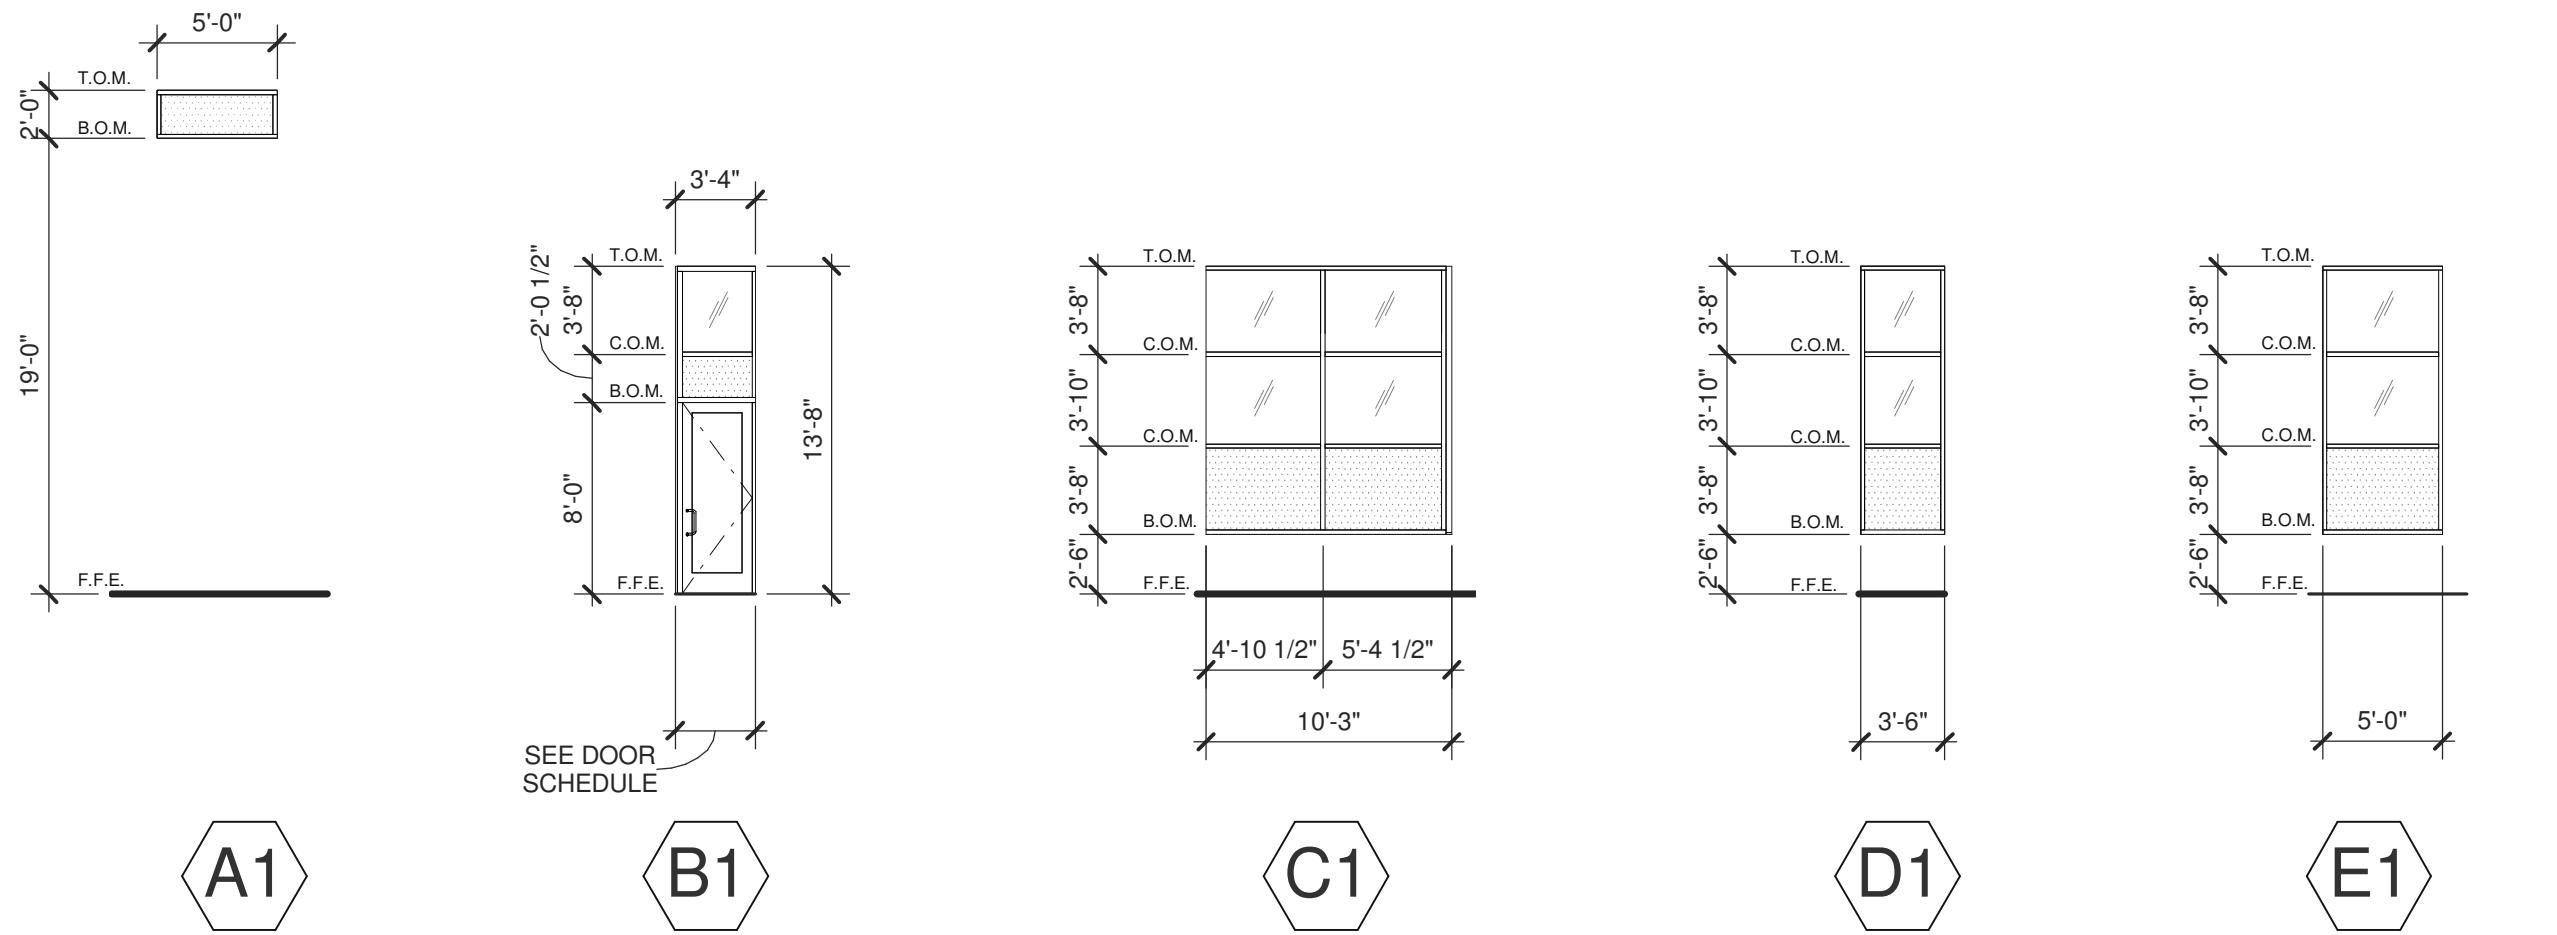
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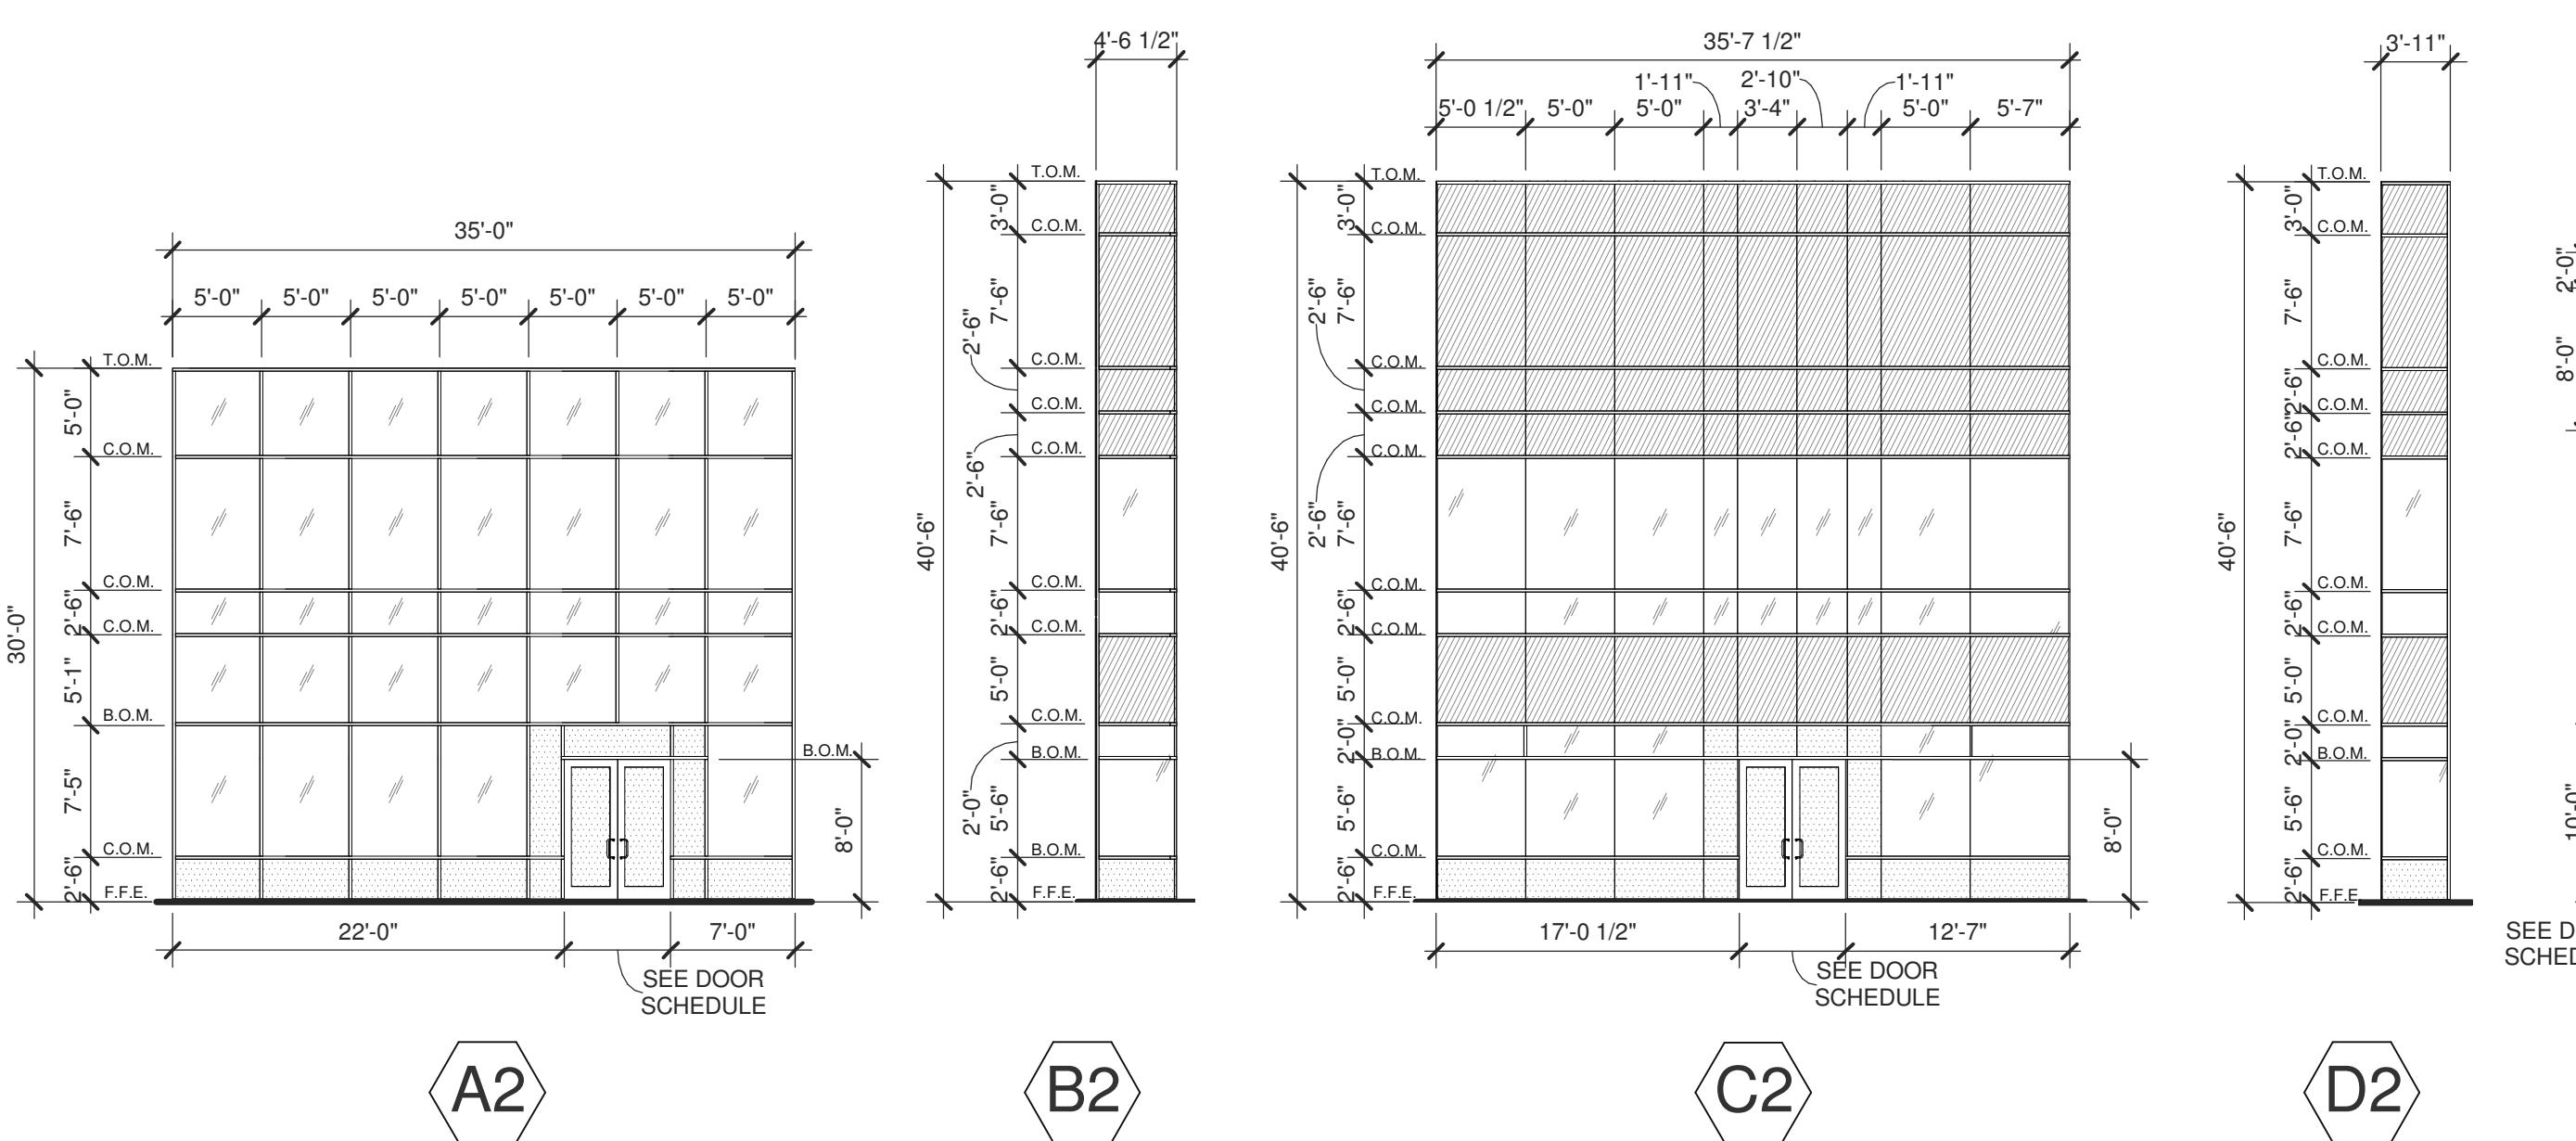
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## EXTERIOR WINDOW TYPES


BUILDING 1




BUILDING 2



BUILDING 3

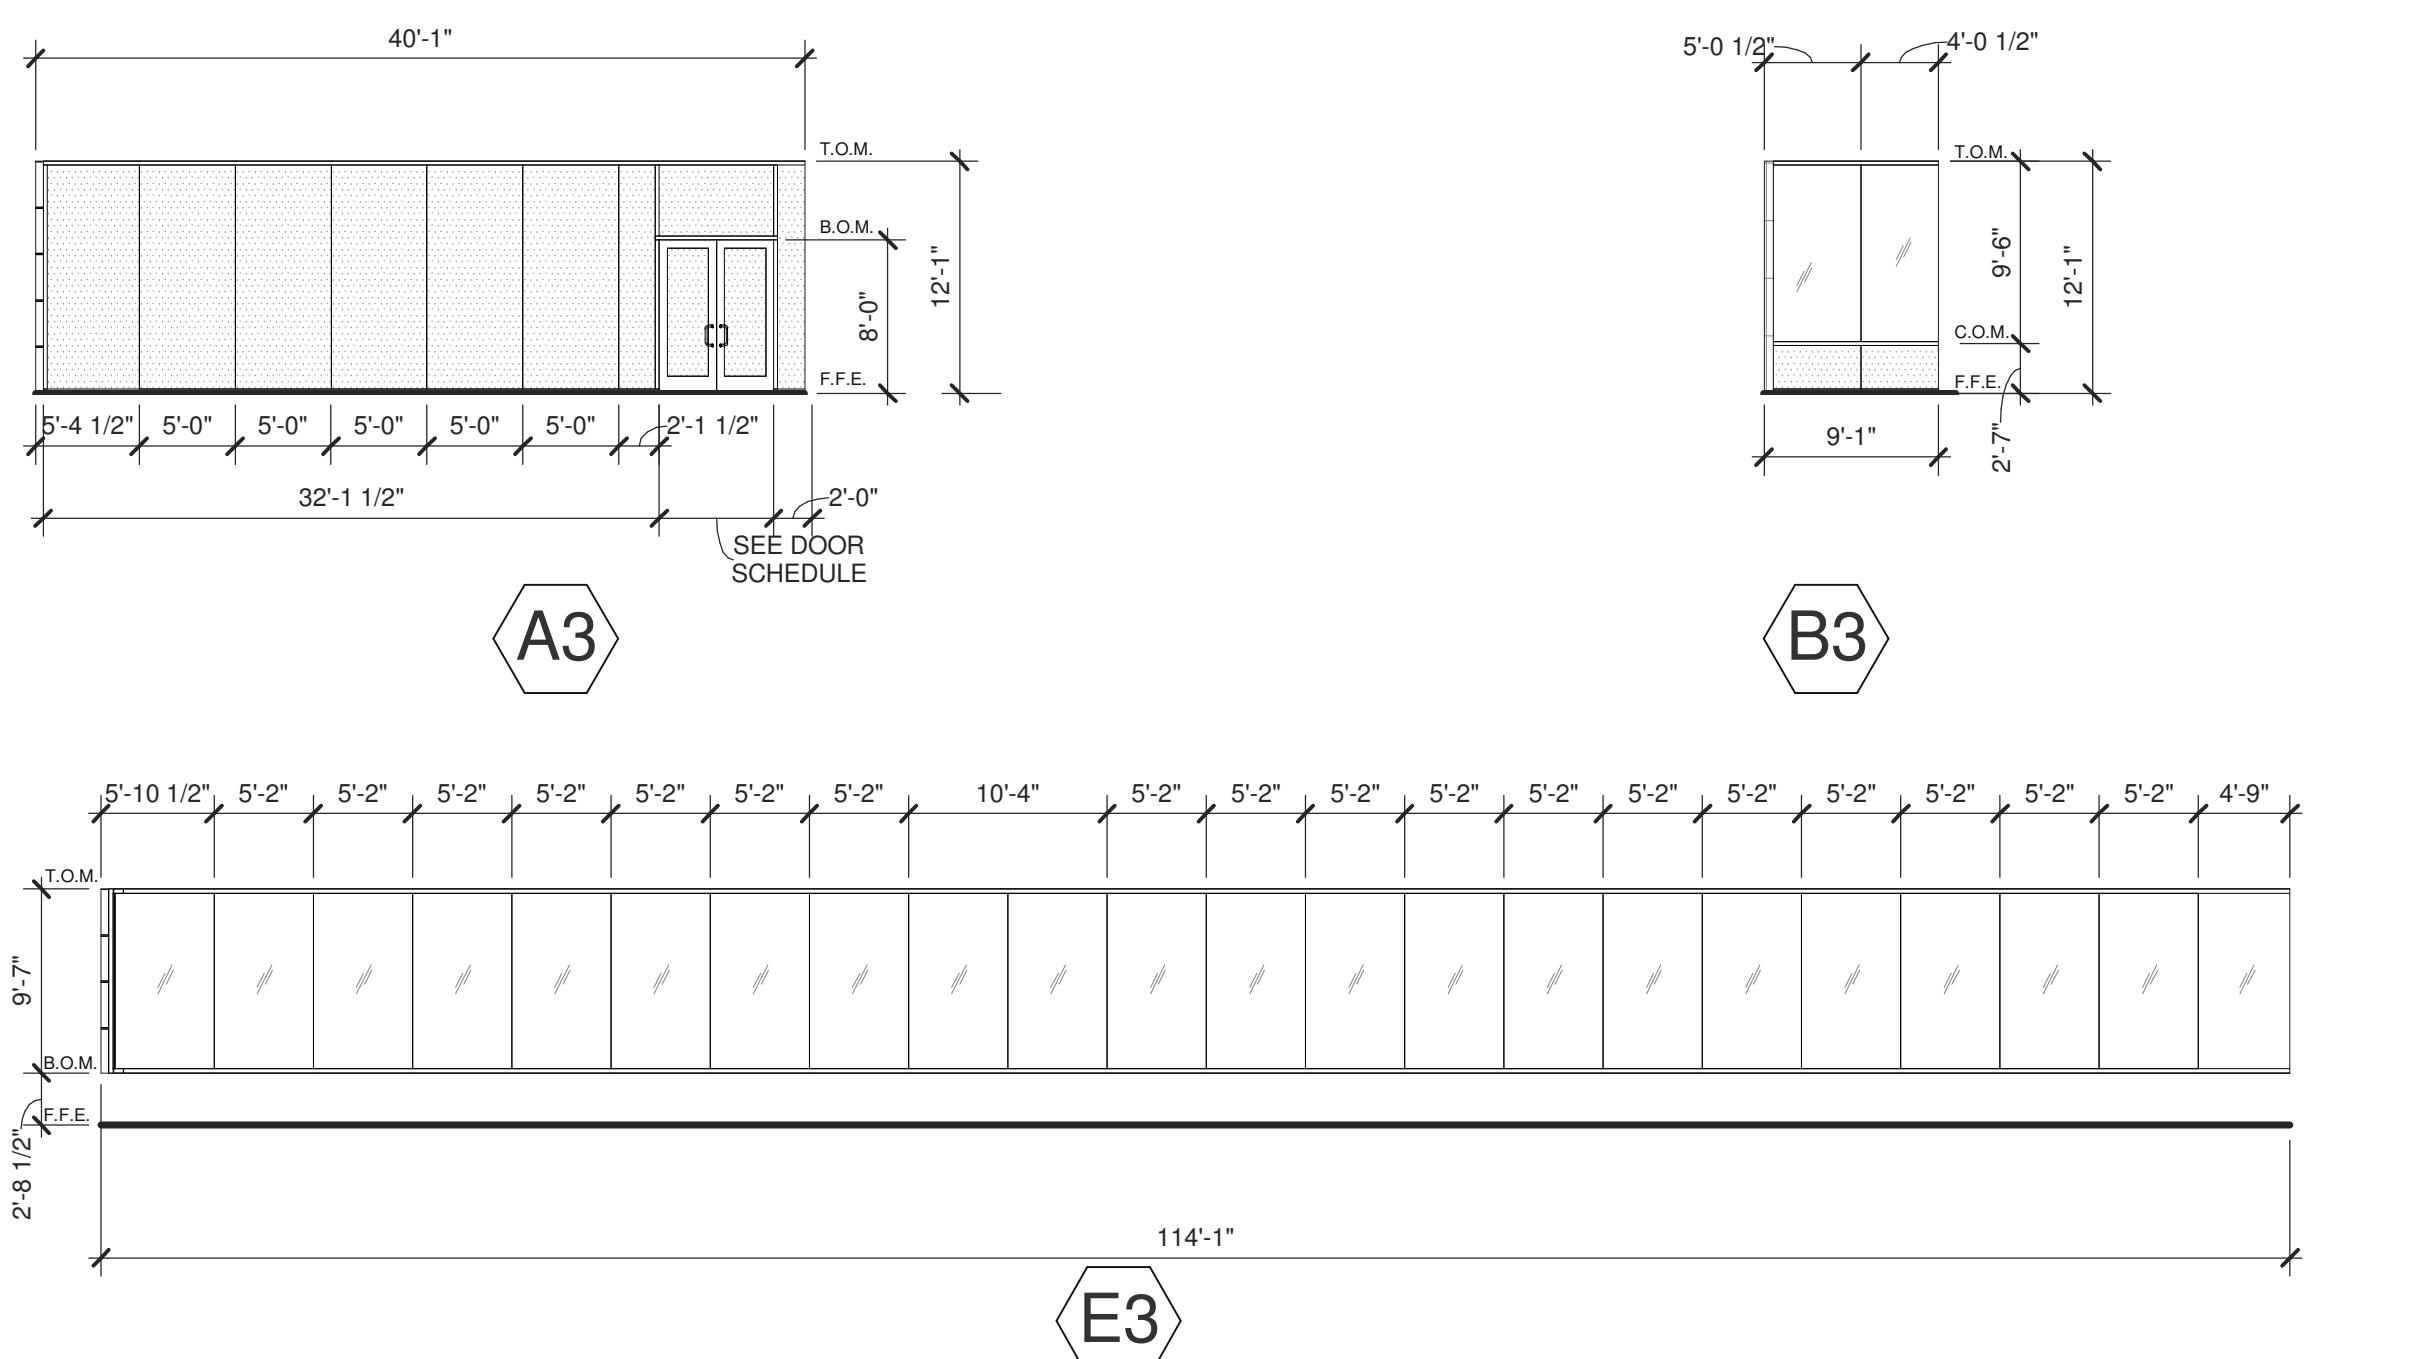

## LEGEND

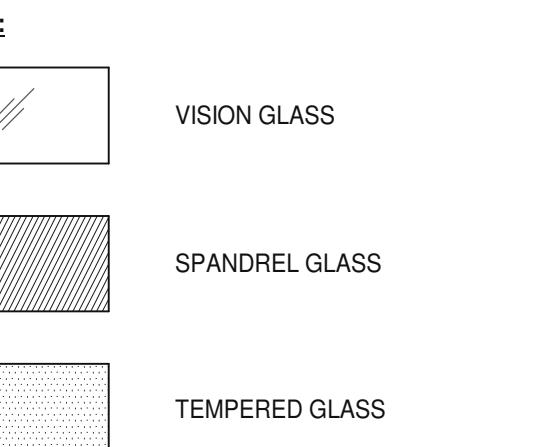

ALL GLASS USED ON THE ENVELOPE OF THE BUILDING TO BE:  
XXXXXX  
U FACTOR = 0.26 AND SHGC = 0.28  
GLASS WIND LOAD RESISTANCE CALCULATIONS ARE UNDER SEPARATE PERMIT

## ABBREVIATIONS

T.O.M. = TOP OF MULLION  
C.O.M. = CENTER OF MULLION  
B.O.M. = BOTTOM OF MULLION  
F.F.E. = FINISH FLOOR ELEVATION

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## EXTERIOR WINDOW TYPES

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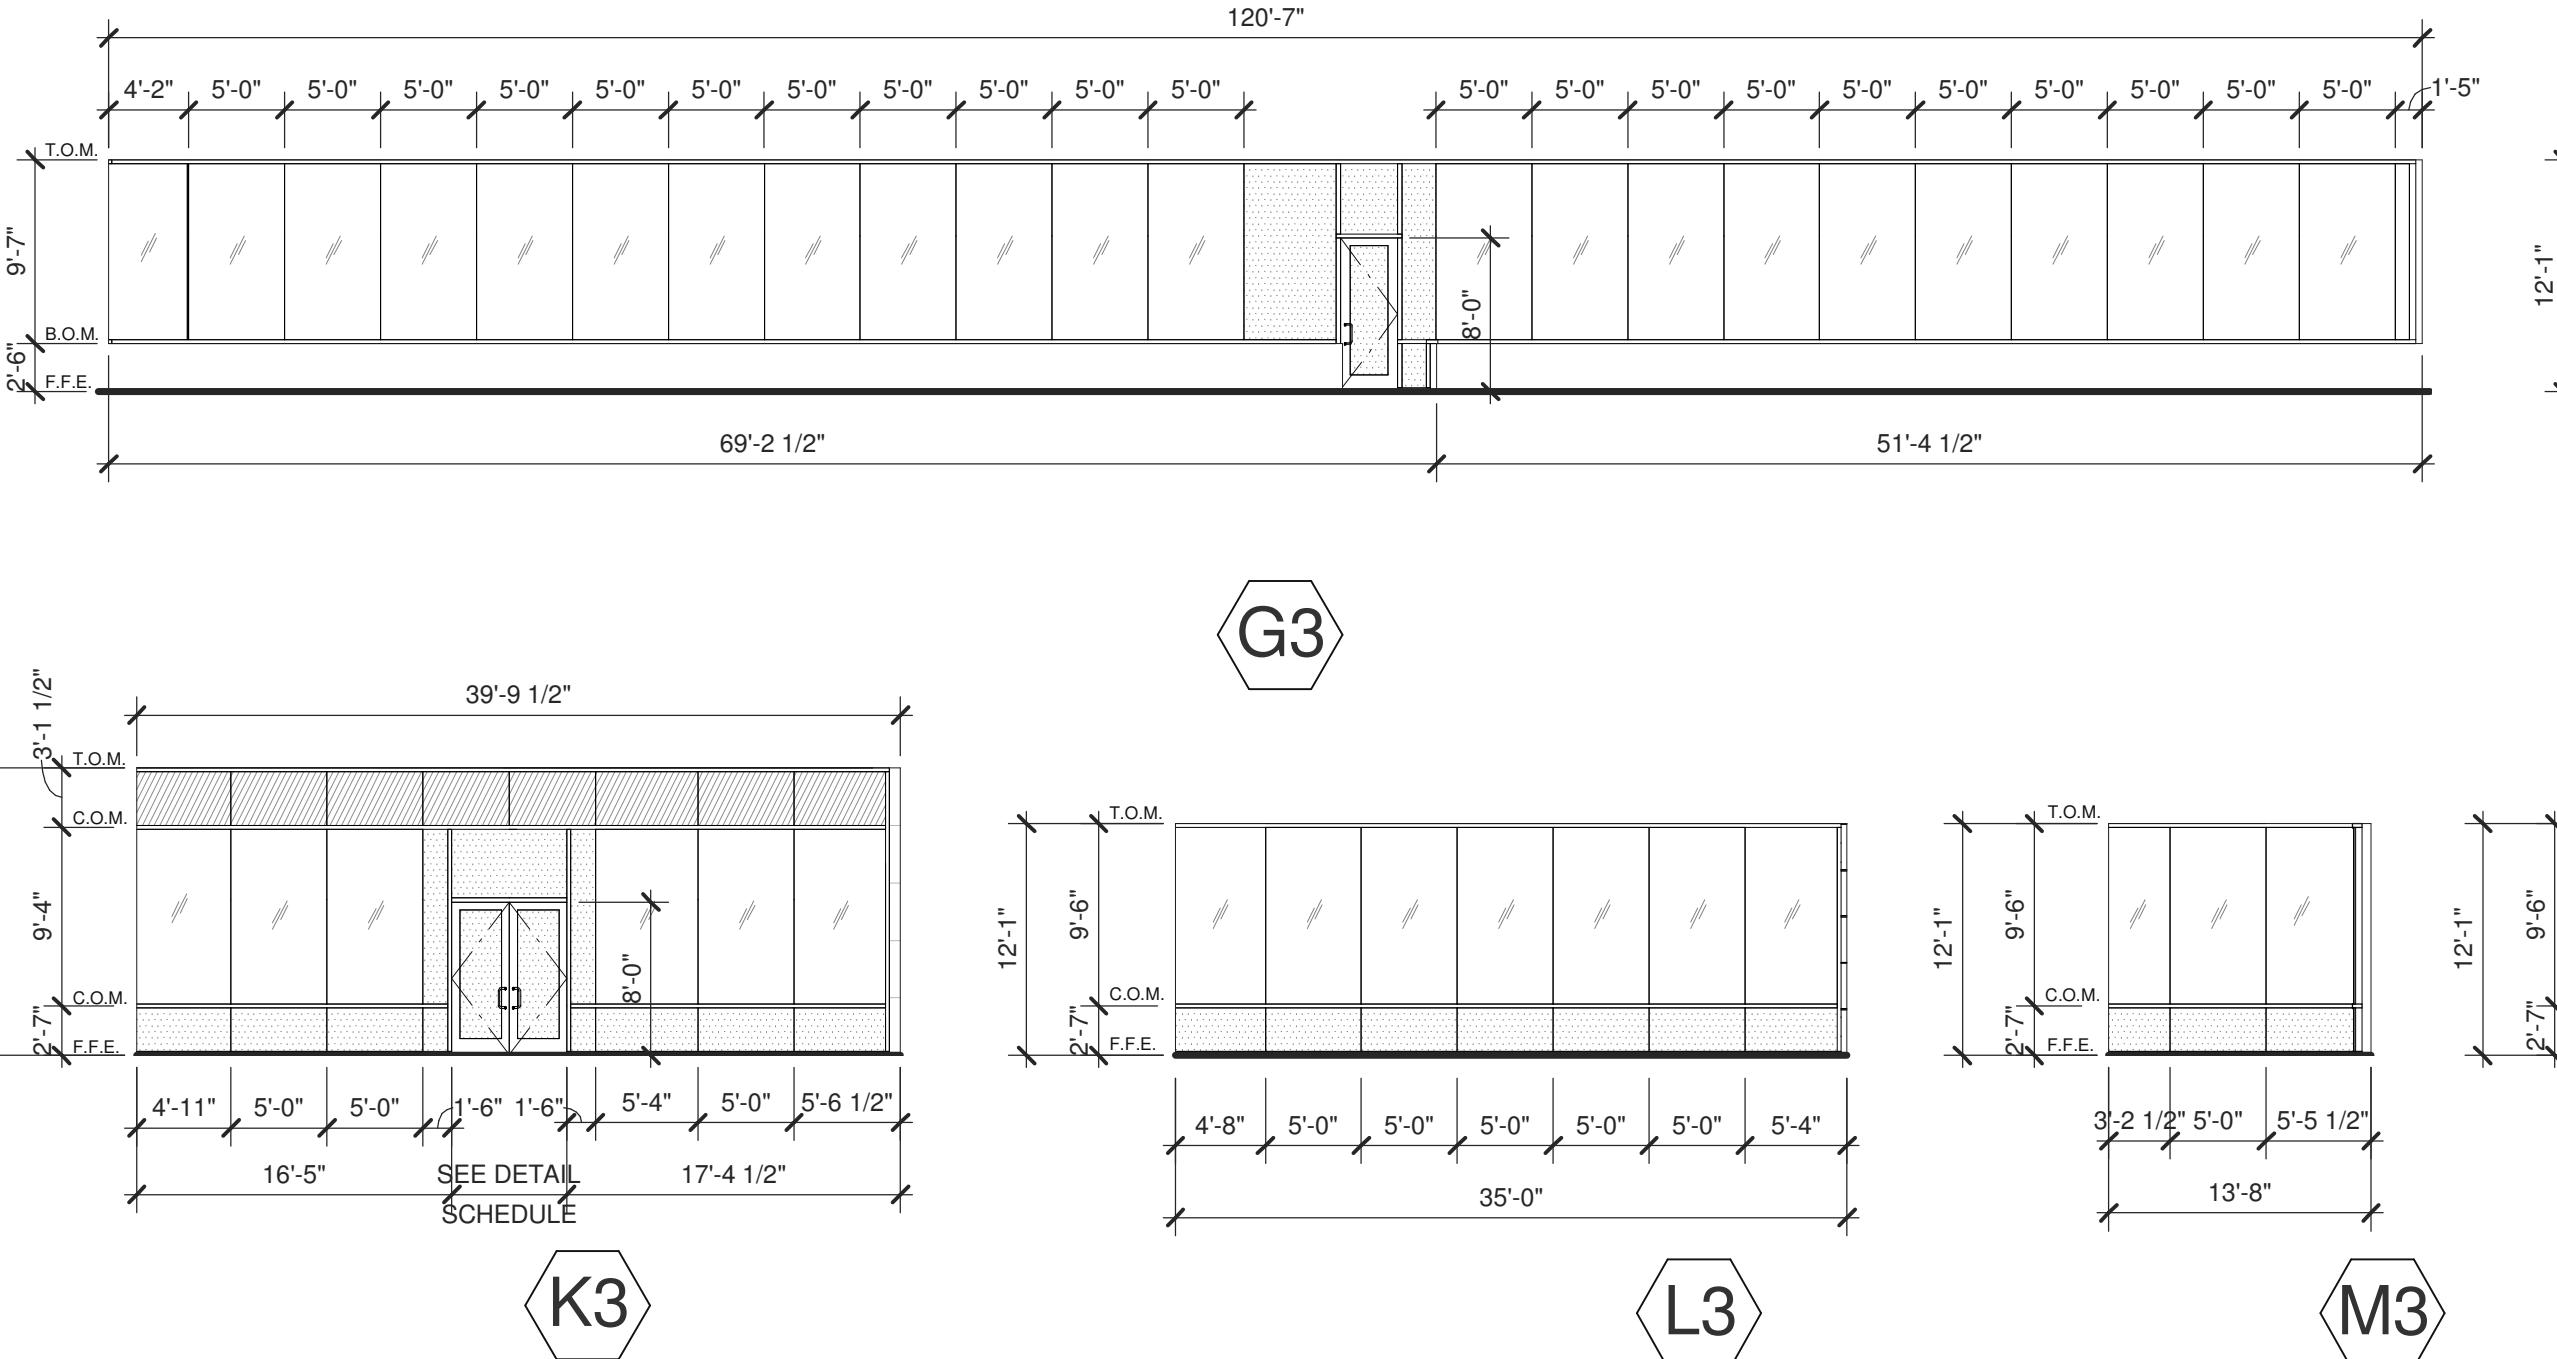
PA/PM: J. BABINE  
DRAWN BY: E.S.  
JOB NO.: SNR17-0069-00

## SHEET


**A5.1**

## BUILDING 3


## EXTERIOR WINDOW TYPES




## BUILDING 3

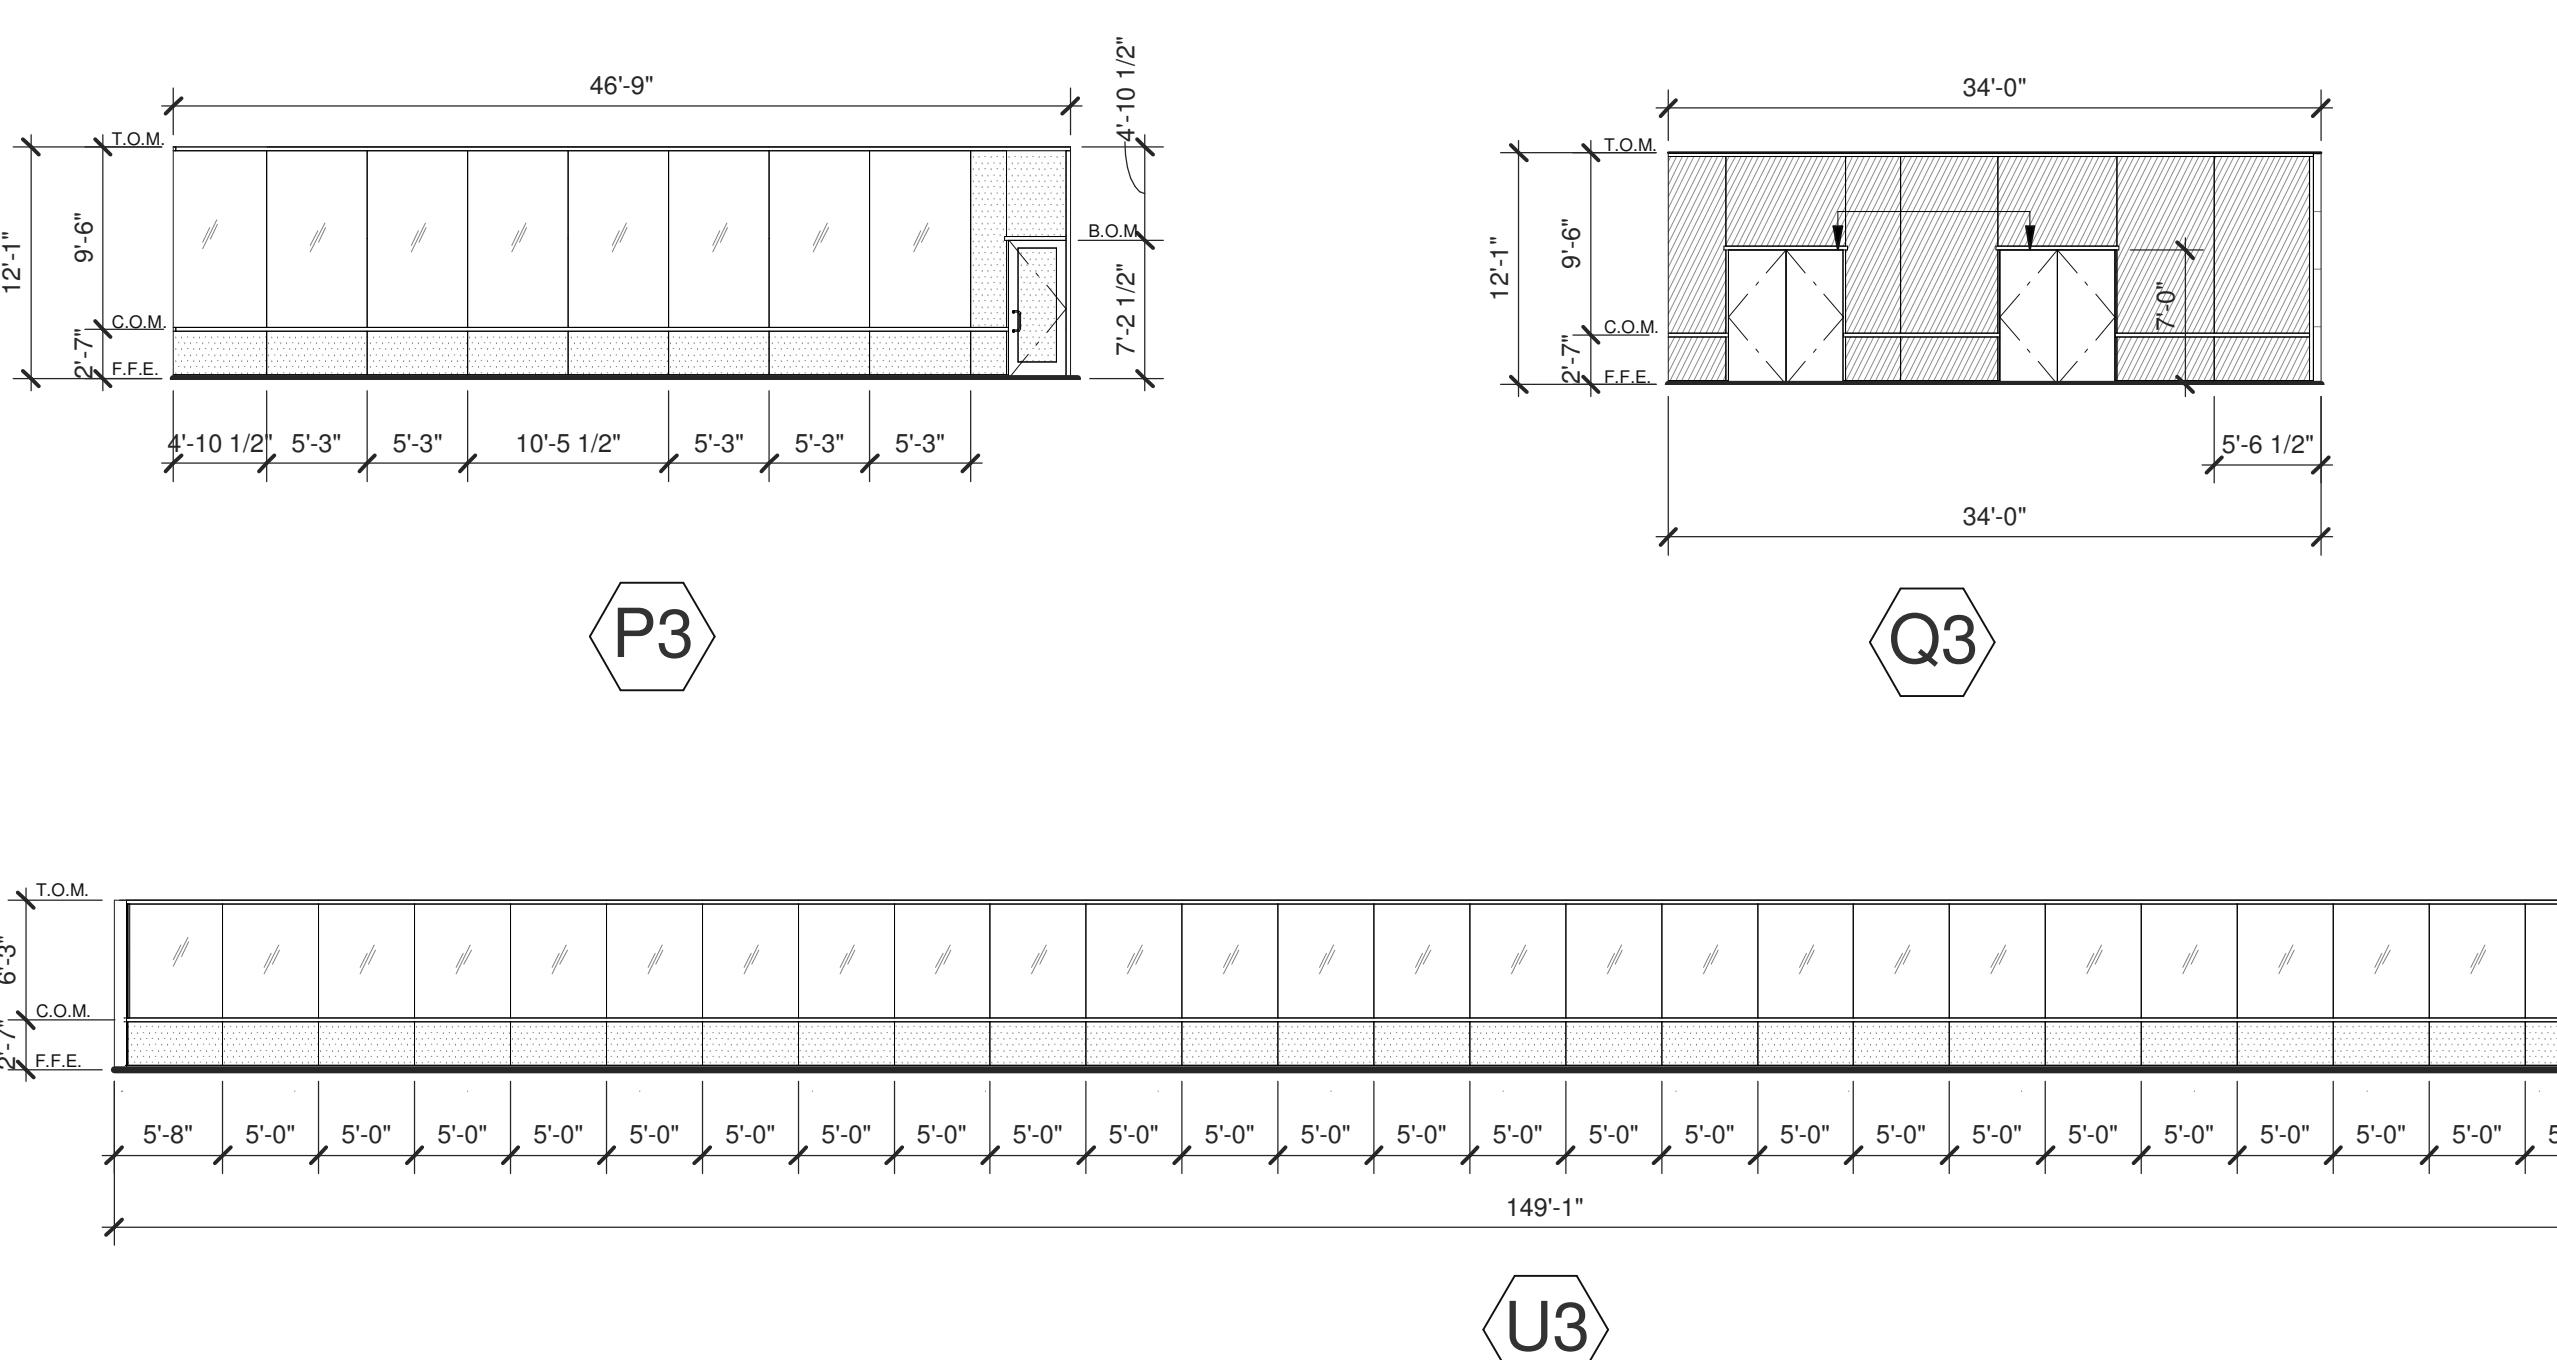

## BUILDING 3

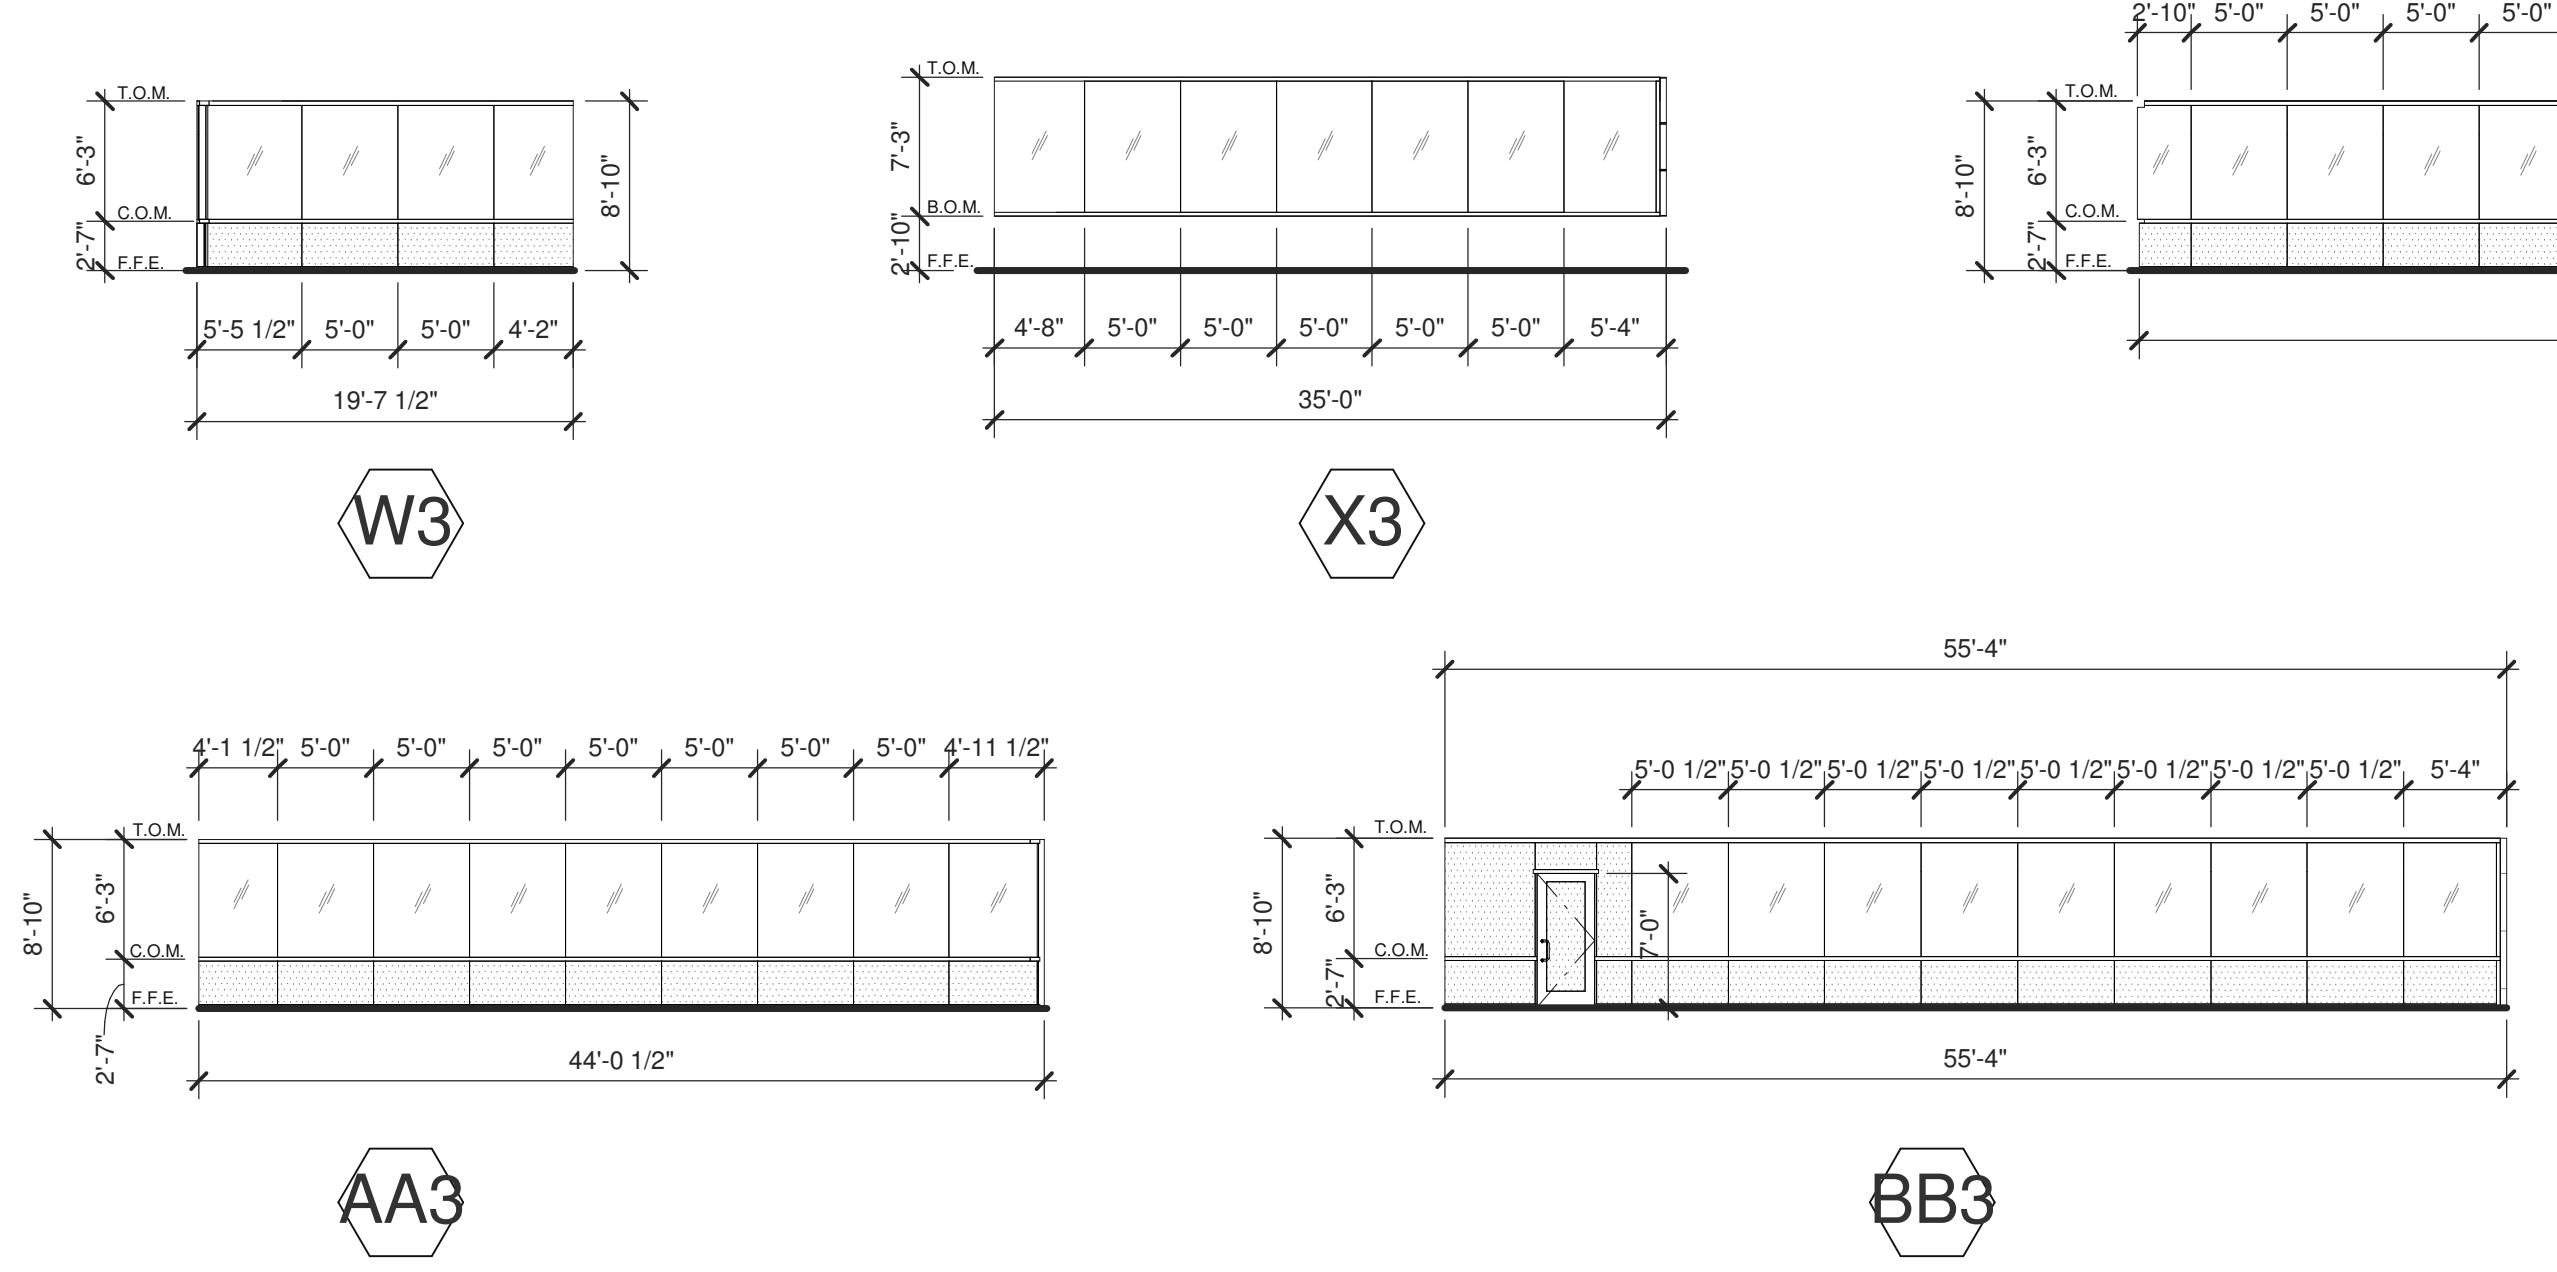

## LEGEND

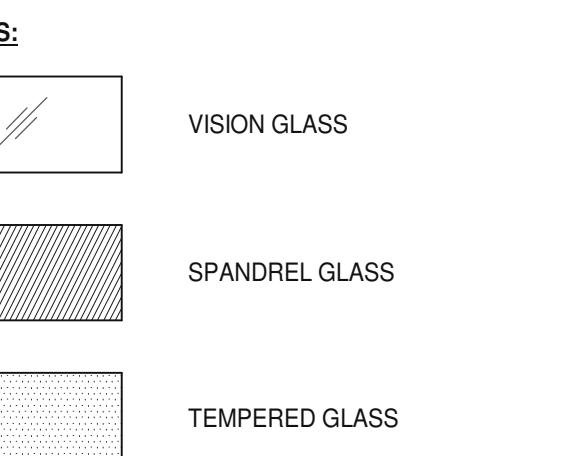

ALL GLASS USED ON THE ENVELOPE OF THE BUILDING TO BE:  
XXXXXX  
U FACTOR = 0.28 AND SHGC = 0.28  
GLASS WIND LOAD RESISTANCE CALCULATIONS ARE UNDER SEPARATE PERMIT

## ABBREVIATIONS

T.O.M. = TOP OF MULLION  
C.O.M. = CENTER OF MULLION  
B.O.M. = BOTTOM OF MULLION  
F.F.E. = FINISH FLOOR ELEVATION

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## EXTERIOR WINDOW TYPES


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04/03/2019	PLANNING SUBMITTAL

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JOB NO.: SNR17-0069-00

## SHEET

A5.2

## EXTERIOR WINDOW TYPES

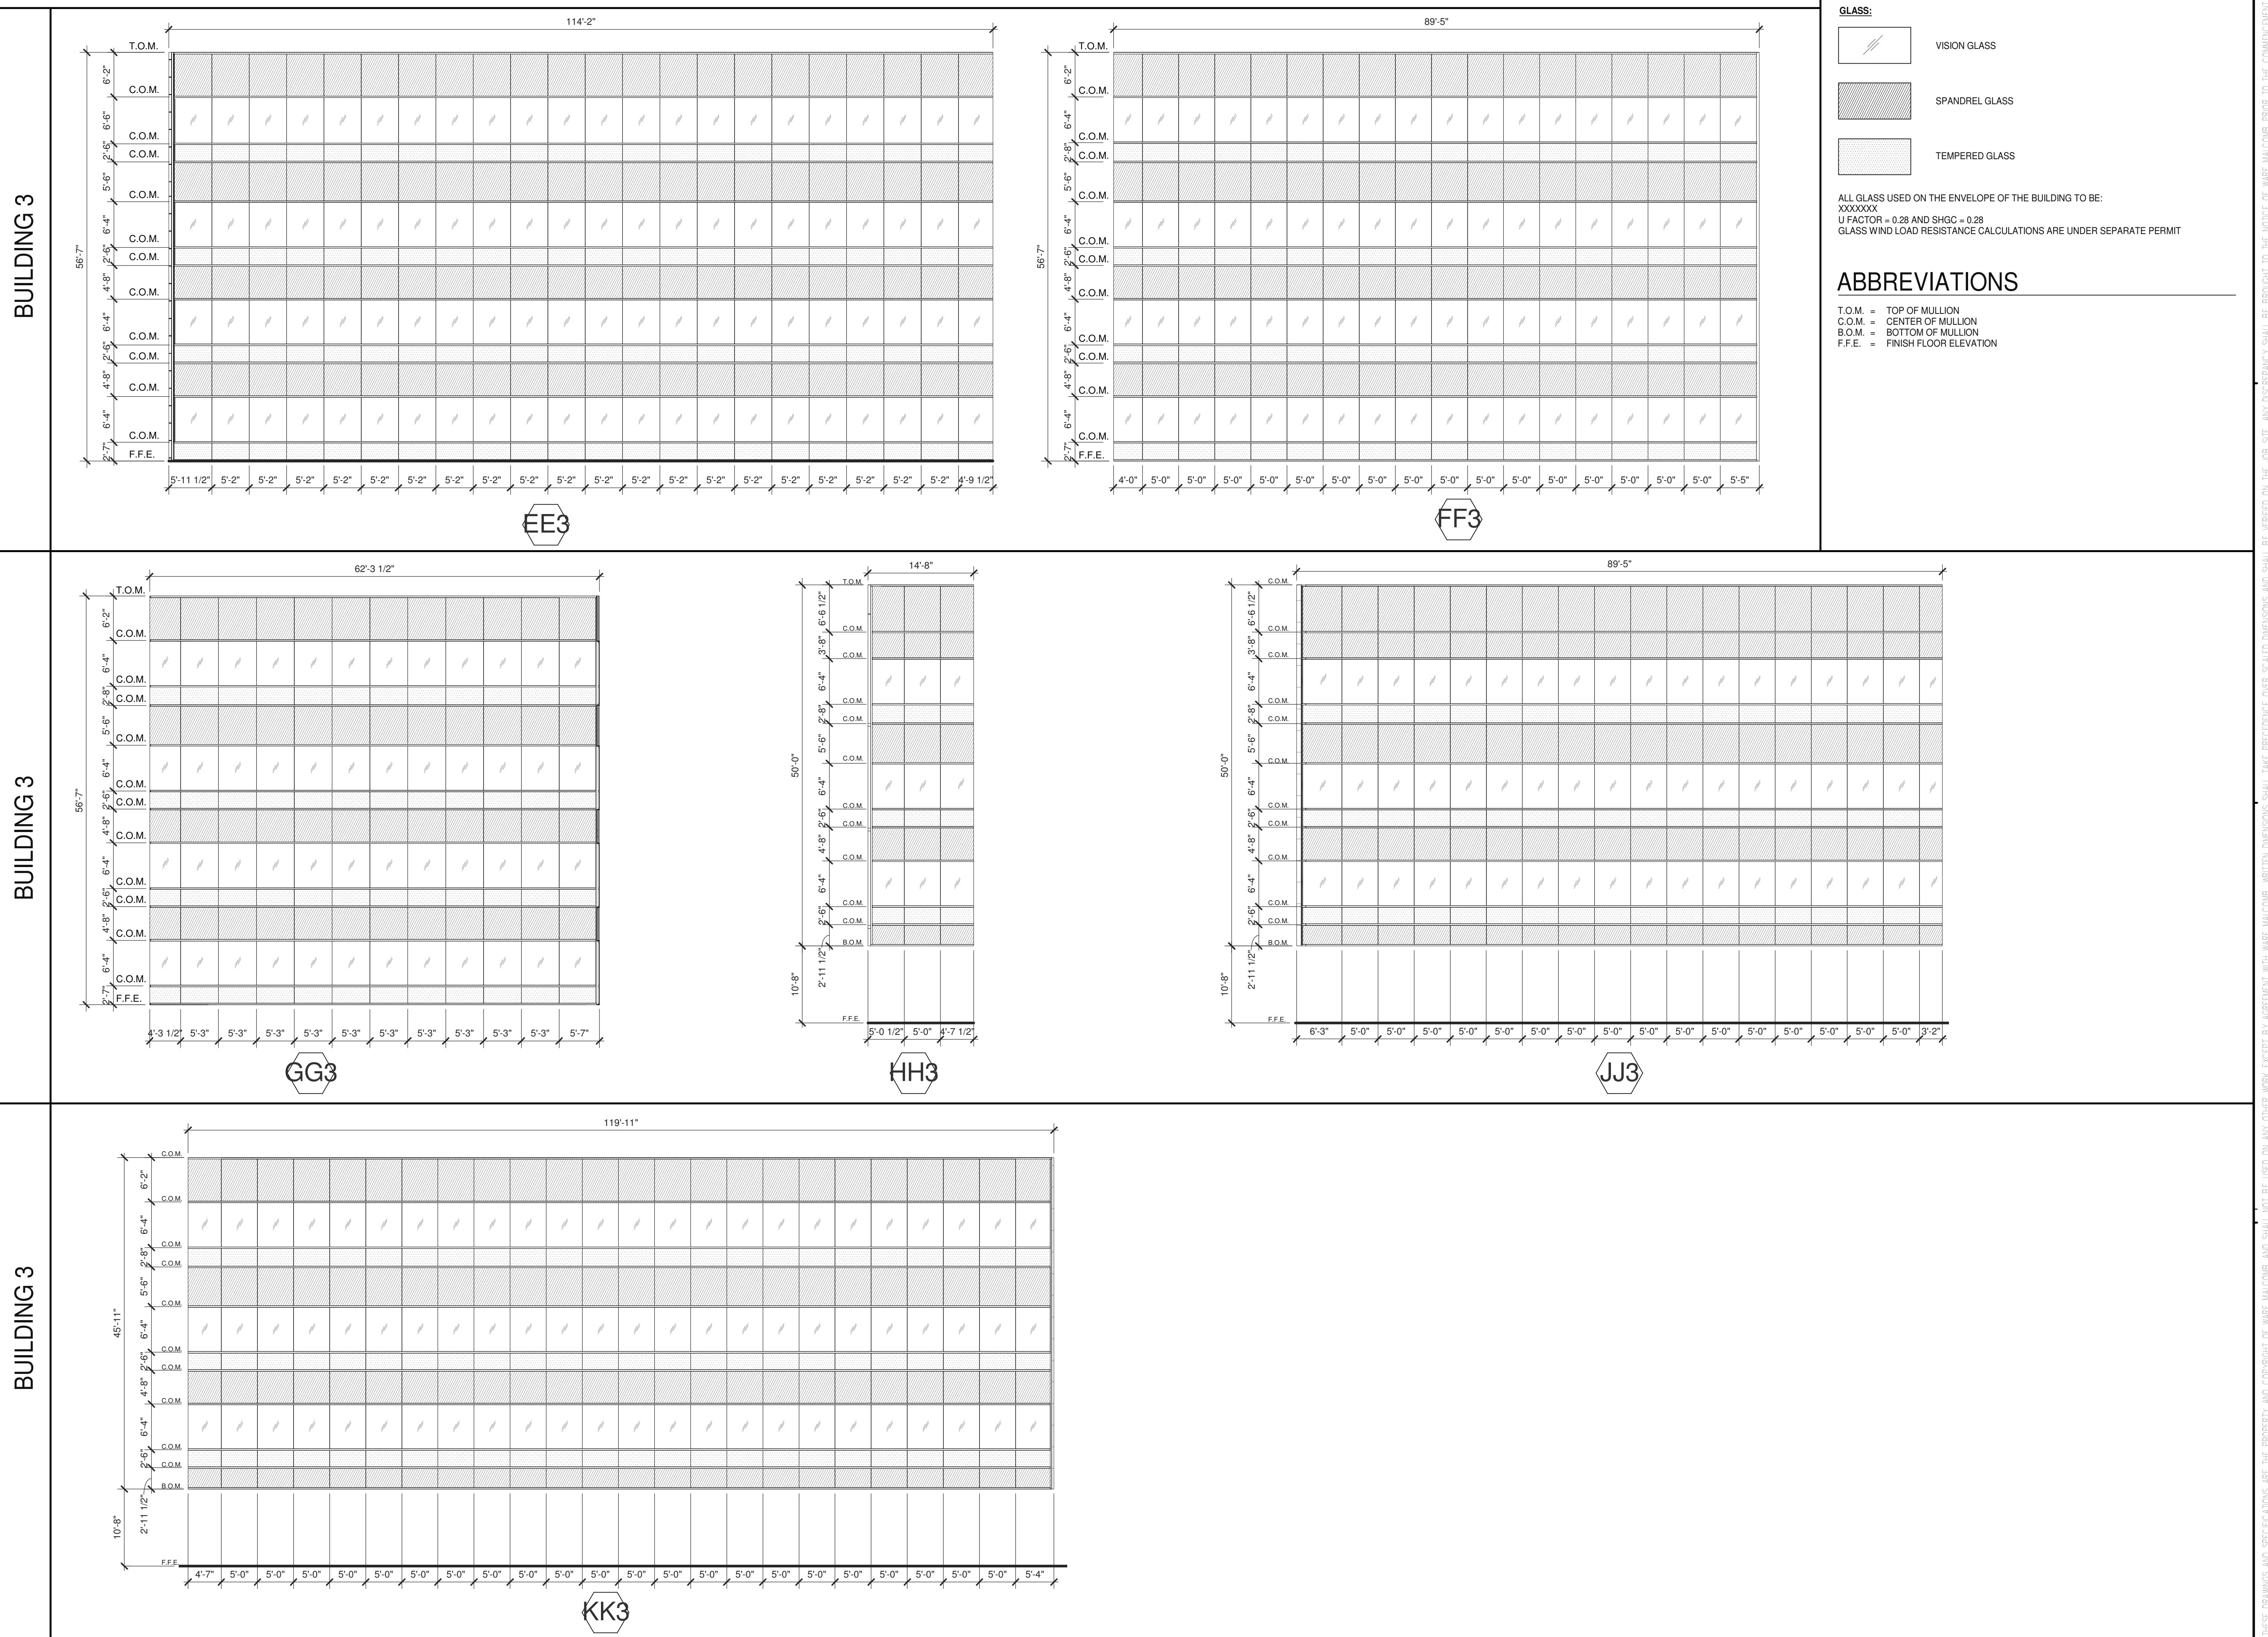

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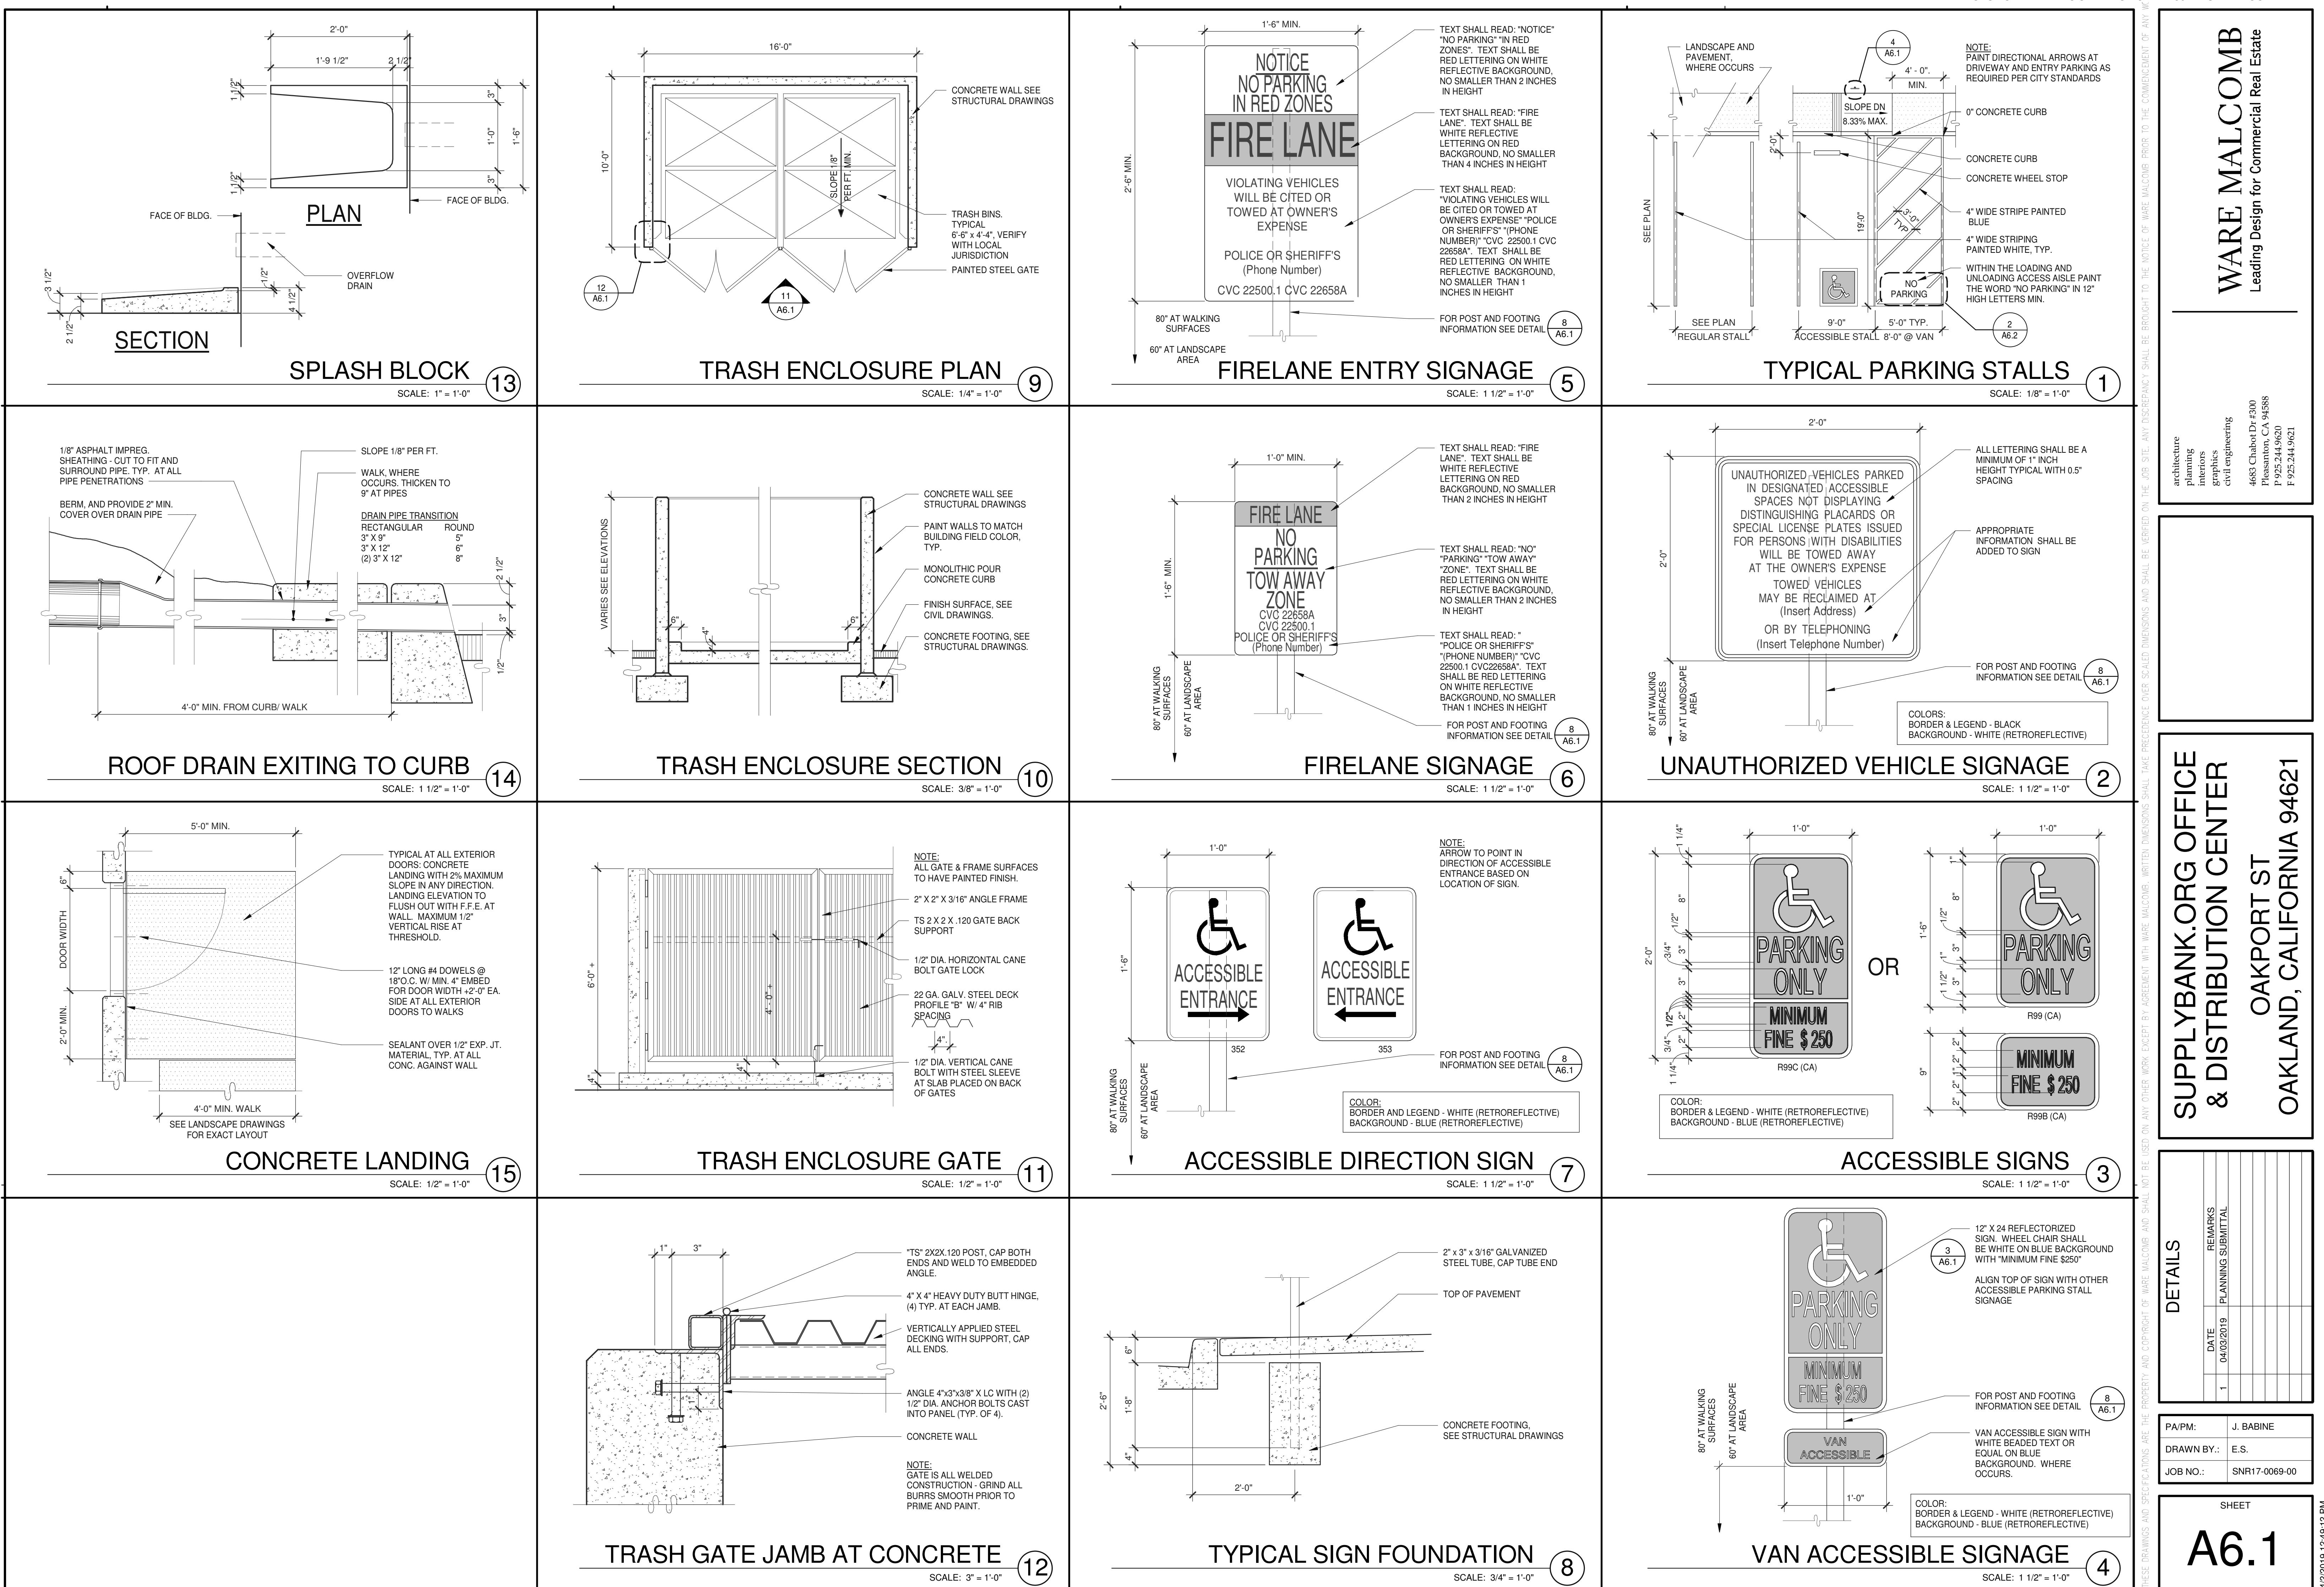
EXTERIOR WINDOW TYPES		REMARKS
DATE	04/03/2019	PLANNING SUBMITTAL


PA/PM: J. BABINE  
DRAWN BY: E.S.  
JOB NO.: SNR17-0069-00


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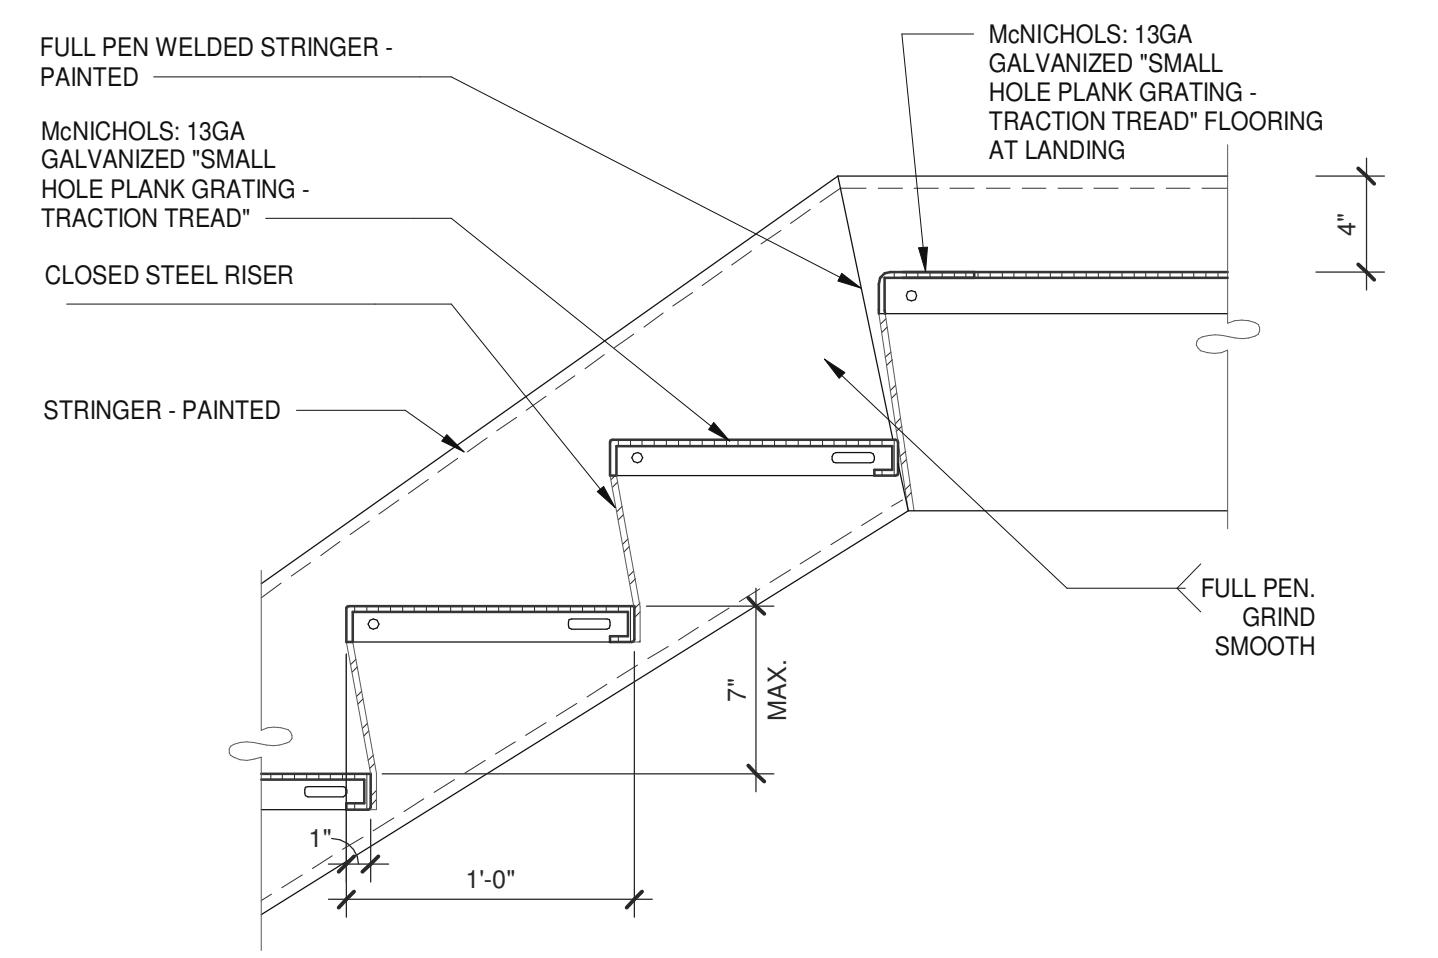
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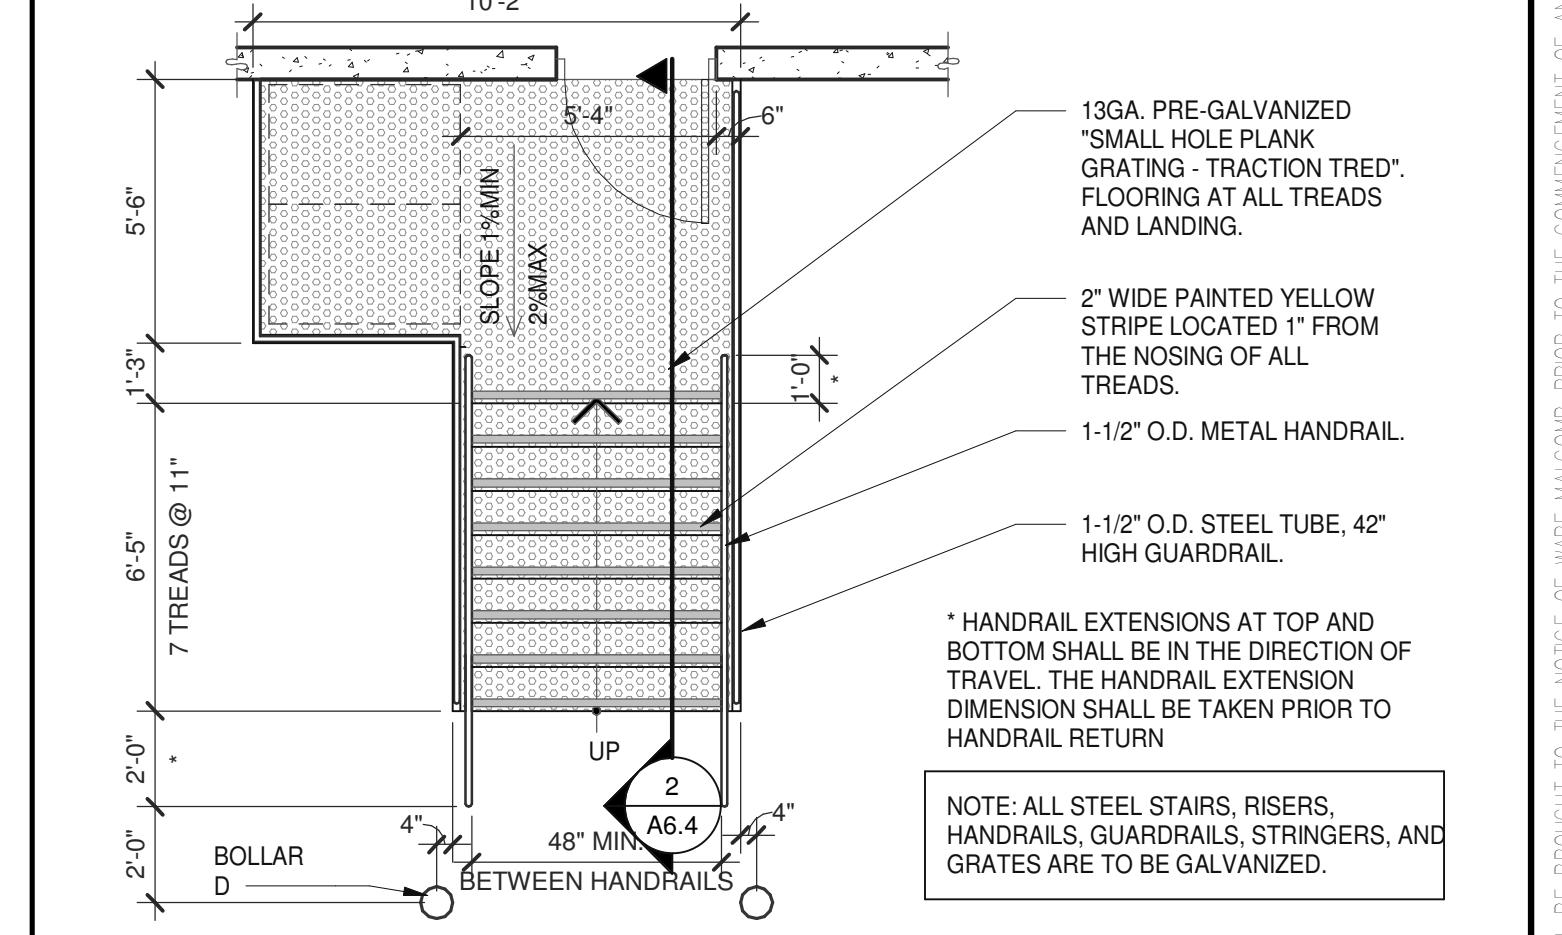






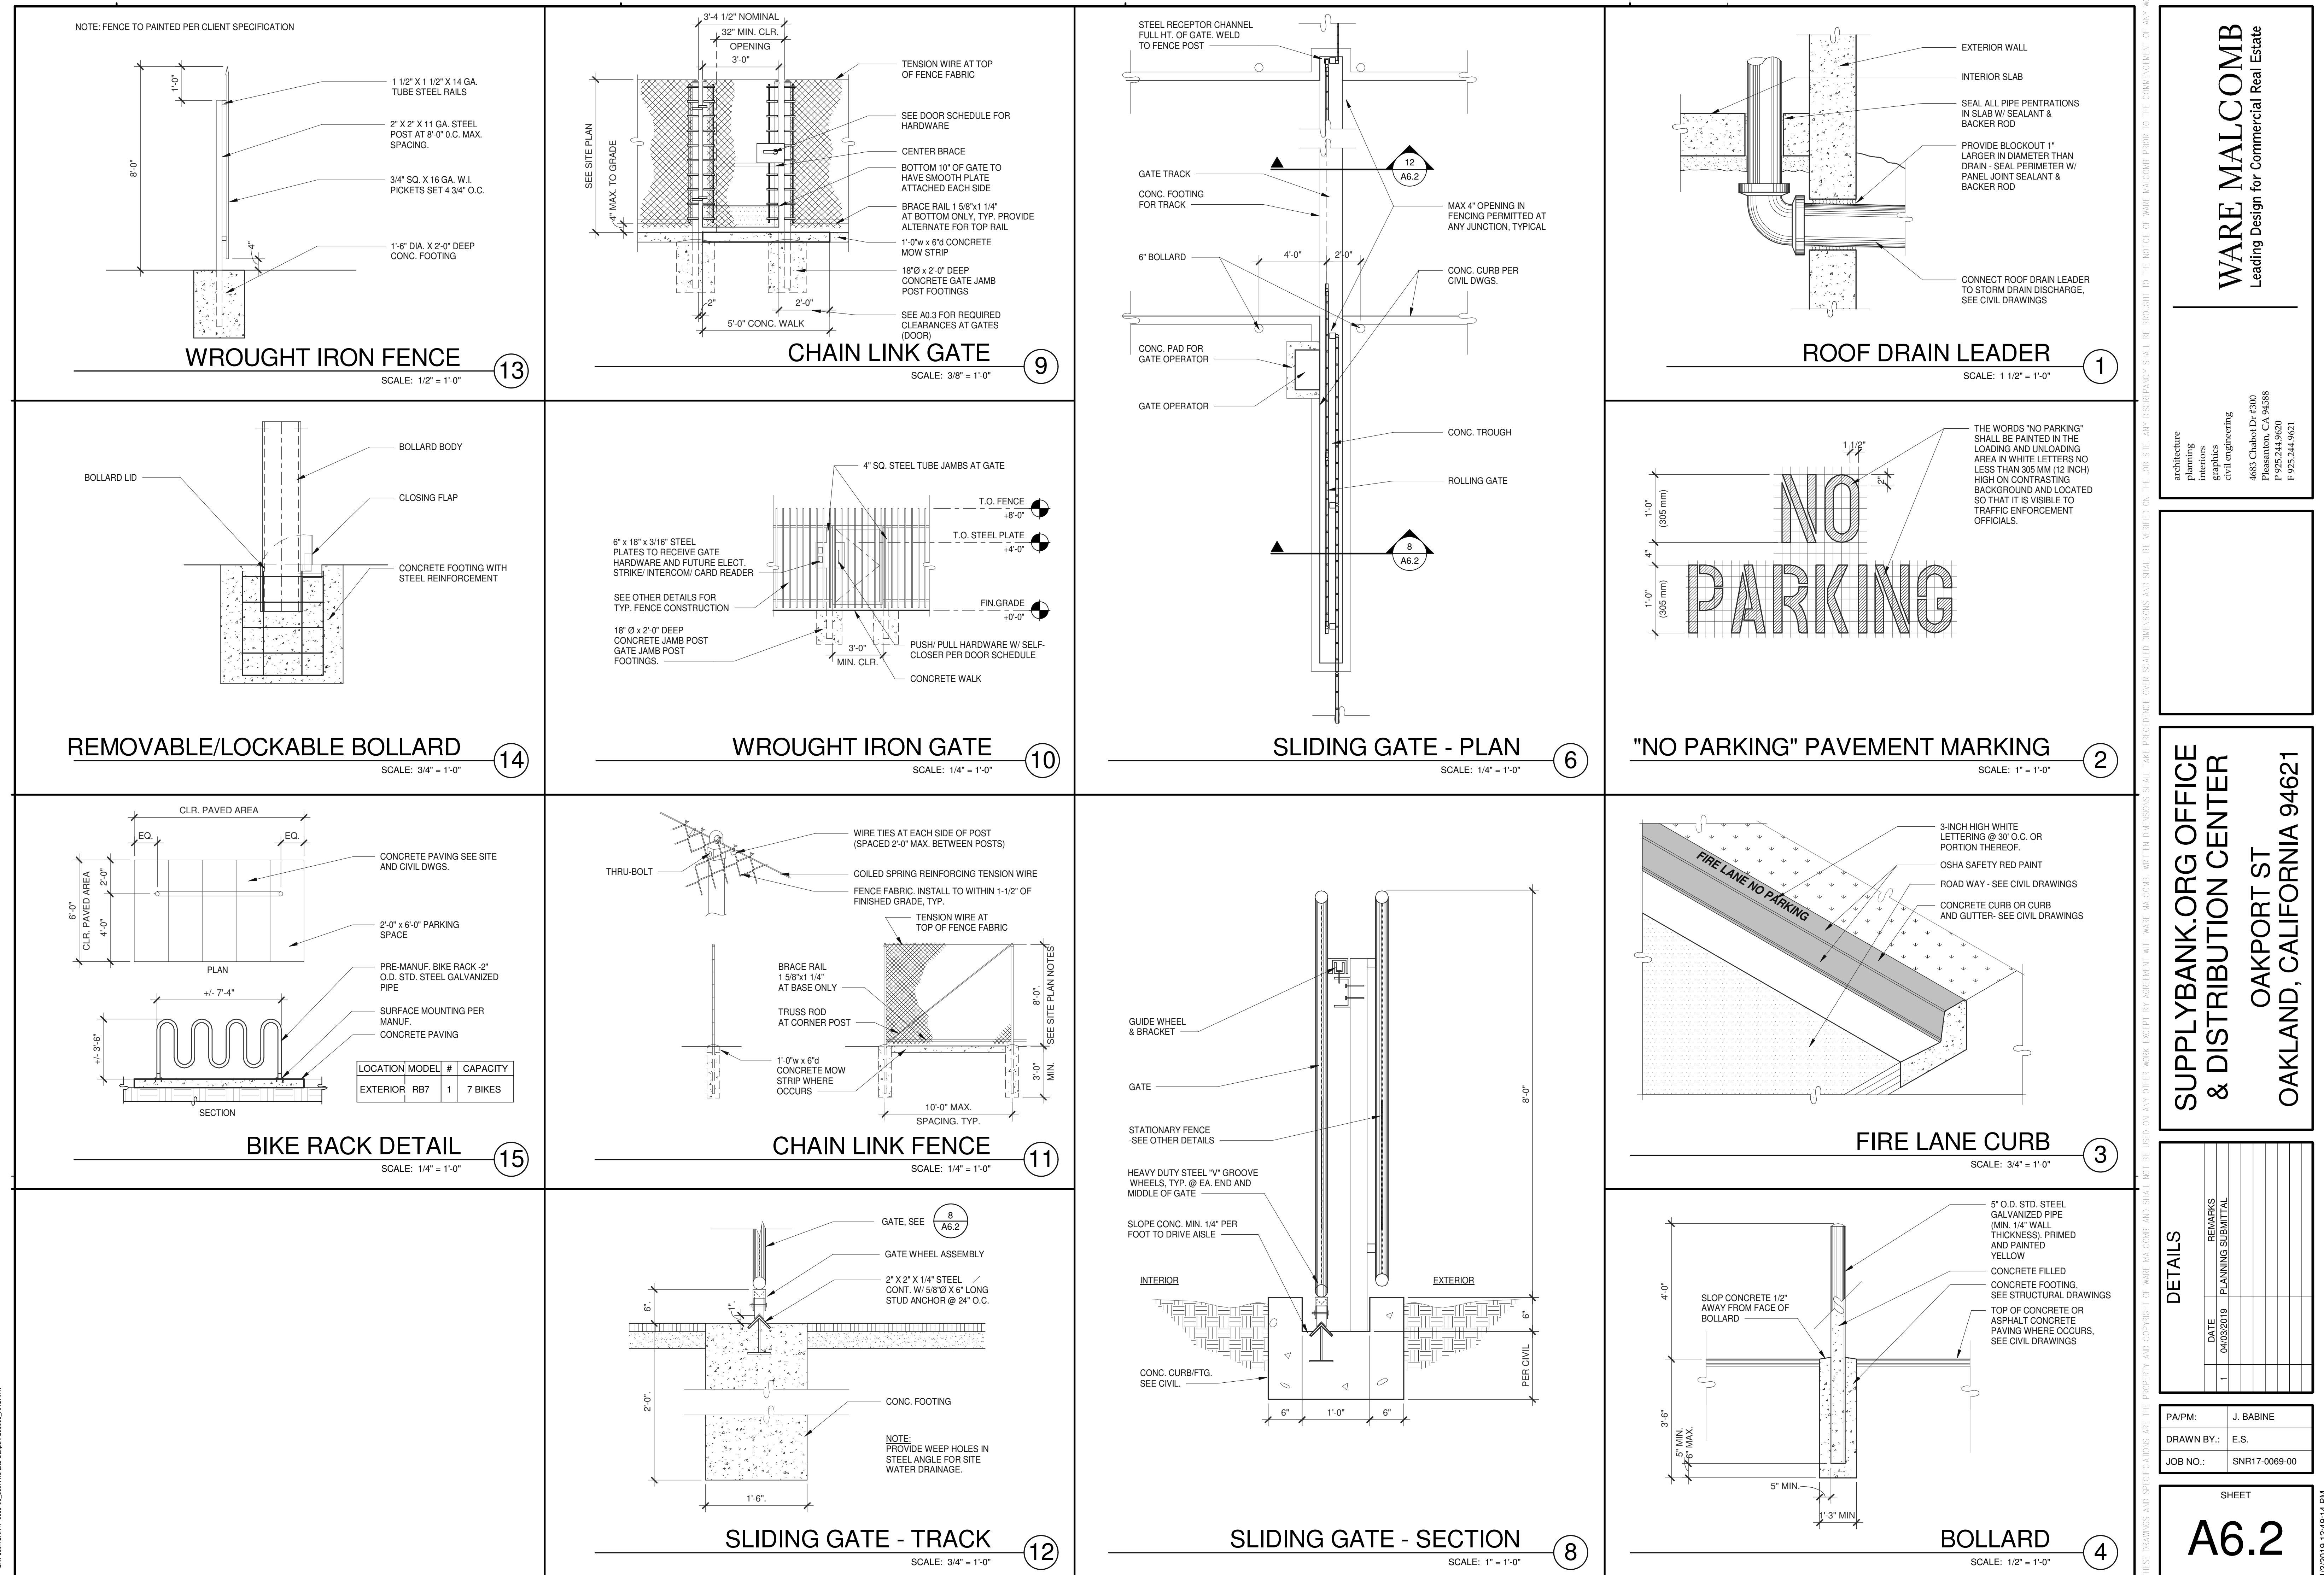


STEEL STAIR TREADS

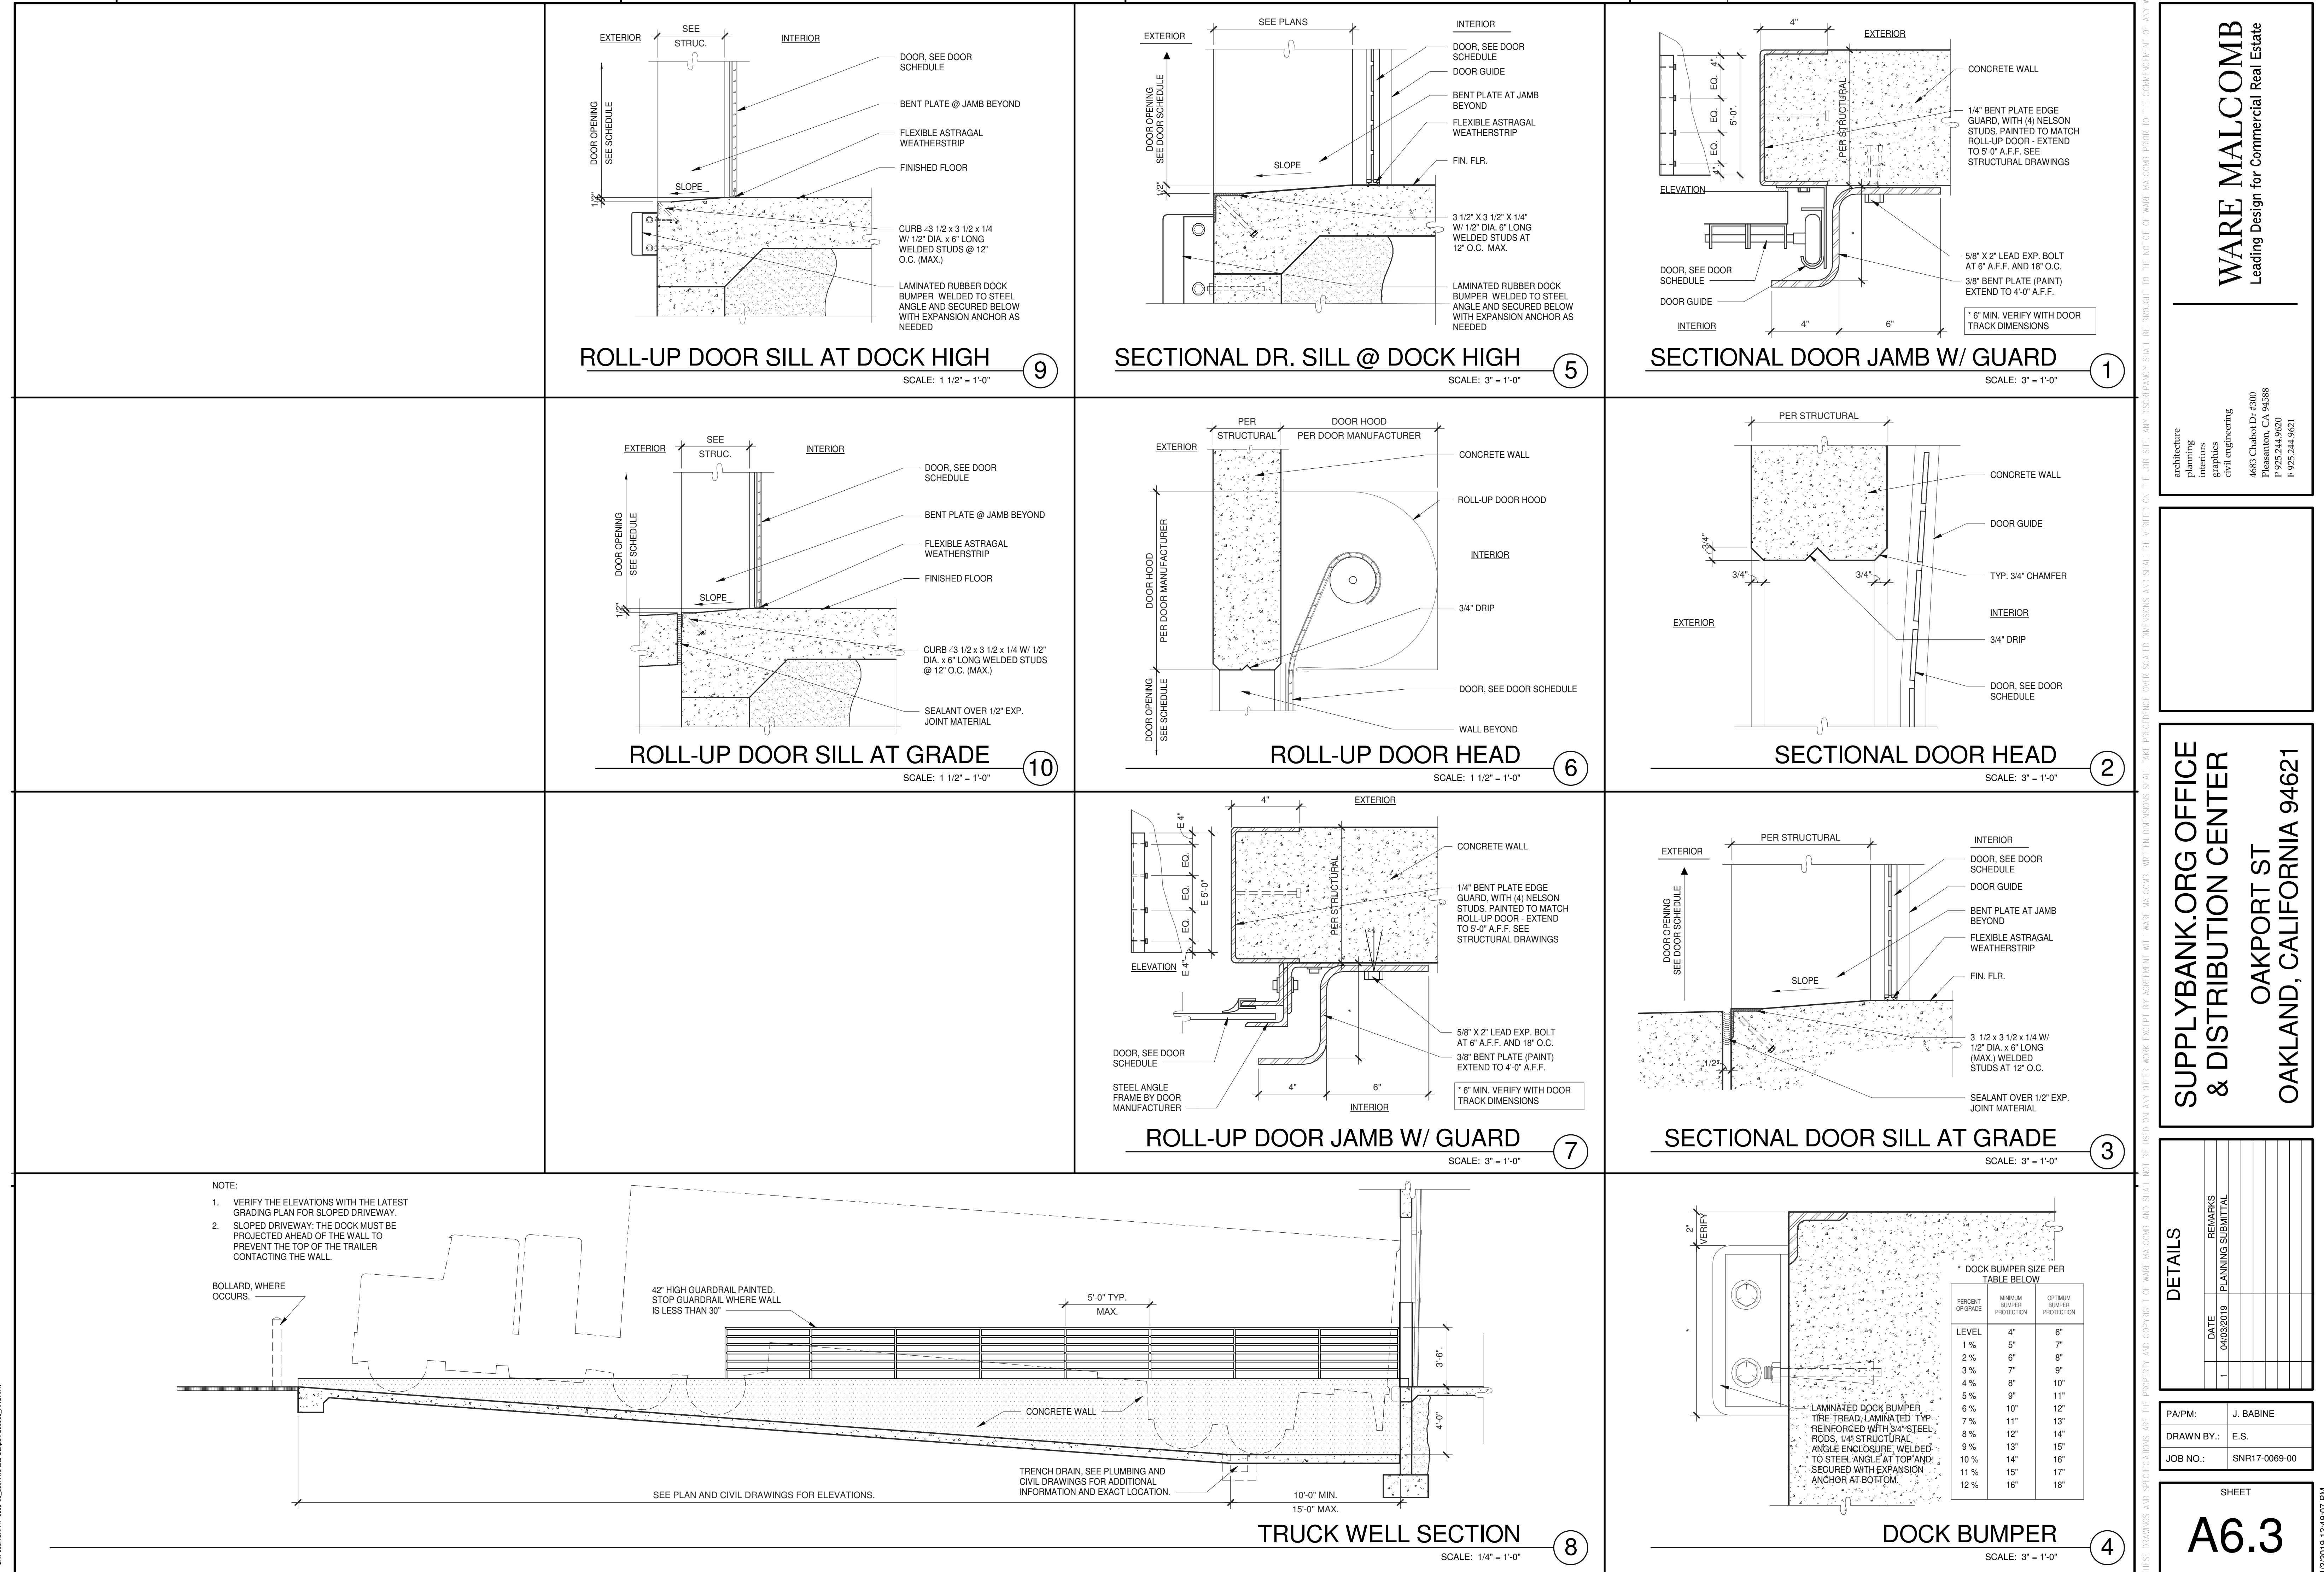


EXTERIOR STEEL STAIR PLAN

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STEEL STAIR @ BOTTOM

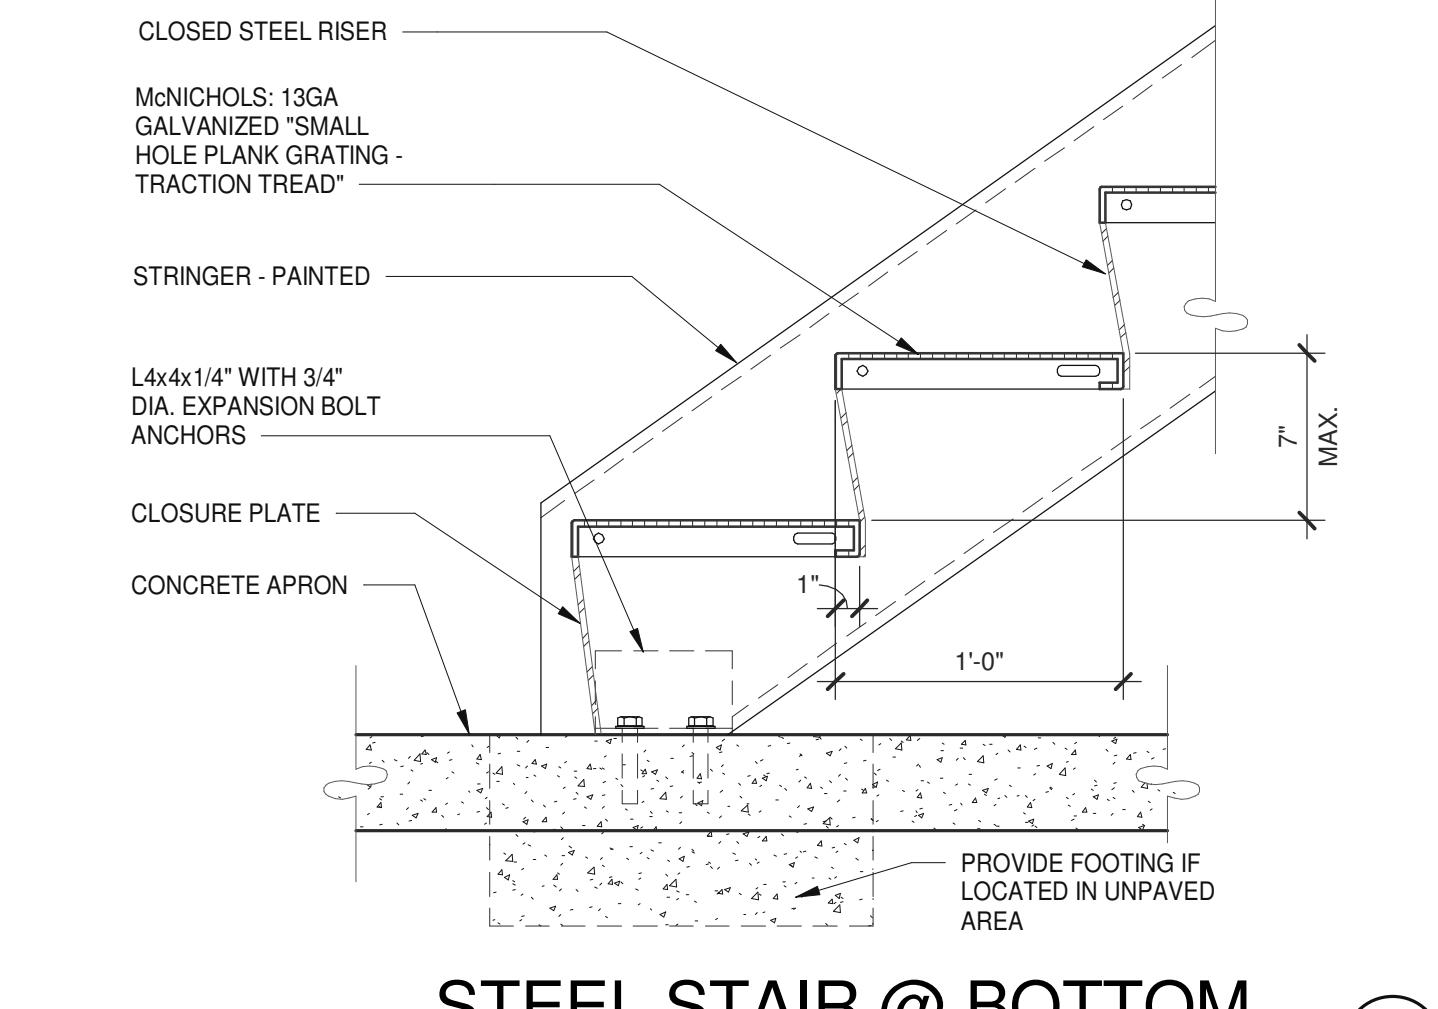

STAIR SECTION


**SUPPLYBANK.ORG OFFICE & DISTRIBUTION CENTER**  
OAKPORT ST  
OAKLAND, CALIFORNIA 94621

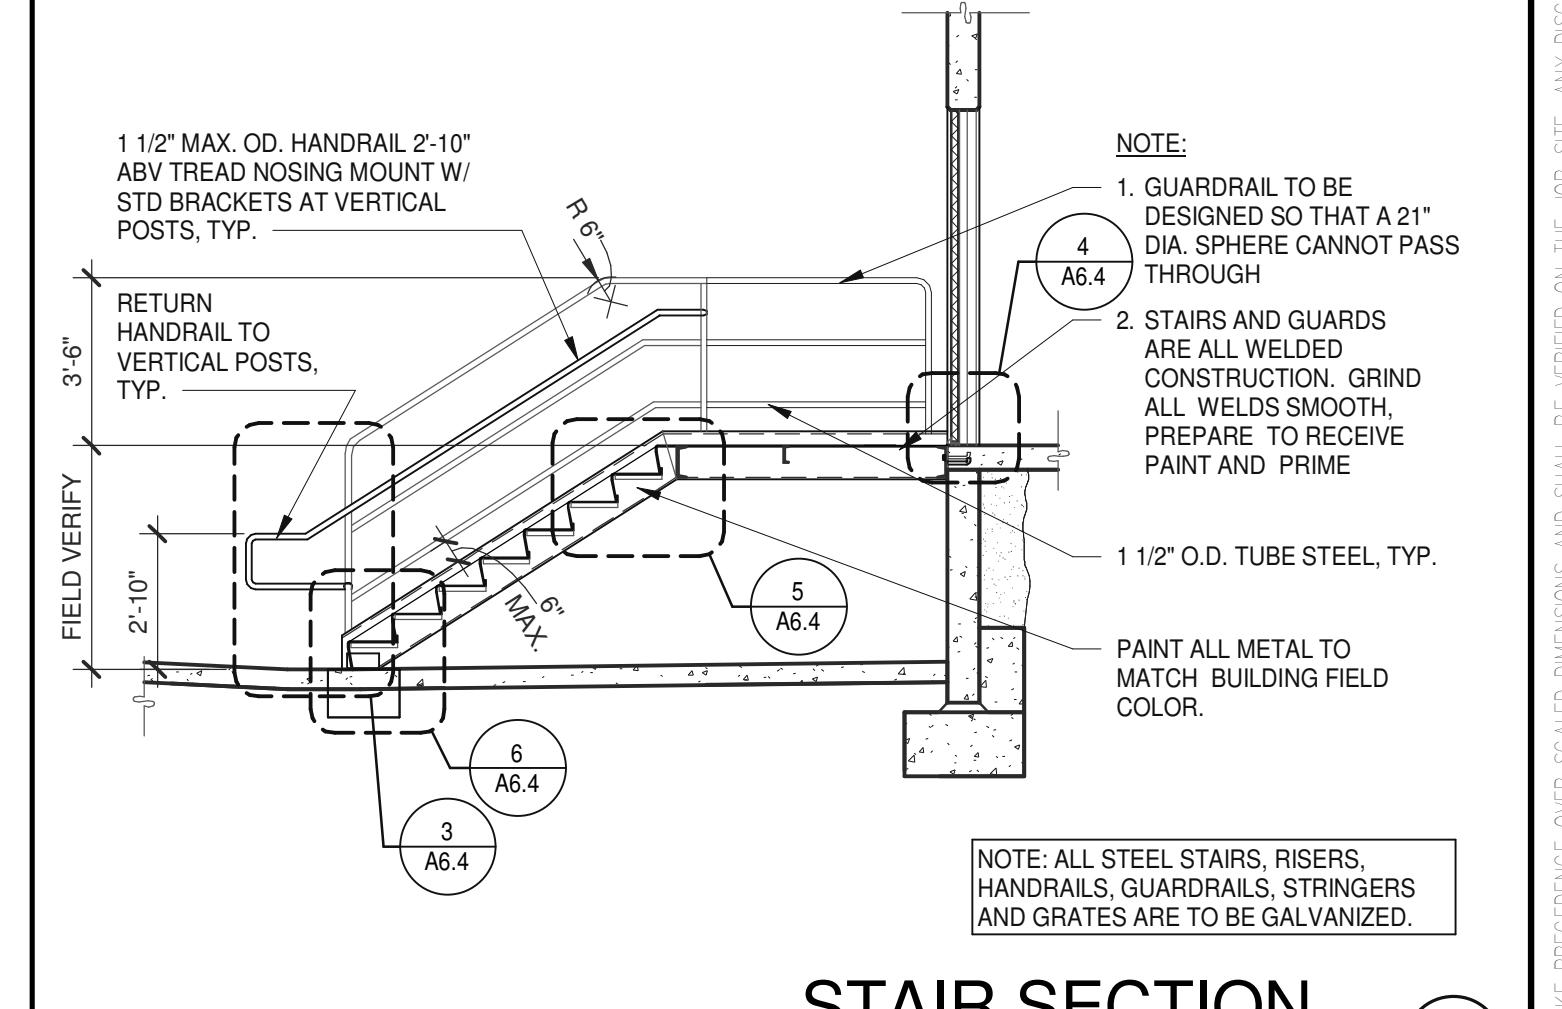DETAILS	DATE	REMARKS
1 04/03/2019	PLANNING SUBMITTAL	


P/APM:	J. BABINE
DRAWN BY::	E.S.
JOB NO.:	SNR17-0069-00

SHEET	A6.4
4	1 1/2" = 1'-0"

4/2/2019 12:49:08 PM

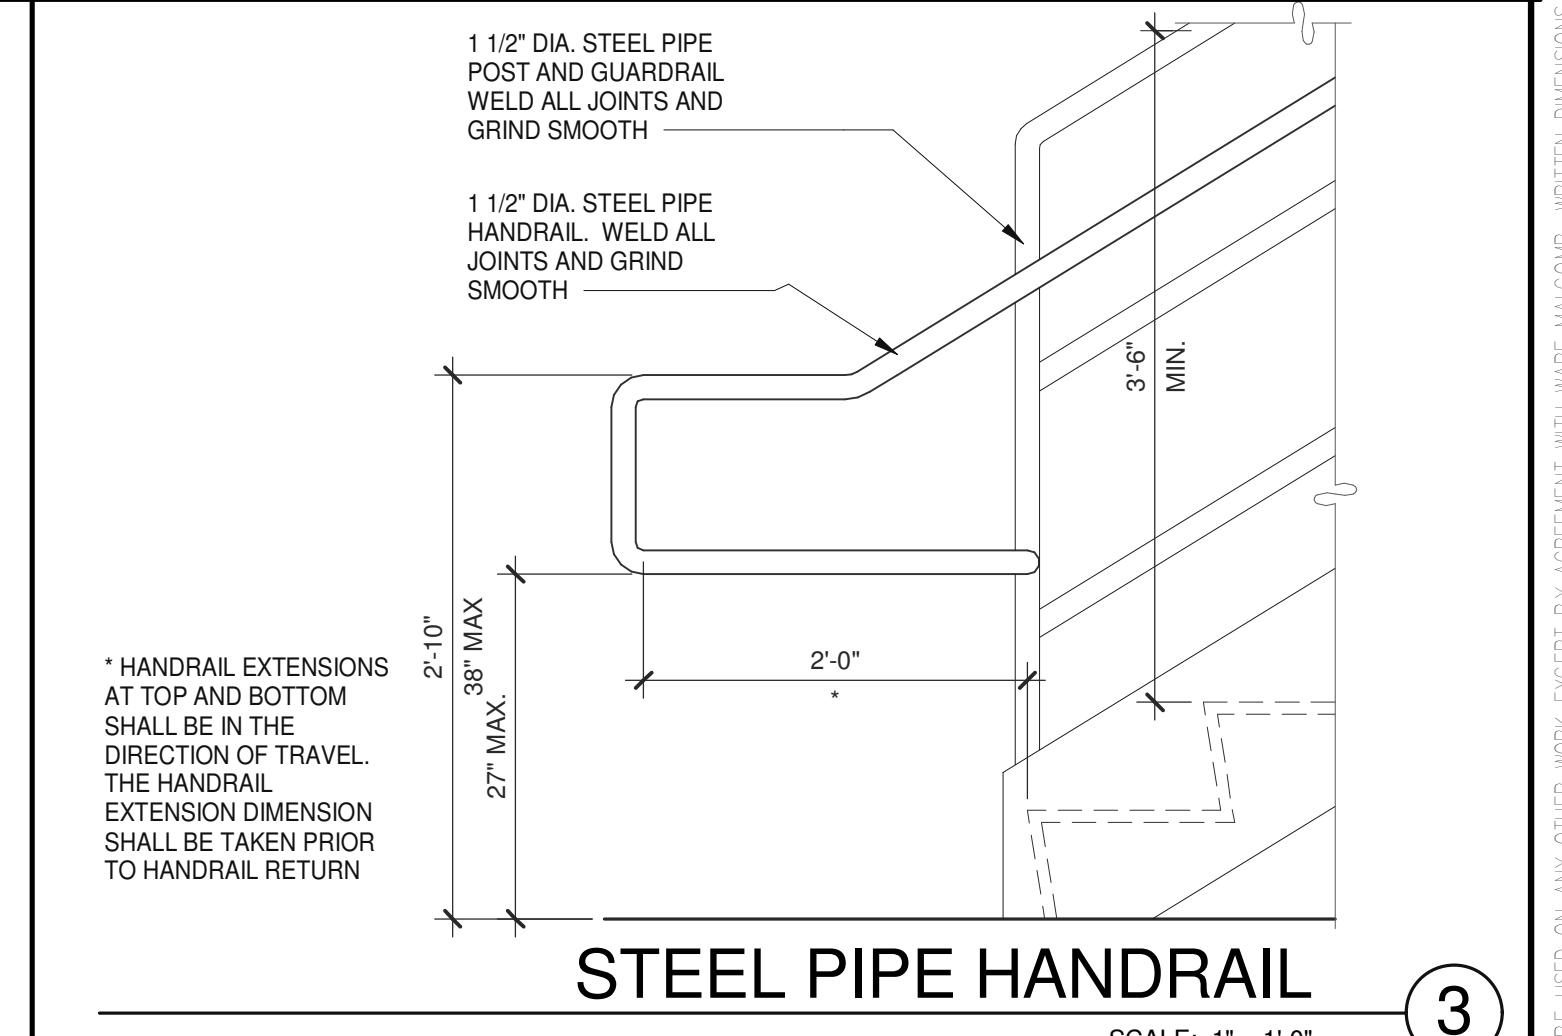


STEEL PIPE HANDRAIL

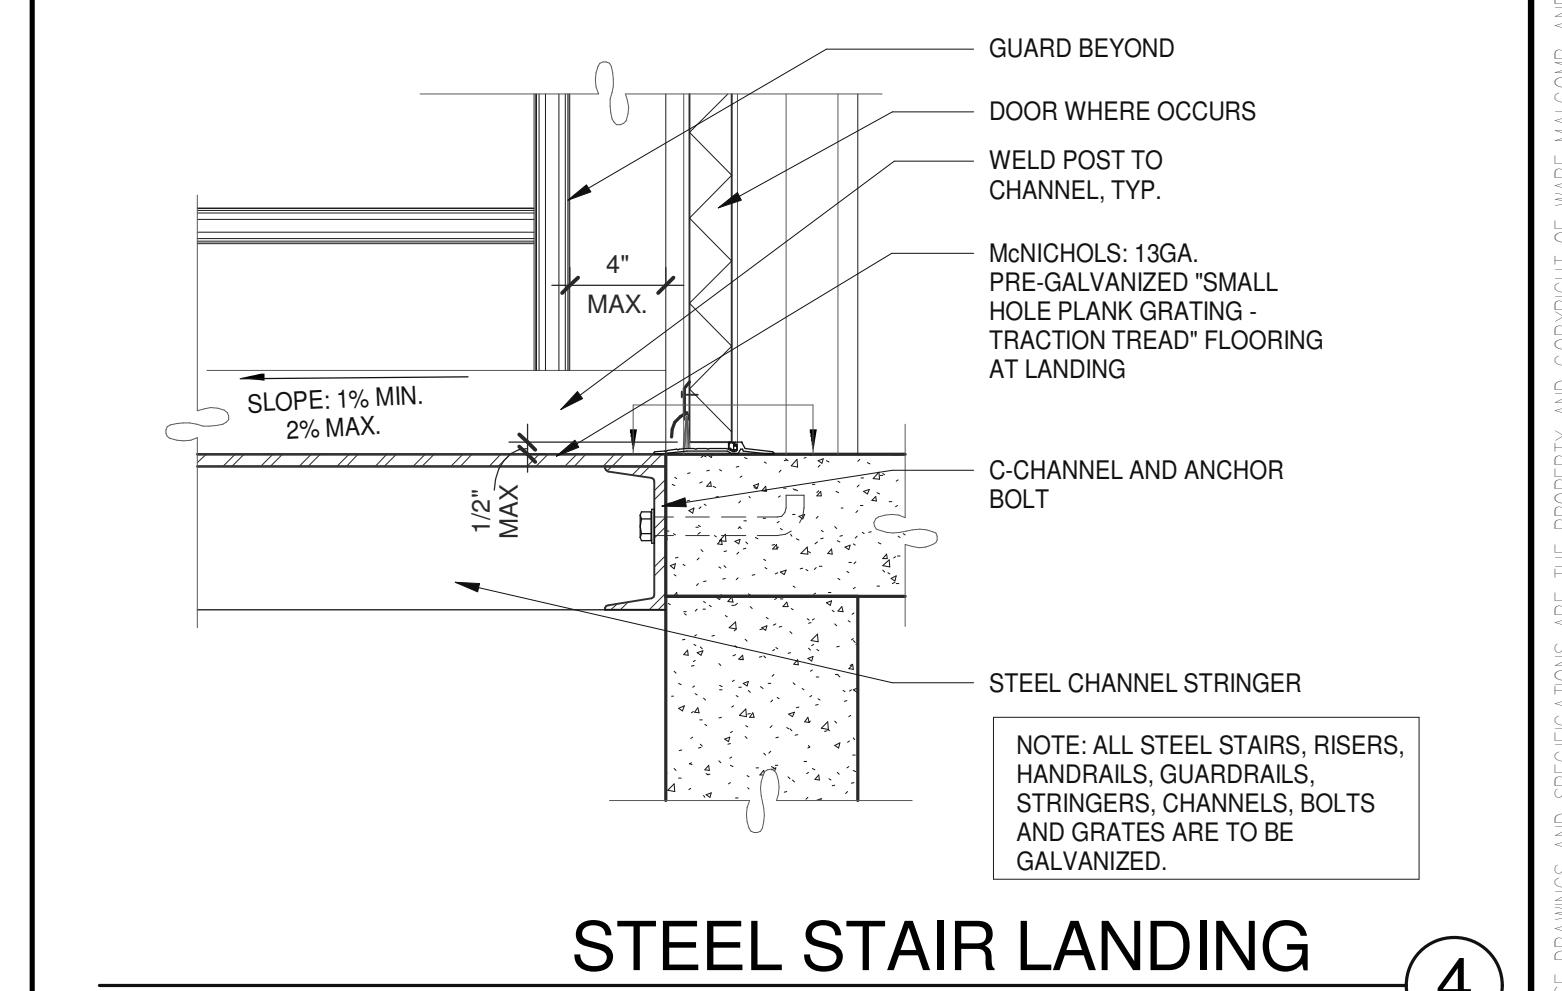

STEEL STAIR LANDING

4

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Luminaire Schedule											
Project: SUPPLYBANK.ORG - OFFICE & DISTRIBUTION FACILITY - SITE LIGHTING											
Symbol	Qty	Label	Arrangement	Lum. Lumens	Arr. Lum. Lumens	LLF	LDD	LLD	Description	Filename	Lum. Watts
<-->	10	A	BACK-BACK	20256	40512	0.850	0.900	0.944	VISIONAIRE VLX-1-T5W-96LC-5-4K-VOLT-AM-XX-(TWIN) - 28' L.C.	VLX_1_T5W_96LC_5_4K.ies	159
-->	1	A1	SINGLE	20256	20256	0.850	0.900	0.944	VISIONAIRE VLX-1-T5W-96LC-5-4K-VOLT-AM-XX-(SINGLE) - 28' L.C.	VLX_1_T5W_96LC_5_4K.ies	159
-->	3	B	SINGLE	19762	19762	0.850	0.900	0.944	VISIONAIRE VLX-1-T3-96LC-5-4K-VOLT-AM-XX-(SINGLE) - 28' L.C.	VLX_1_T3_96LC_5_4K.ies	159
-->	4	B1	SINGLE	11994	11994	0.850	0.900	0.944	VISIONAIRE VLX-1-T3-96LC-5-4K-VOLT-AM-XX-CLS-(SINGLE) - 28' L.C.	VLX_1_T3_96LC_5_4K-UNV_CLS.ies	159
-->	2	C	SINGLE	18628	18628	0.850	0.900	0.944	VISIONAIRE VLX-1-T4-96LC-5-4K-VOLT-AM-XX-(SINGLE) - 28' L.C.	VLX_1_T4_96LC_5_4K.ies	159
●	52	CA	SINGLE	22435	22435	0.850	0.900	0.944	KENALL EPLB-22-E-XX-CA-XX-192L-40K8-DCC-VOLT - 26' A.F.G.	EPLB-22-E-CA-GW-192L-40K8-DCC-DV.ies	209
-->	1	D	SINGLE	19451	19451	0.850	0.900	0.944	VISIONAIRE VLX-1-T2-96LC-5-4K-VOLT-AM-XX-(SINGLE) - 28' L.C.	VLX_1_T2_96LC_5_4K.ies	159
●	7	E	SINGLE	1076	1076	0.850	0.900	0.944	BEGA 55 925 - 12.7W-KX - 16.5' A.F.G.	55925.ies	15.5
●	4	E1	SINGLE	2986	2986	0.850	0.900	0.944	BEGA 55 929 - 26.8W-KX - 29' A.F.G.	55929.ies	42
○	26	F	SINGLE	1980	1980	0.850	0.900	0.944	BEGA 66 976 - 15.7W-KX - 16.5' M.H.	66976.ies	19
○	4	G	SINGLE	2370	2370	0.850	0.900	0.944	BEGA 99075 - 50.6W-KX - 14.5' L.C.	99075.ies	57
-->	10	ST	SINGLE	12757	12757	0.900	0.900	1.000	SIGNIFY LUMEC RFM-108W48LED4K-G2-R2M-UNV - 30' L.C. + 6' ARM	RFM-108W48LED4K-G2-R2M.ies	106
-->	11	WA	SINGLE	11558	11558	0.850	0.900	0.944	VISIONAIRE VSC-1-T4-32LC-10-4K-UNV-WM-XX - 28' & 25' M.H.	VSC-1_T4_32LC_10_4K.ies	112
-->	8	WB	SINGLE	11715	11715	0.850	0.900	0.944	VISIONAIRE VSC-1-T2-32LC-10-4K-UNV-WM-XX - 28' & 25' M.H.	VSC-1_T2_32LC_10_4K.ies	112
-->	2	WC	SINGLE	11810	11810	0.850	0.900	0.944	VISIONAIRE VSC-1-T3-32LC-10-4K-UNV-WM-XX - 28' M.H.	VSC-1_T3_32LC_10_4K.ies	112
-->	4	WD	SINGLE	5858	5858	0.850	0.900	0.944	VISIONAIRE VSC-1-T2-16LC-10-4K-UNV-WM-XX - 16' M.H.	VSC-1_T2_16LC_10_4K.ies	56

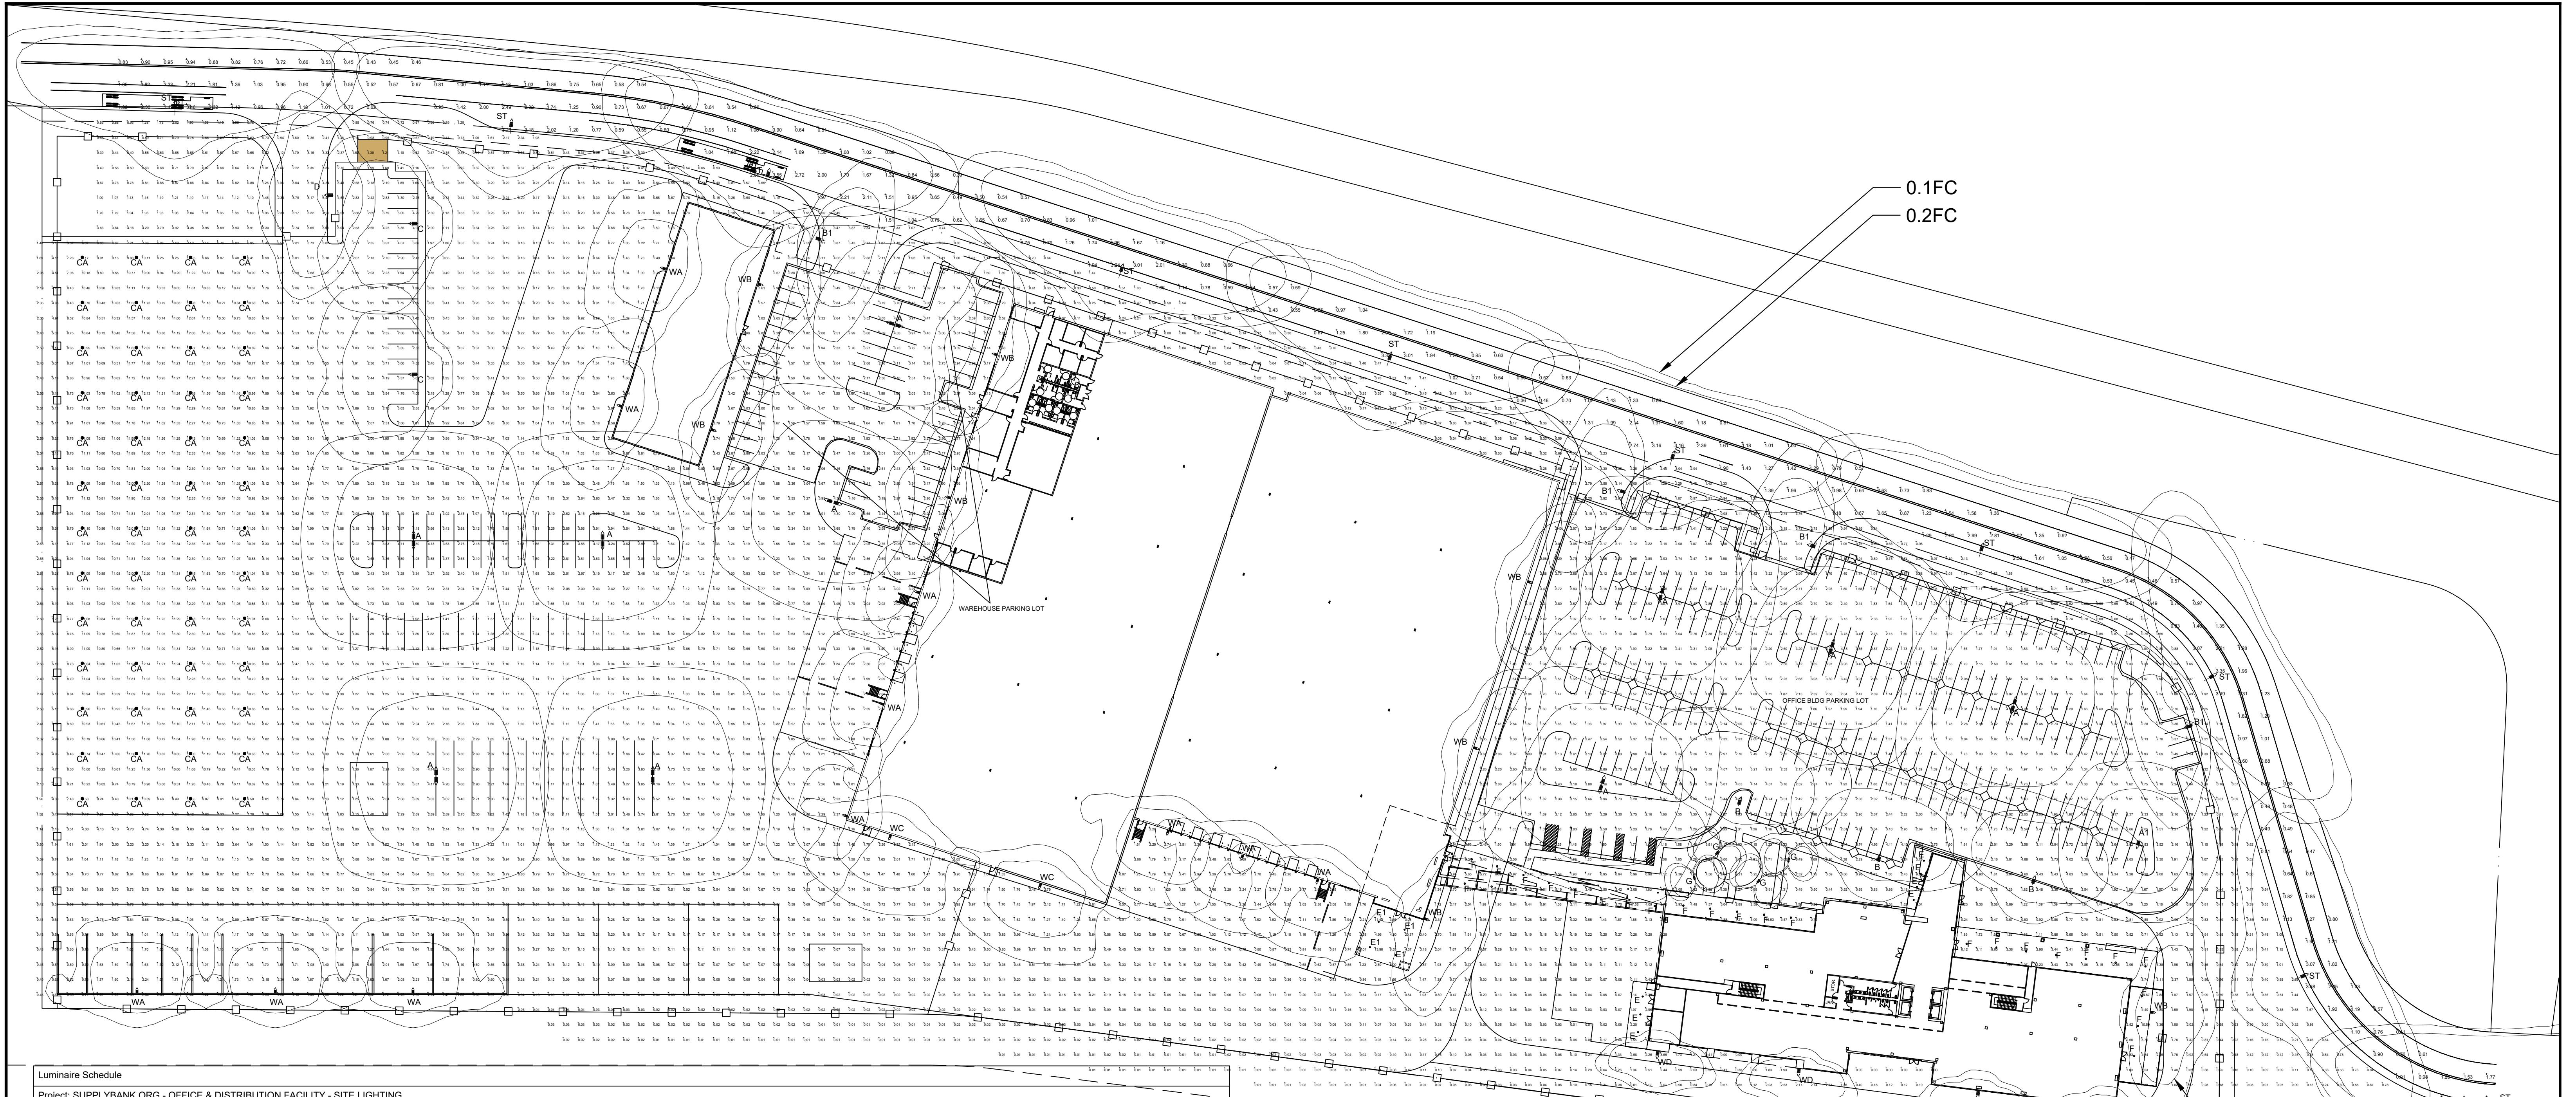\*\*OFFICE & DIST. FACILITY / EBMUD - SITE LIGHTING\*\*

\*\*\*LIGHTING LAYOUT RECOMMENDATION\*\*\*

ALL VALUES SHOWN ARE MAINTAINED HORIZONTAL FOOTCANDLES AT GRADE  
\*\*\*\*\*  
PHOTOMETRIC DATA USED AS INPUT FOR THESE CALCULATIONS IS BASED ON ESTABLISHED IES PROCEDURES AND PUBLISHED LAMP, RATINGS, FIELD PERFORMANCE WILL DEPEND ON ACTUAL LAMP, BALLAST, ELECTRICAL AND SITE CHARACTERISTICS.  
\*\*\*\*\*


Calculations have been performed according to IES standards and good practice. Some differences between measured values and calculated results may occur due to tolerances in calculation methods, testing procedures, component performance, measurement techniques and field conditions such as voltage and temperature and temperature variations. Input data used to generate the attached calculations such as room dimensions, reflectances, furniture and architectural elements significantly affect the lighting calculations. If the real environment conditions do not match the input data, differences will occur between measured values and calculated values.

**Associated Lighting Representatives, Inc.**  
**ALR**  
ASSOCIATED LIGHTING REPRESENTATIVES, INC.  
7777 PARTEE LANE  
P.O. BOX 2265  
OAKLAND, CA 94621  
PHONE: (510) 638-3800 - FAX (510) 638-2908


REPORT FOR: WARE MALCOLM  
BY: APPLICATIONS ENGINEERING: GILBERTO J. RODRIGUEZ  
SALES REPRESENTATIVE: ALR, CATHY JOHNSON  
  
AGI32 VERSION 19.3  
AGI (C) 1999-2019 LIGHTING ANALYSIS, INC.  
10268 W. CENTENNIAL ROAD - SUITE 202  
LITTLETON, CO 80127

PROJECT DESCRIPTION  
**SUPPLYBANK.ORG - OFFICE & DIST. FACILITY**  
OAKLAND, CA  
  
DRAWING NO. / INPUT FILE  
**16429GOT-R3.DWG / .AGI**  
SCALE **1" = 50'** SHEET **1 OF 1** DATE **01.18.2019** REV **3**  
**PS1.0**

## MATCH LINE SEE SHEET L1.3

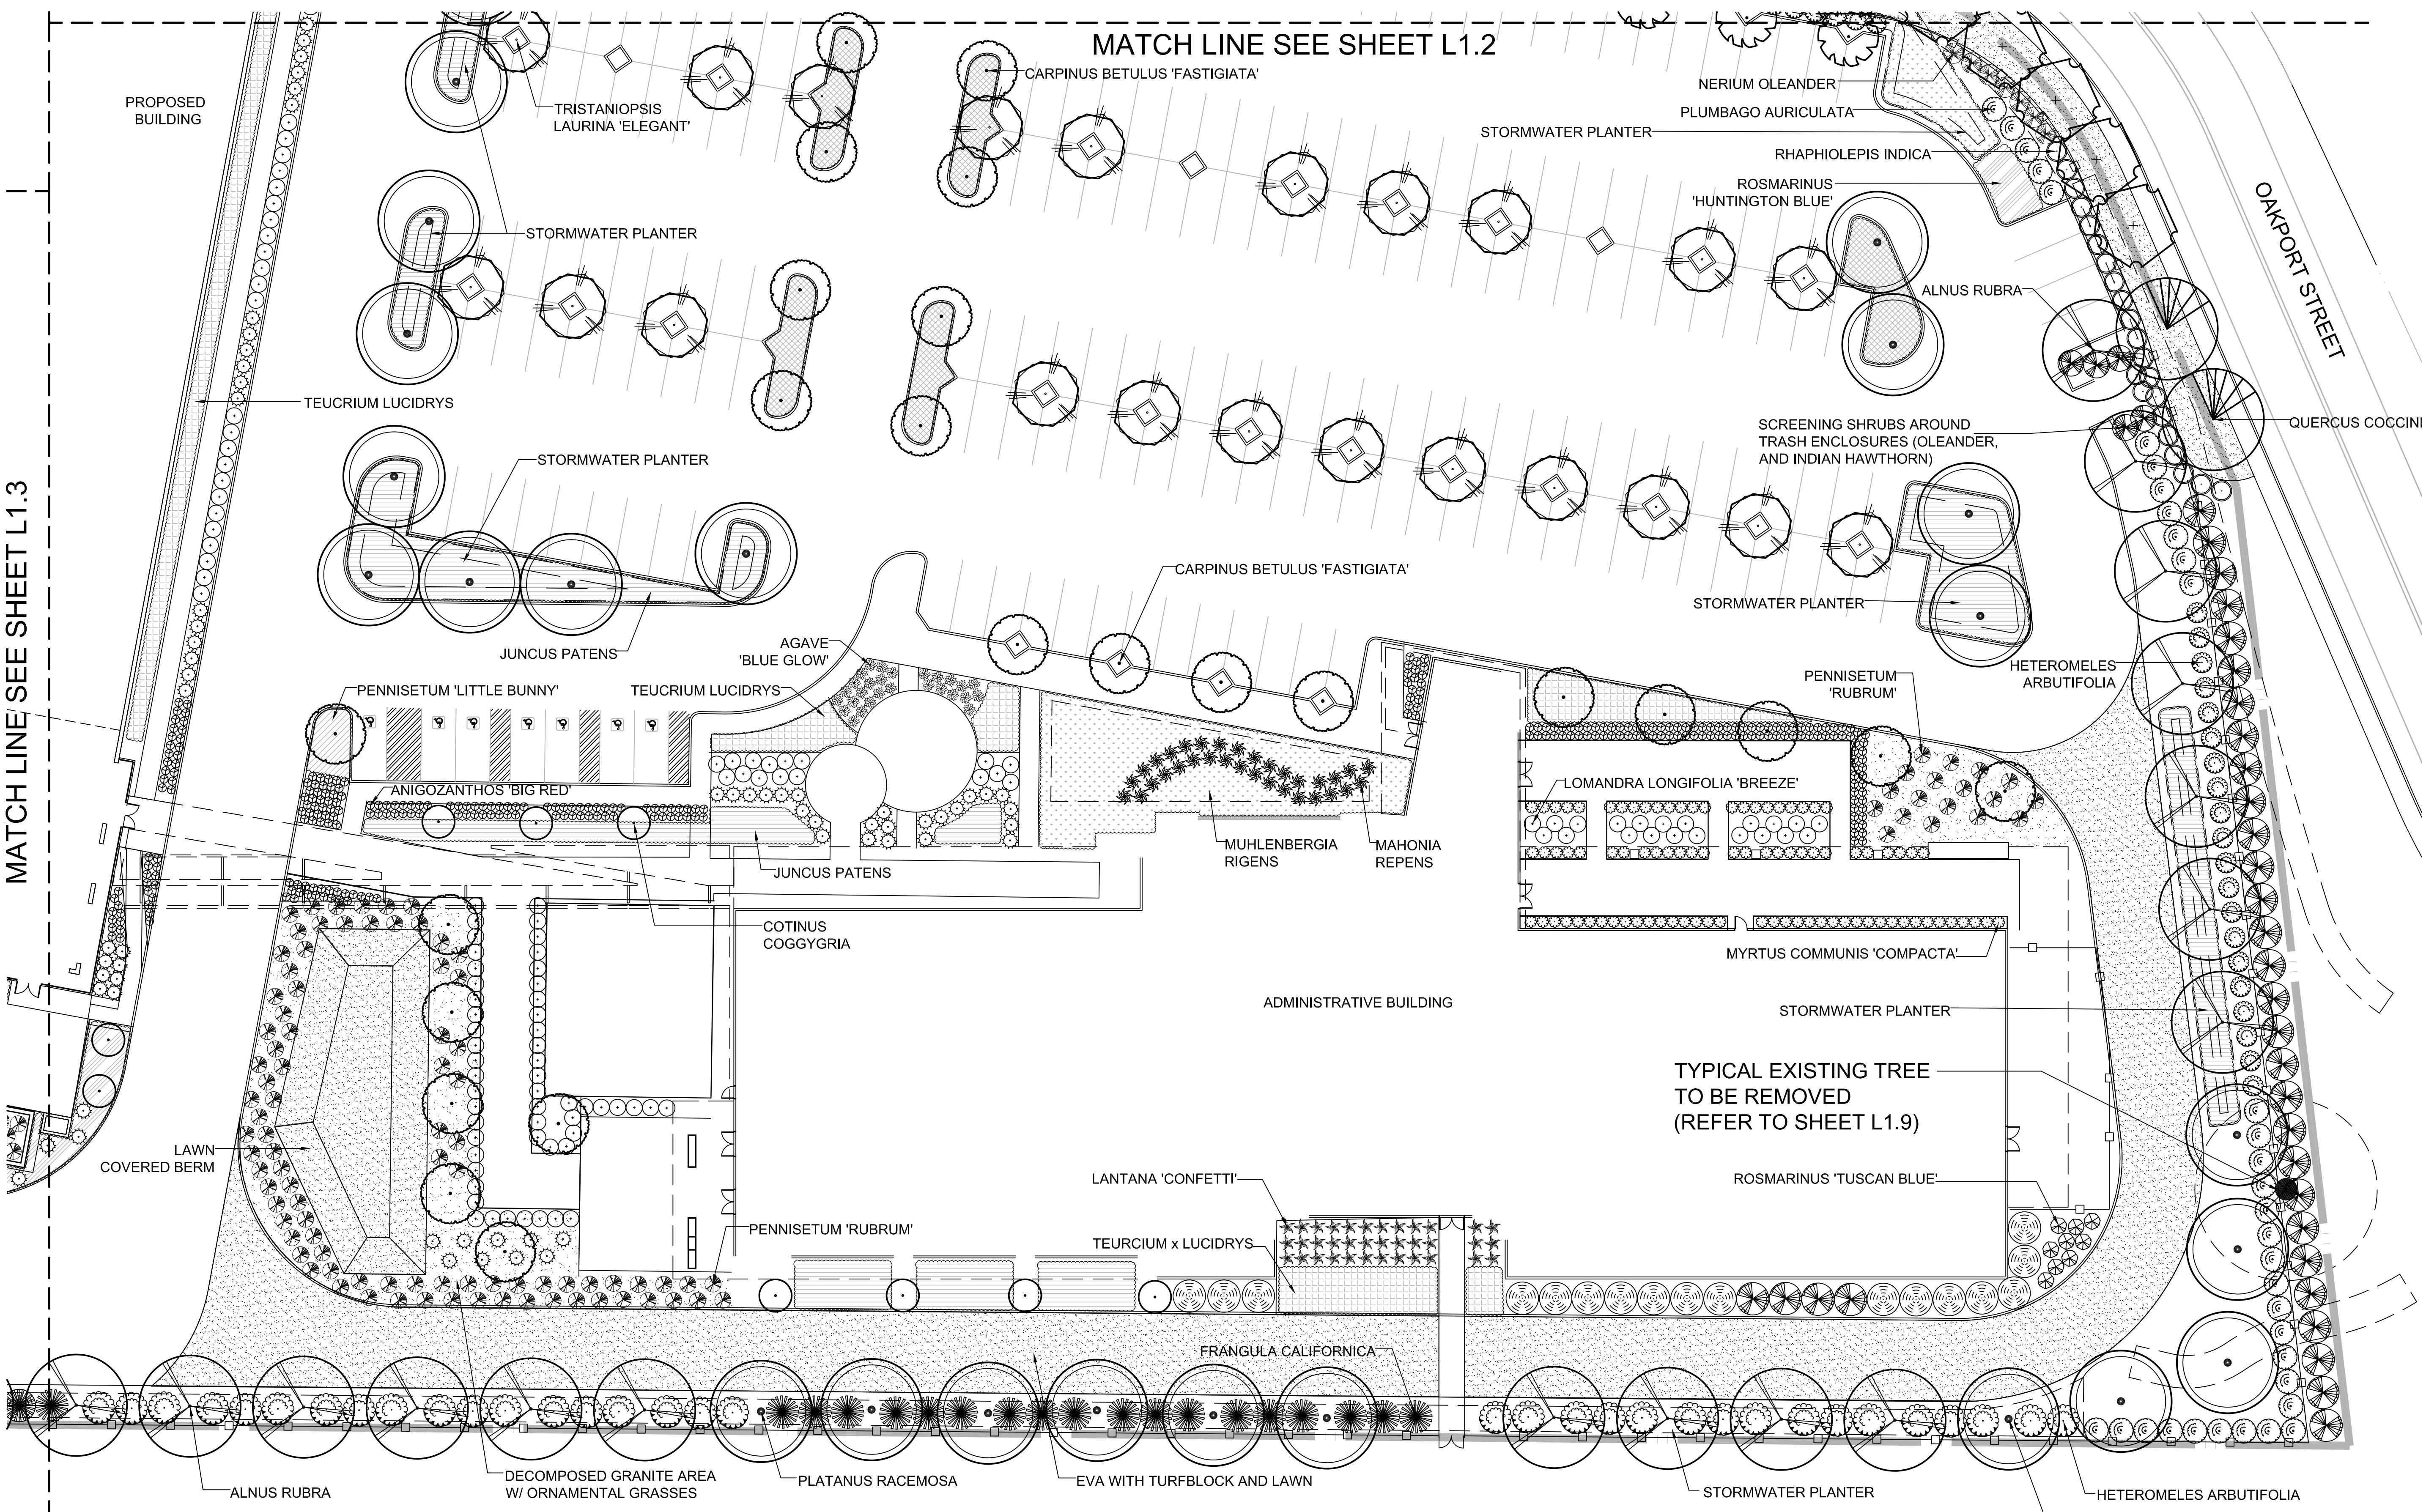

REFER TO SHEET L1.8 FOR PLANT LEGEND

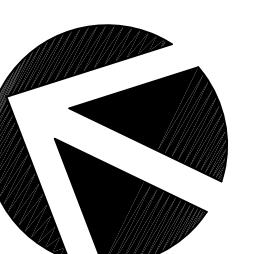

GRAPHIC SCALE  
20 0 10 20 40 80  
( IN FEET )  
1 inch = 20 ft.

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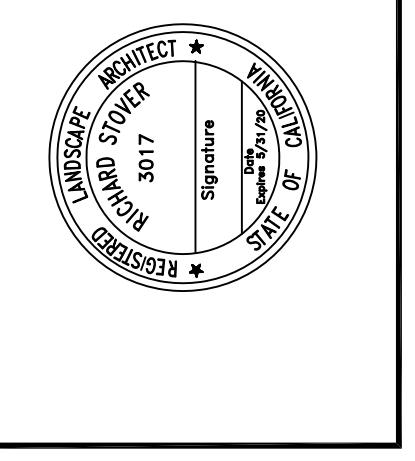
PA / PM:	J. BABINE
DRAWN BY:	
JOB NO.:	SNR17-0069-00

SHEET  
**L1.1**


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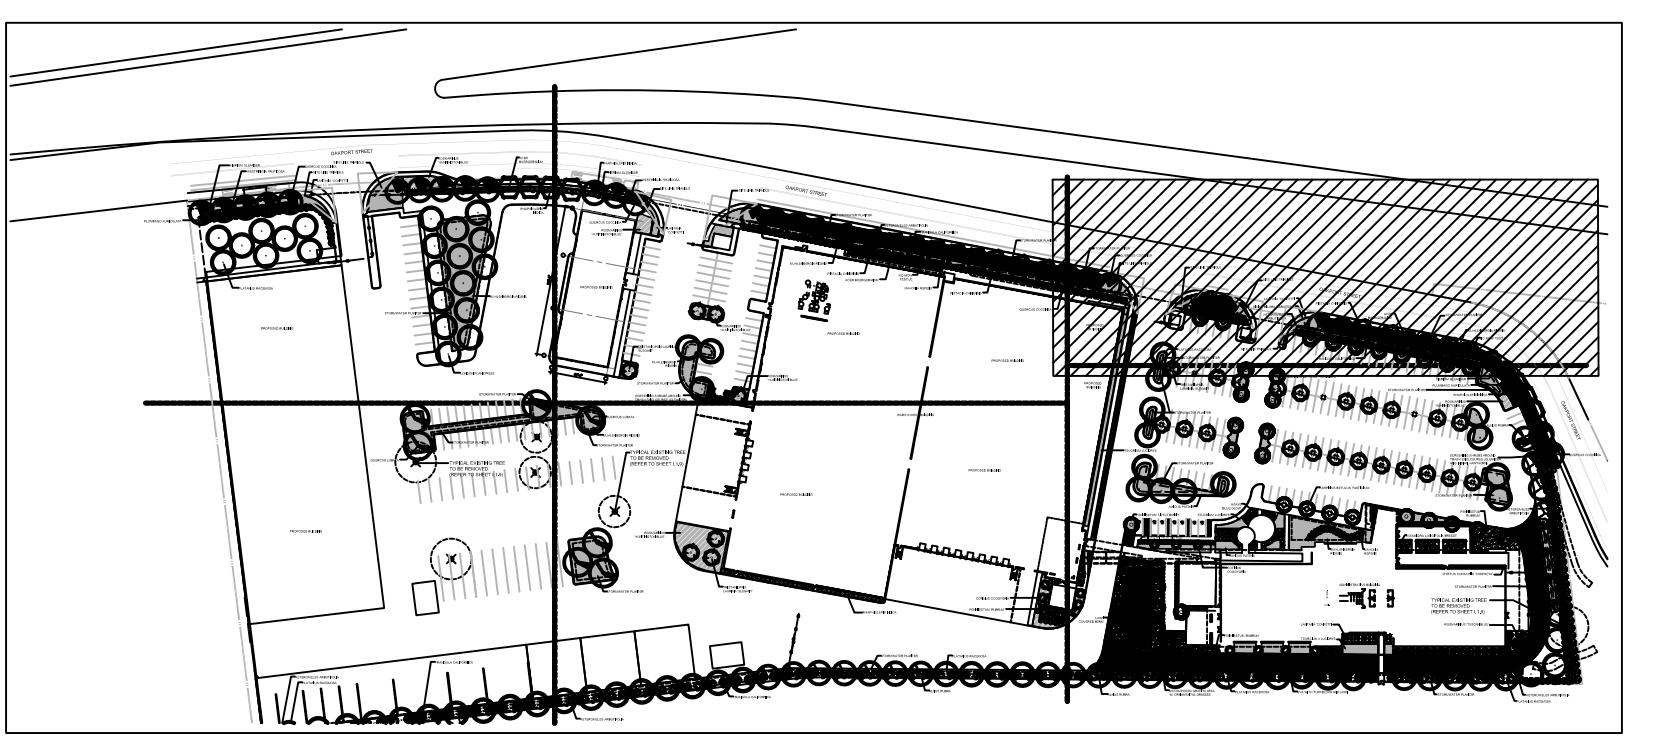
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planning  
interiors  
civil engineering  
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MATCH LINE SEE SHEET L1.4




MATCH LINE SEE SHEET L1.1



# SITE MAP

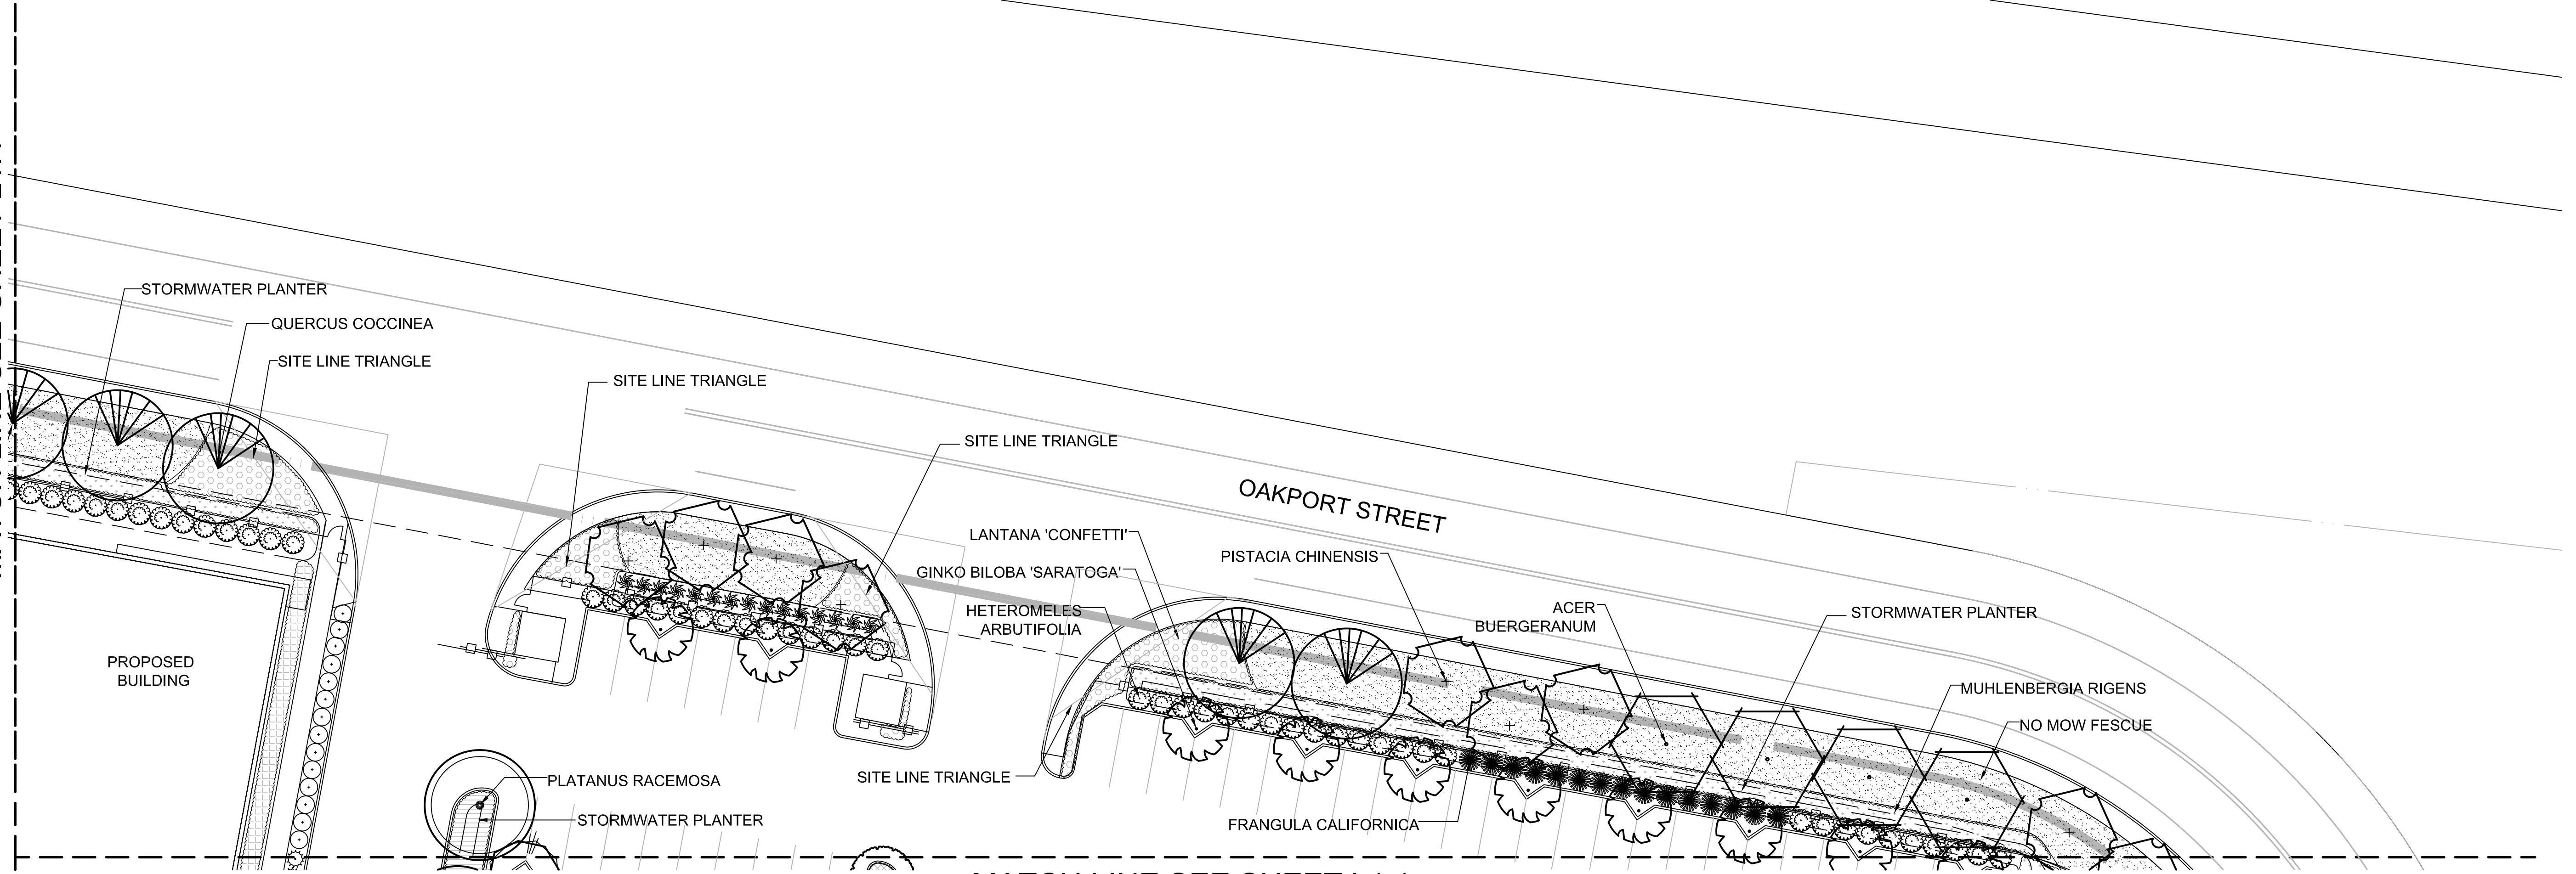
REFER TO SHEET L1.8 FOR PLANT LEGEND

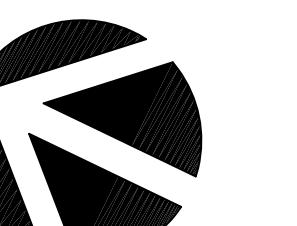

## GRAPHIC SCALE

A horizontal scale drawing of a bridge deck. The drawing features a cross-hatch pattern of black and white squares along the left edge. Above the drawing, numerical markings are placed at 20, 0, 10, 20, 40, and 80. Below the drawing, the text "( IN FEET )" is centered, followed by "1 inch = 20 ft." A dashed diagonal line extends from the top right corner of the drawing towards the bottom left.

## **RELIMINARY PLAN**

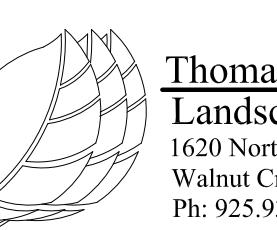

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h Main Street, Suite 4  
reek, CA 94596  
33.2583

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I BY:	
O.:	SNR17-0069-00

SHEET  
L1.2

MATCH LINE SEE SHEET L1.5

MATCH LINE SEE SHEET L1.4

WAREHOUSE BUILDING

PROPOSED BUILDING

MATCH LINE SEE SHEET L1.1

HEDYOTIS ESCULENS (CLEARLAND)

QUERCUS LOBATA  
MUHLENBERGIA RIGENS  
STORMWATER PLANTER

TYPICAL EXISTING TREE  
TO BE REMOVED  
(REFER TO SHEET L1.9)

PROPOSED BUILDING

ROSMARINUS

'HUNTINGTON BLUE'

STORMWATER PLANTER

TRISTANIOPSIS  
LAURINA 'ELEGANT'

RHAPHIOLEPIS INDICA

COTINUS COGGYRIA  
PENNISETUM 'RUBRUM'


STORMWATER PLANTER

PLATANUS RACEMOSA

ALNUS RUBRA

FRANGULA CALIFORNICA

HETEROMELES ARbutifolia

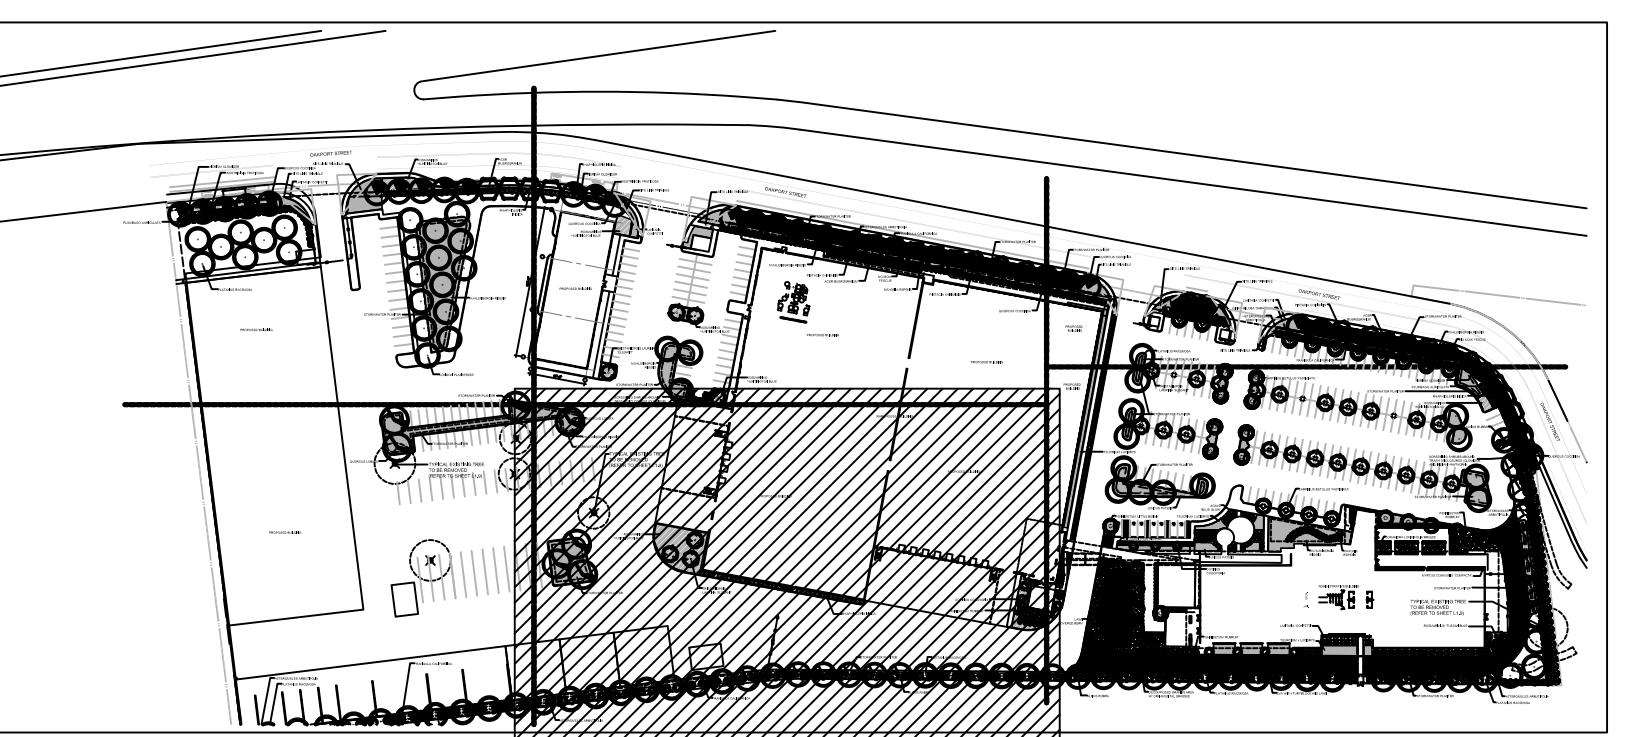


SITE MAP


REFER TO SHEET L1.8 FOR PLANT LEGEND



GRAPHIC SCALE

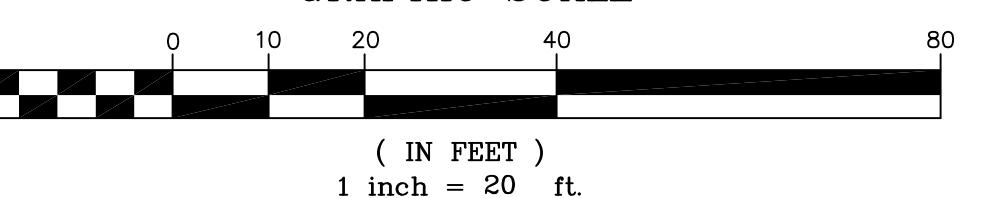

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SHEET

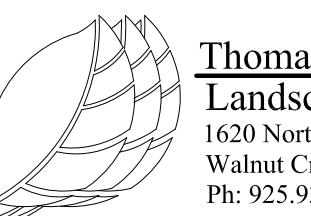L1.3

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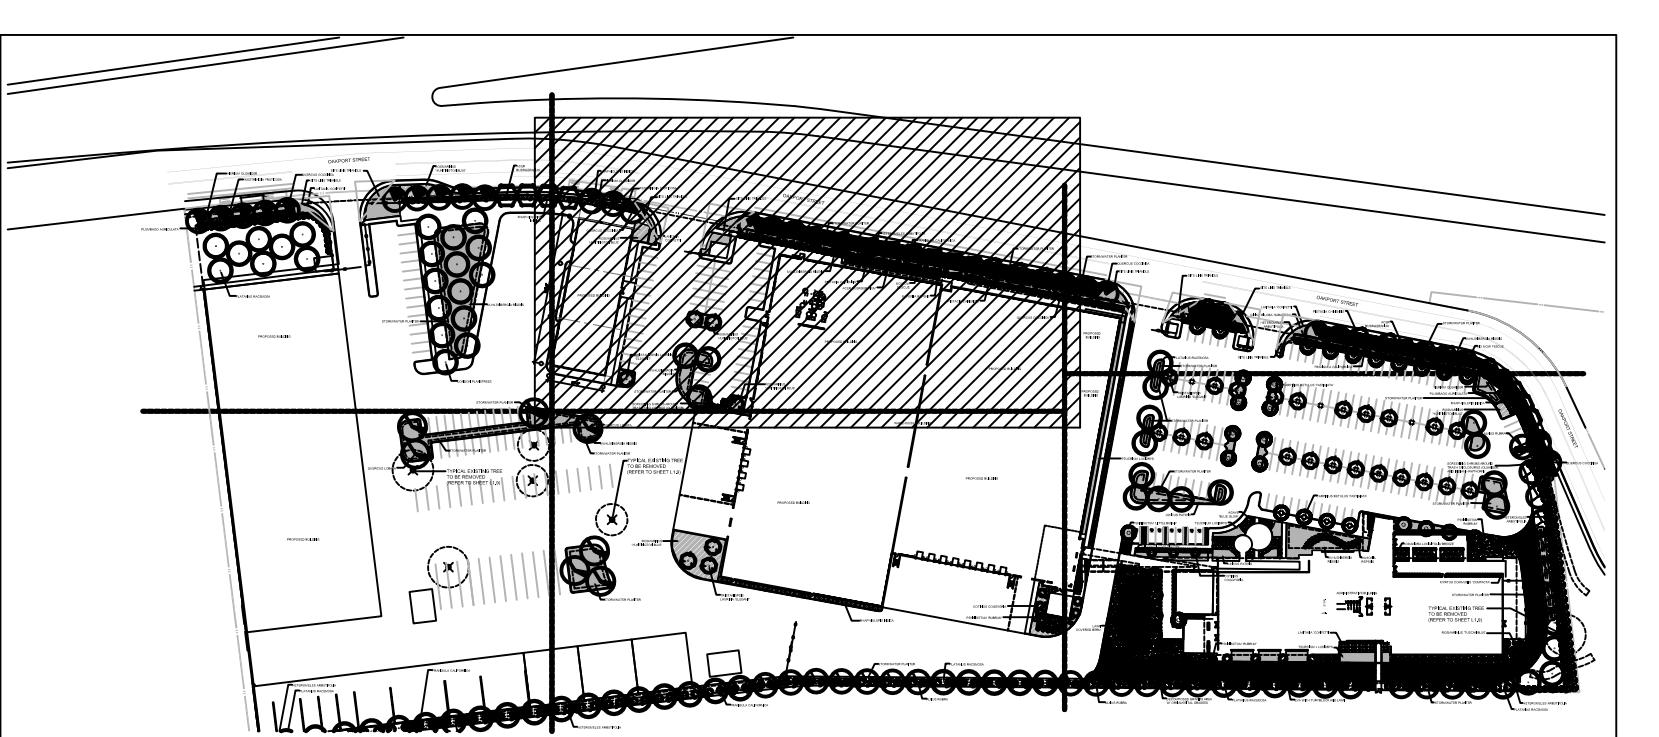
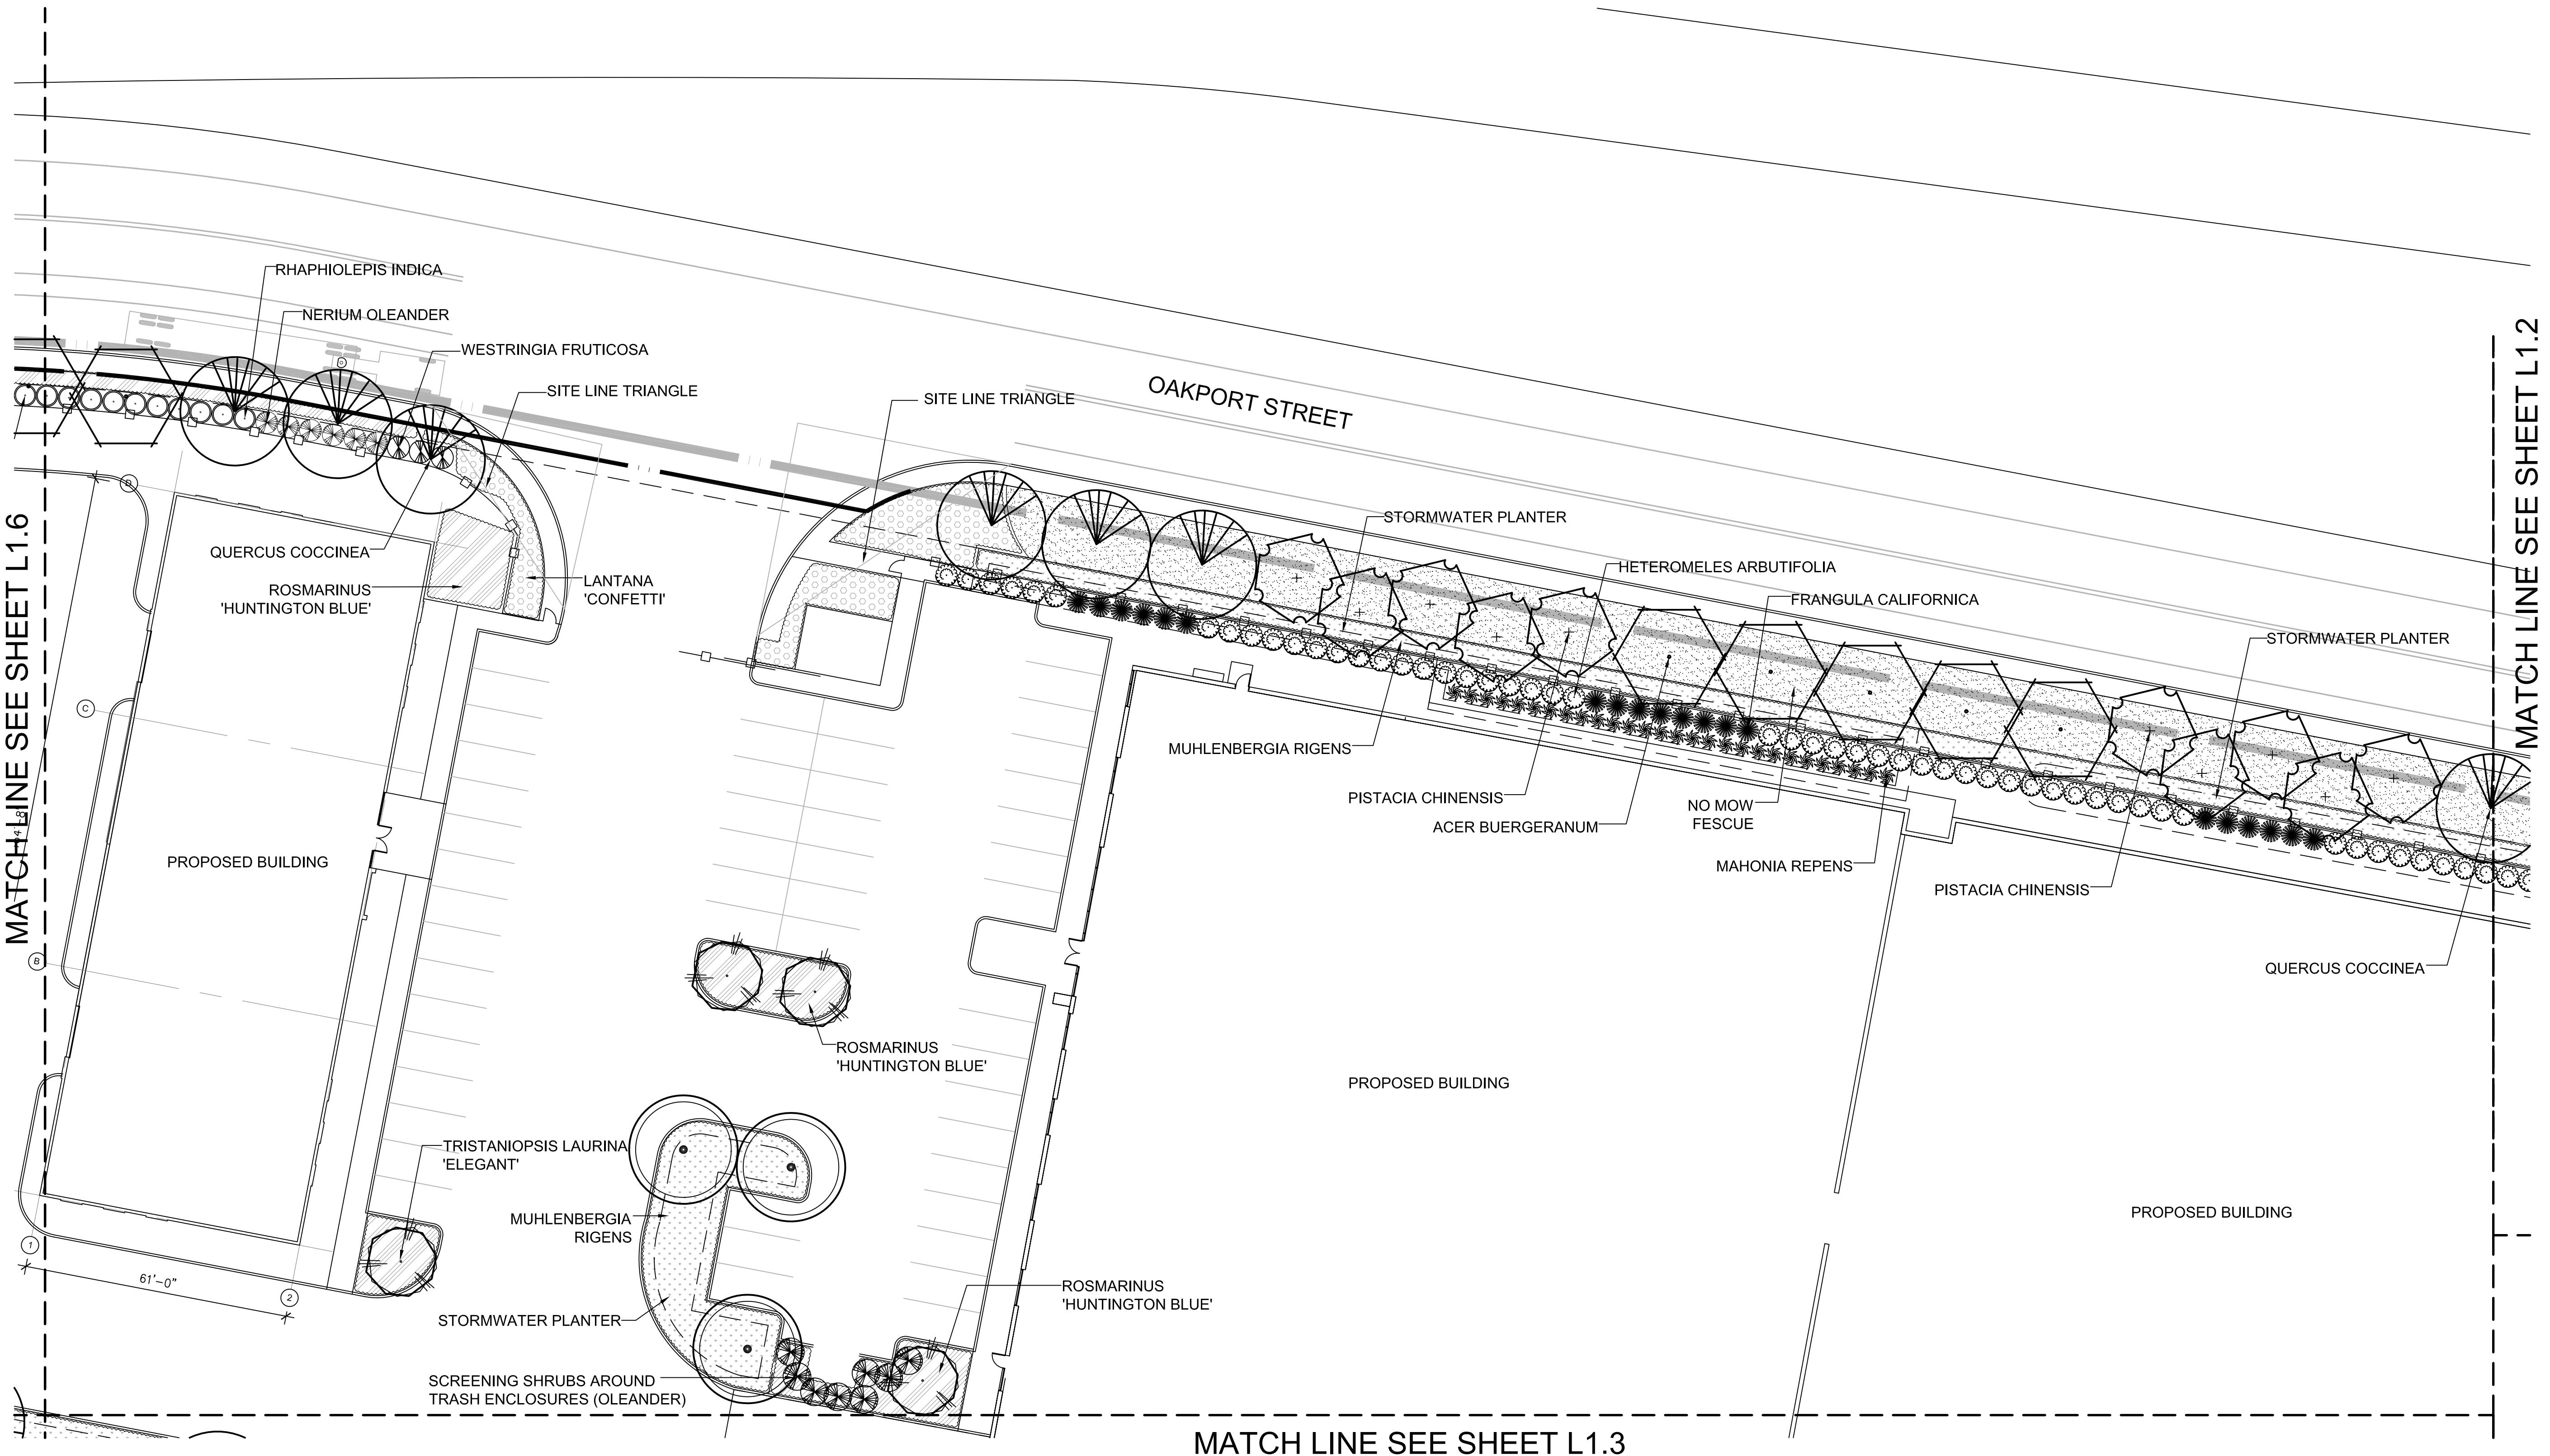
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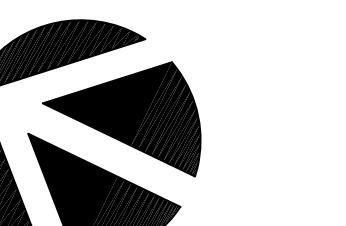
DATE	REMARKS
01/30/2019	PLANNING SUBMITTAL
04-03-19	

PA / PM:	J. BABINE
DRAWN BY:	
JOB NO.:	SNR17-0069-00


SHEET
L1.4



REFER TO SHEET L1.8 FOR PLANT LEGEND





GRAPHIC SCALE

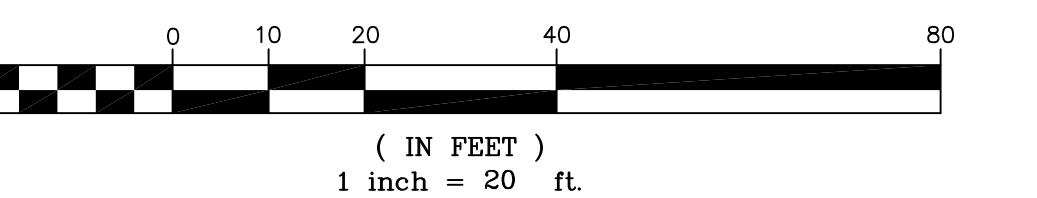


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Landscape Architects  
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Walnut Creek, CA 94596  
Ph: 925.933.2583

PRELIMINARY PLAN


MATCH LINE SEE SHEET L1.6

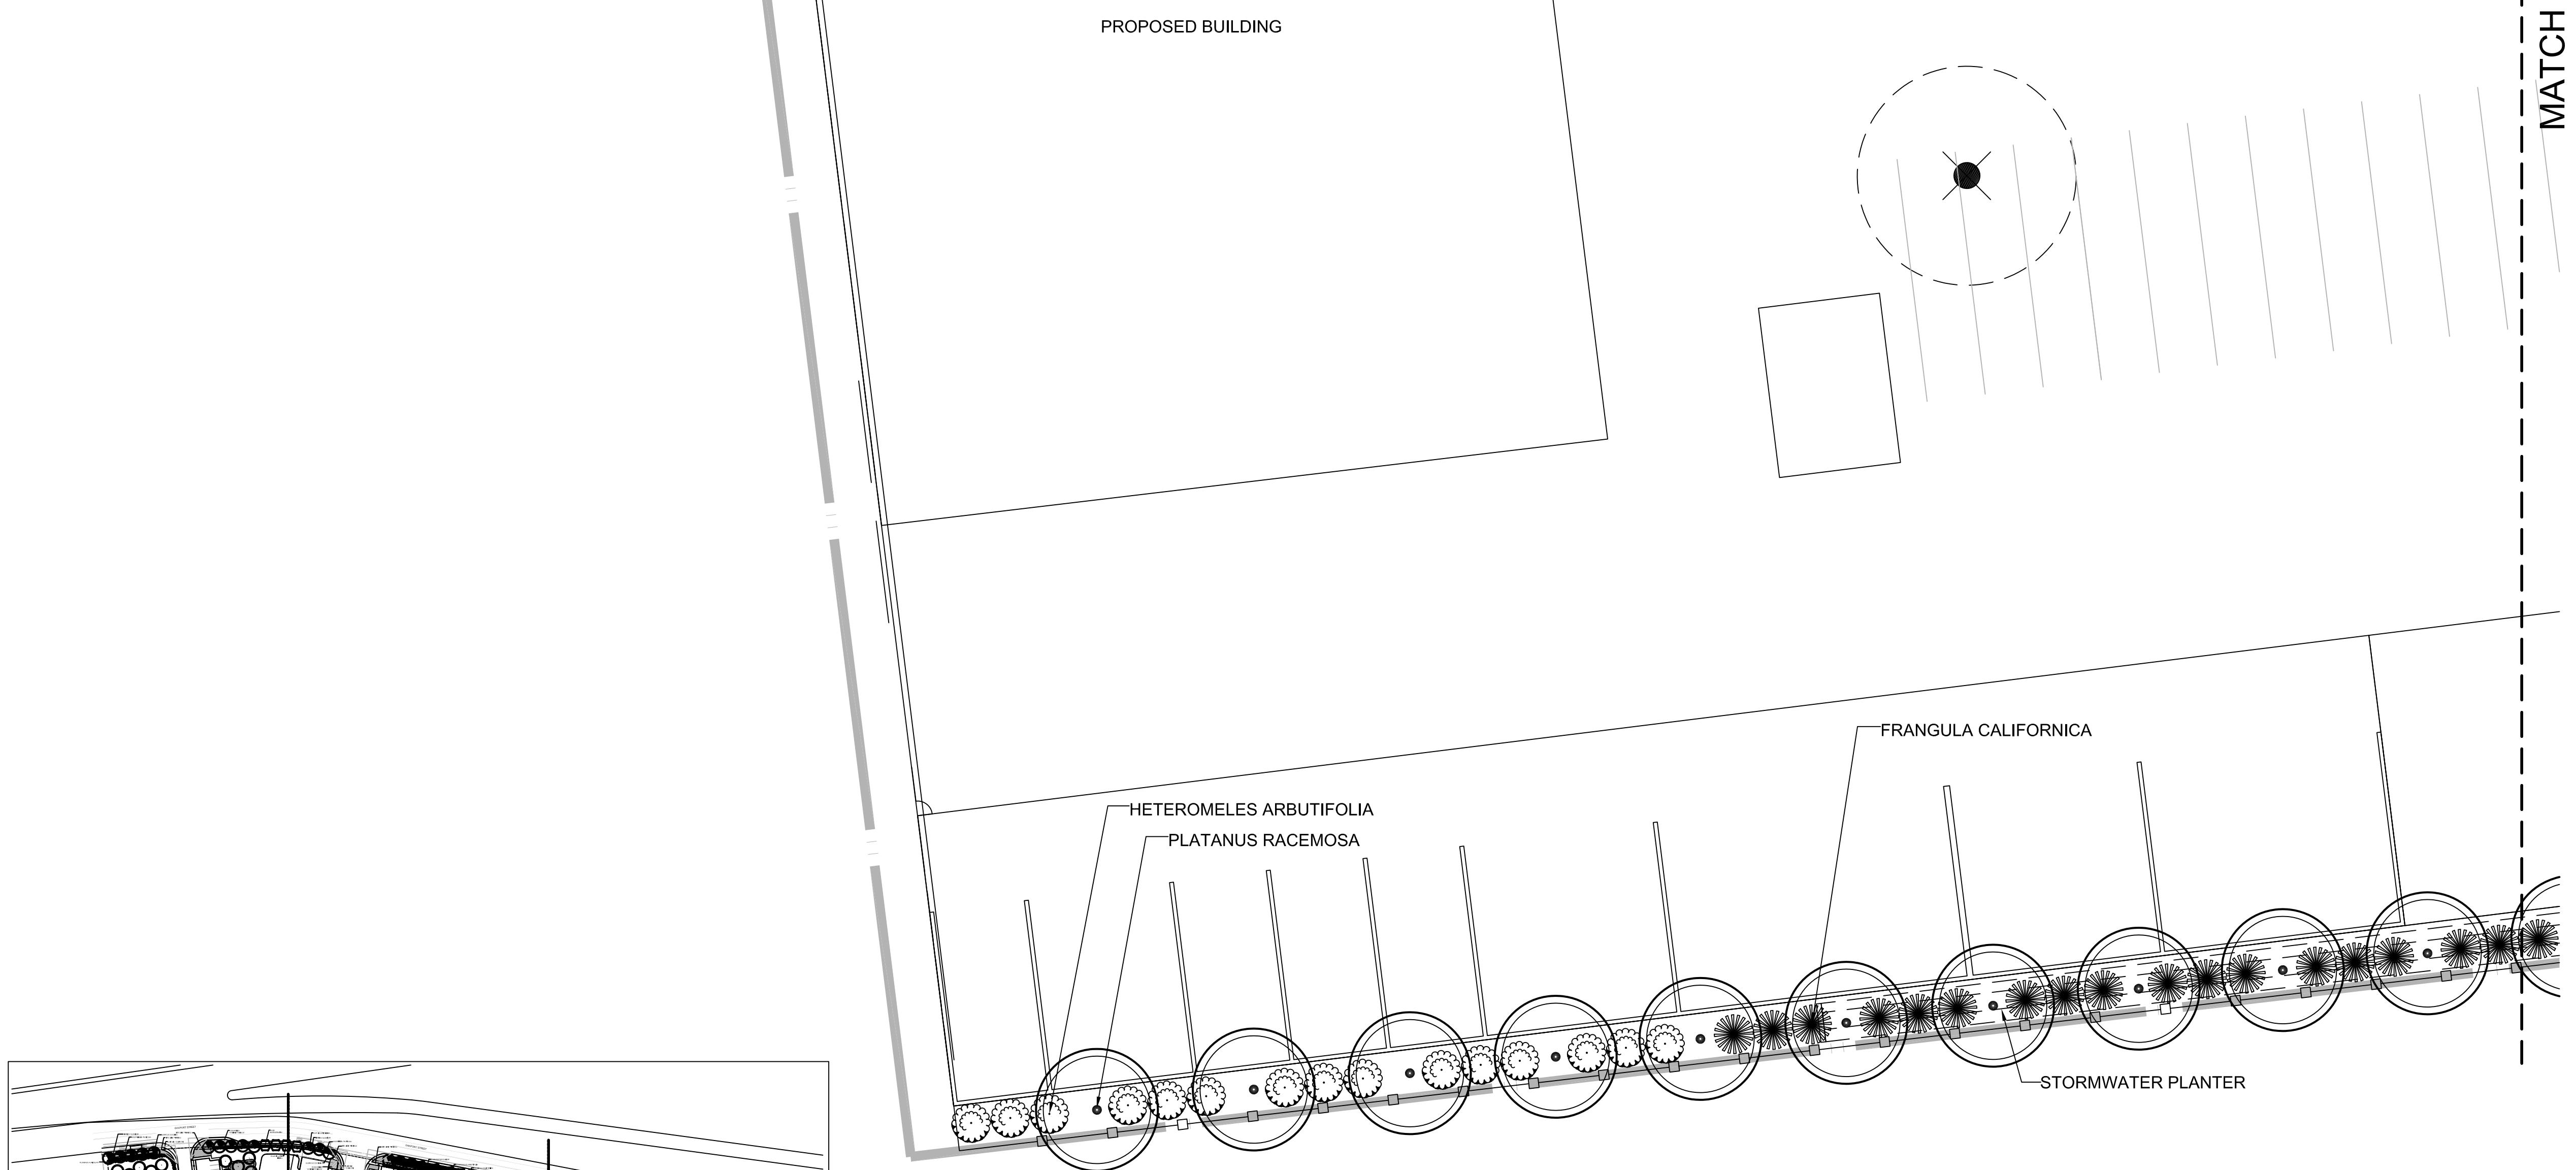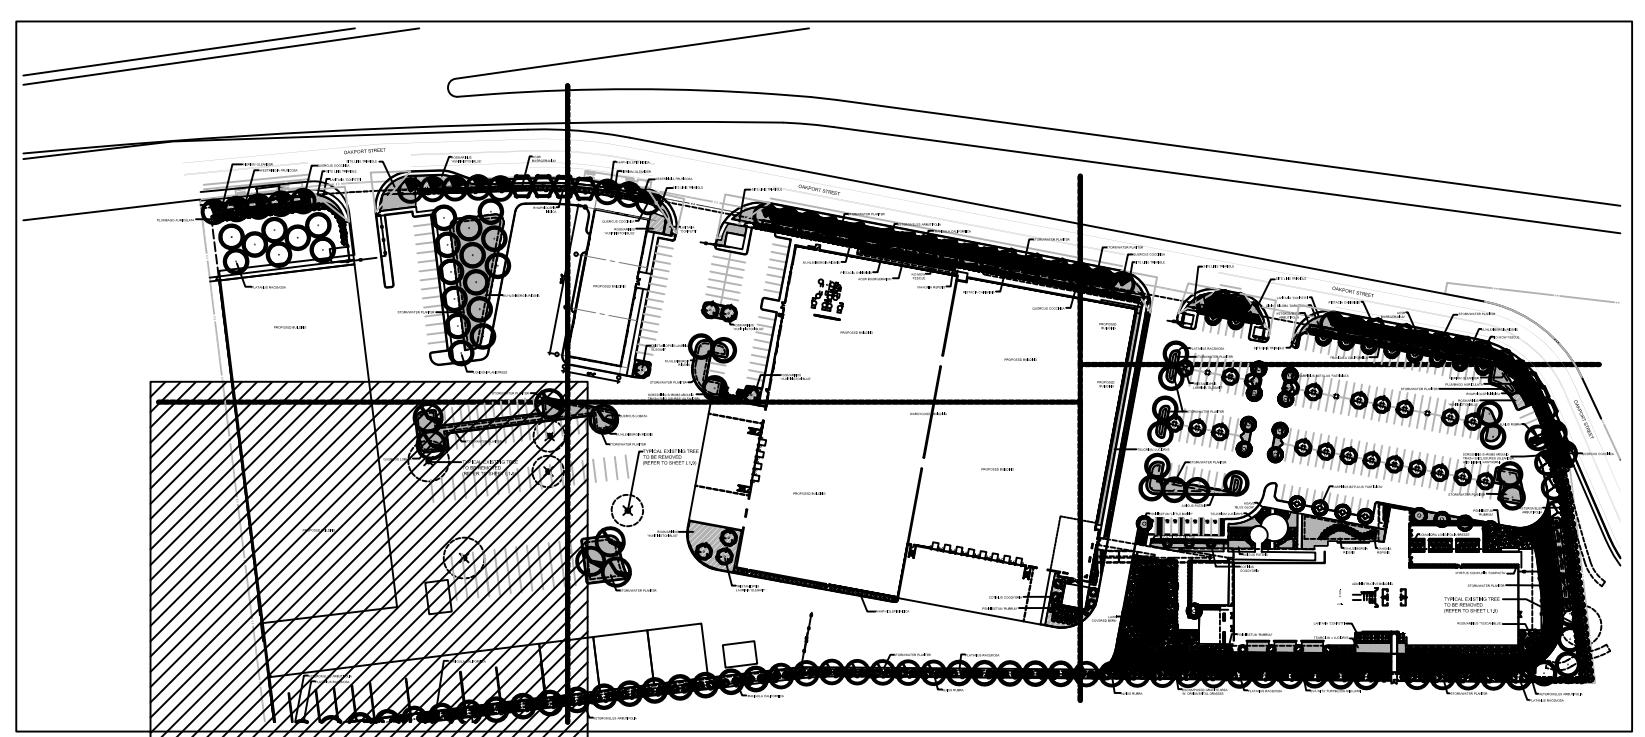

REFER TO SHEET L1.8 FOR PLANT LEGEND

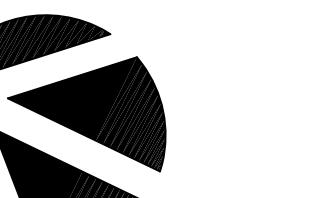

GRAPHIC SCALE

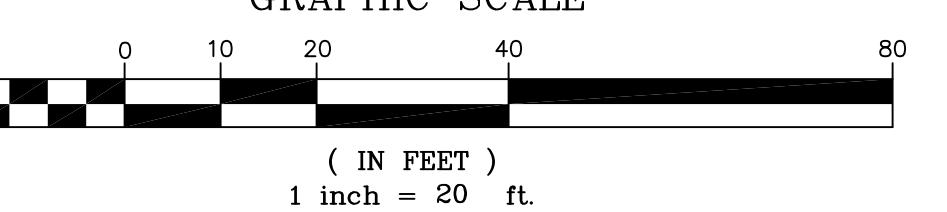


PRELIMINARY PLAN



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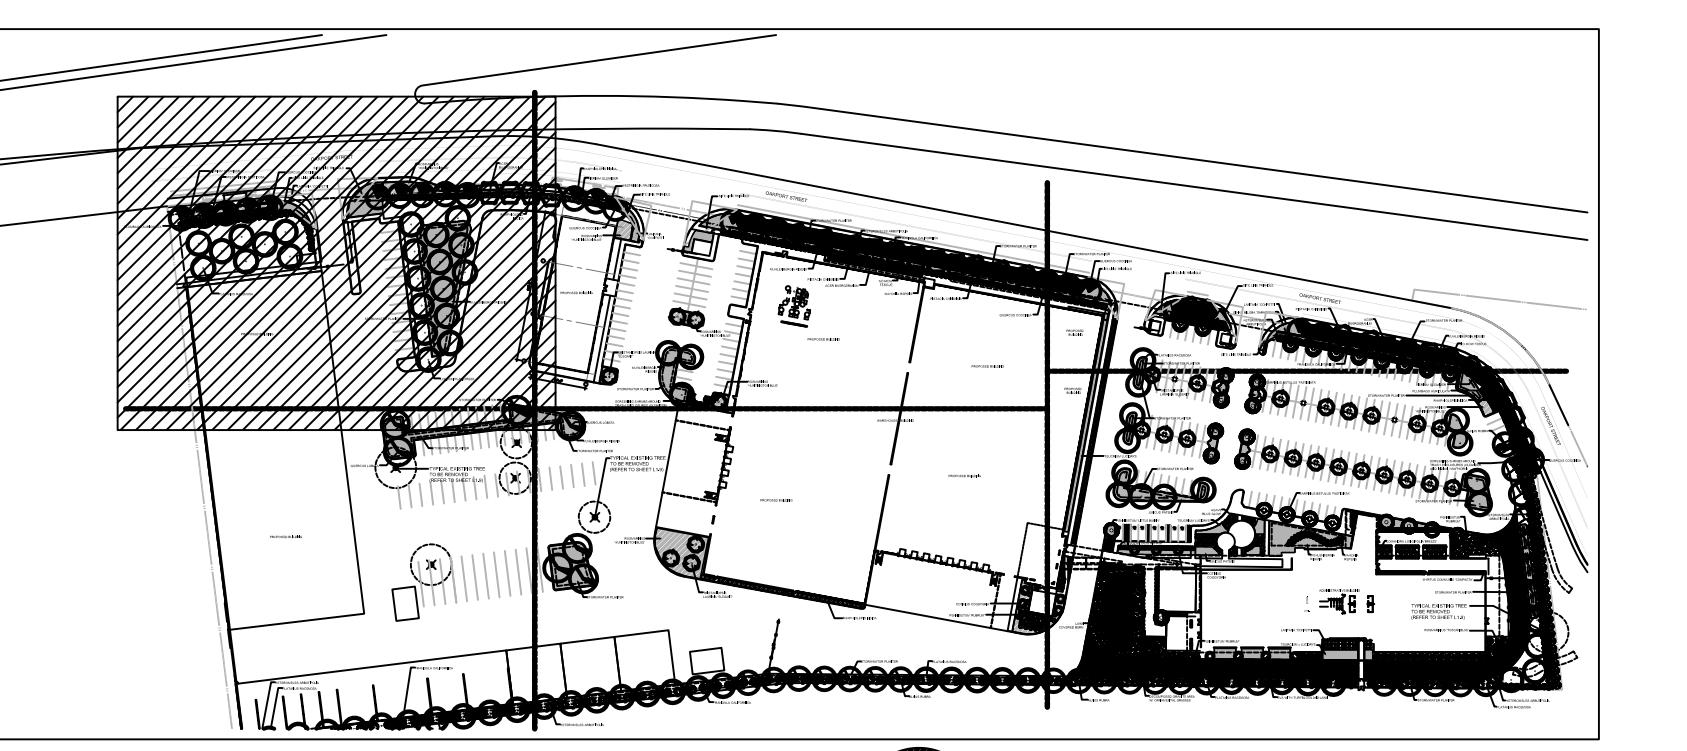
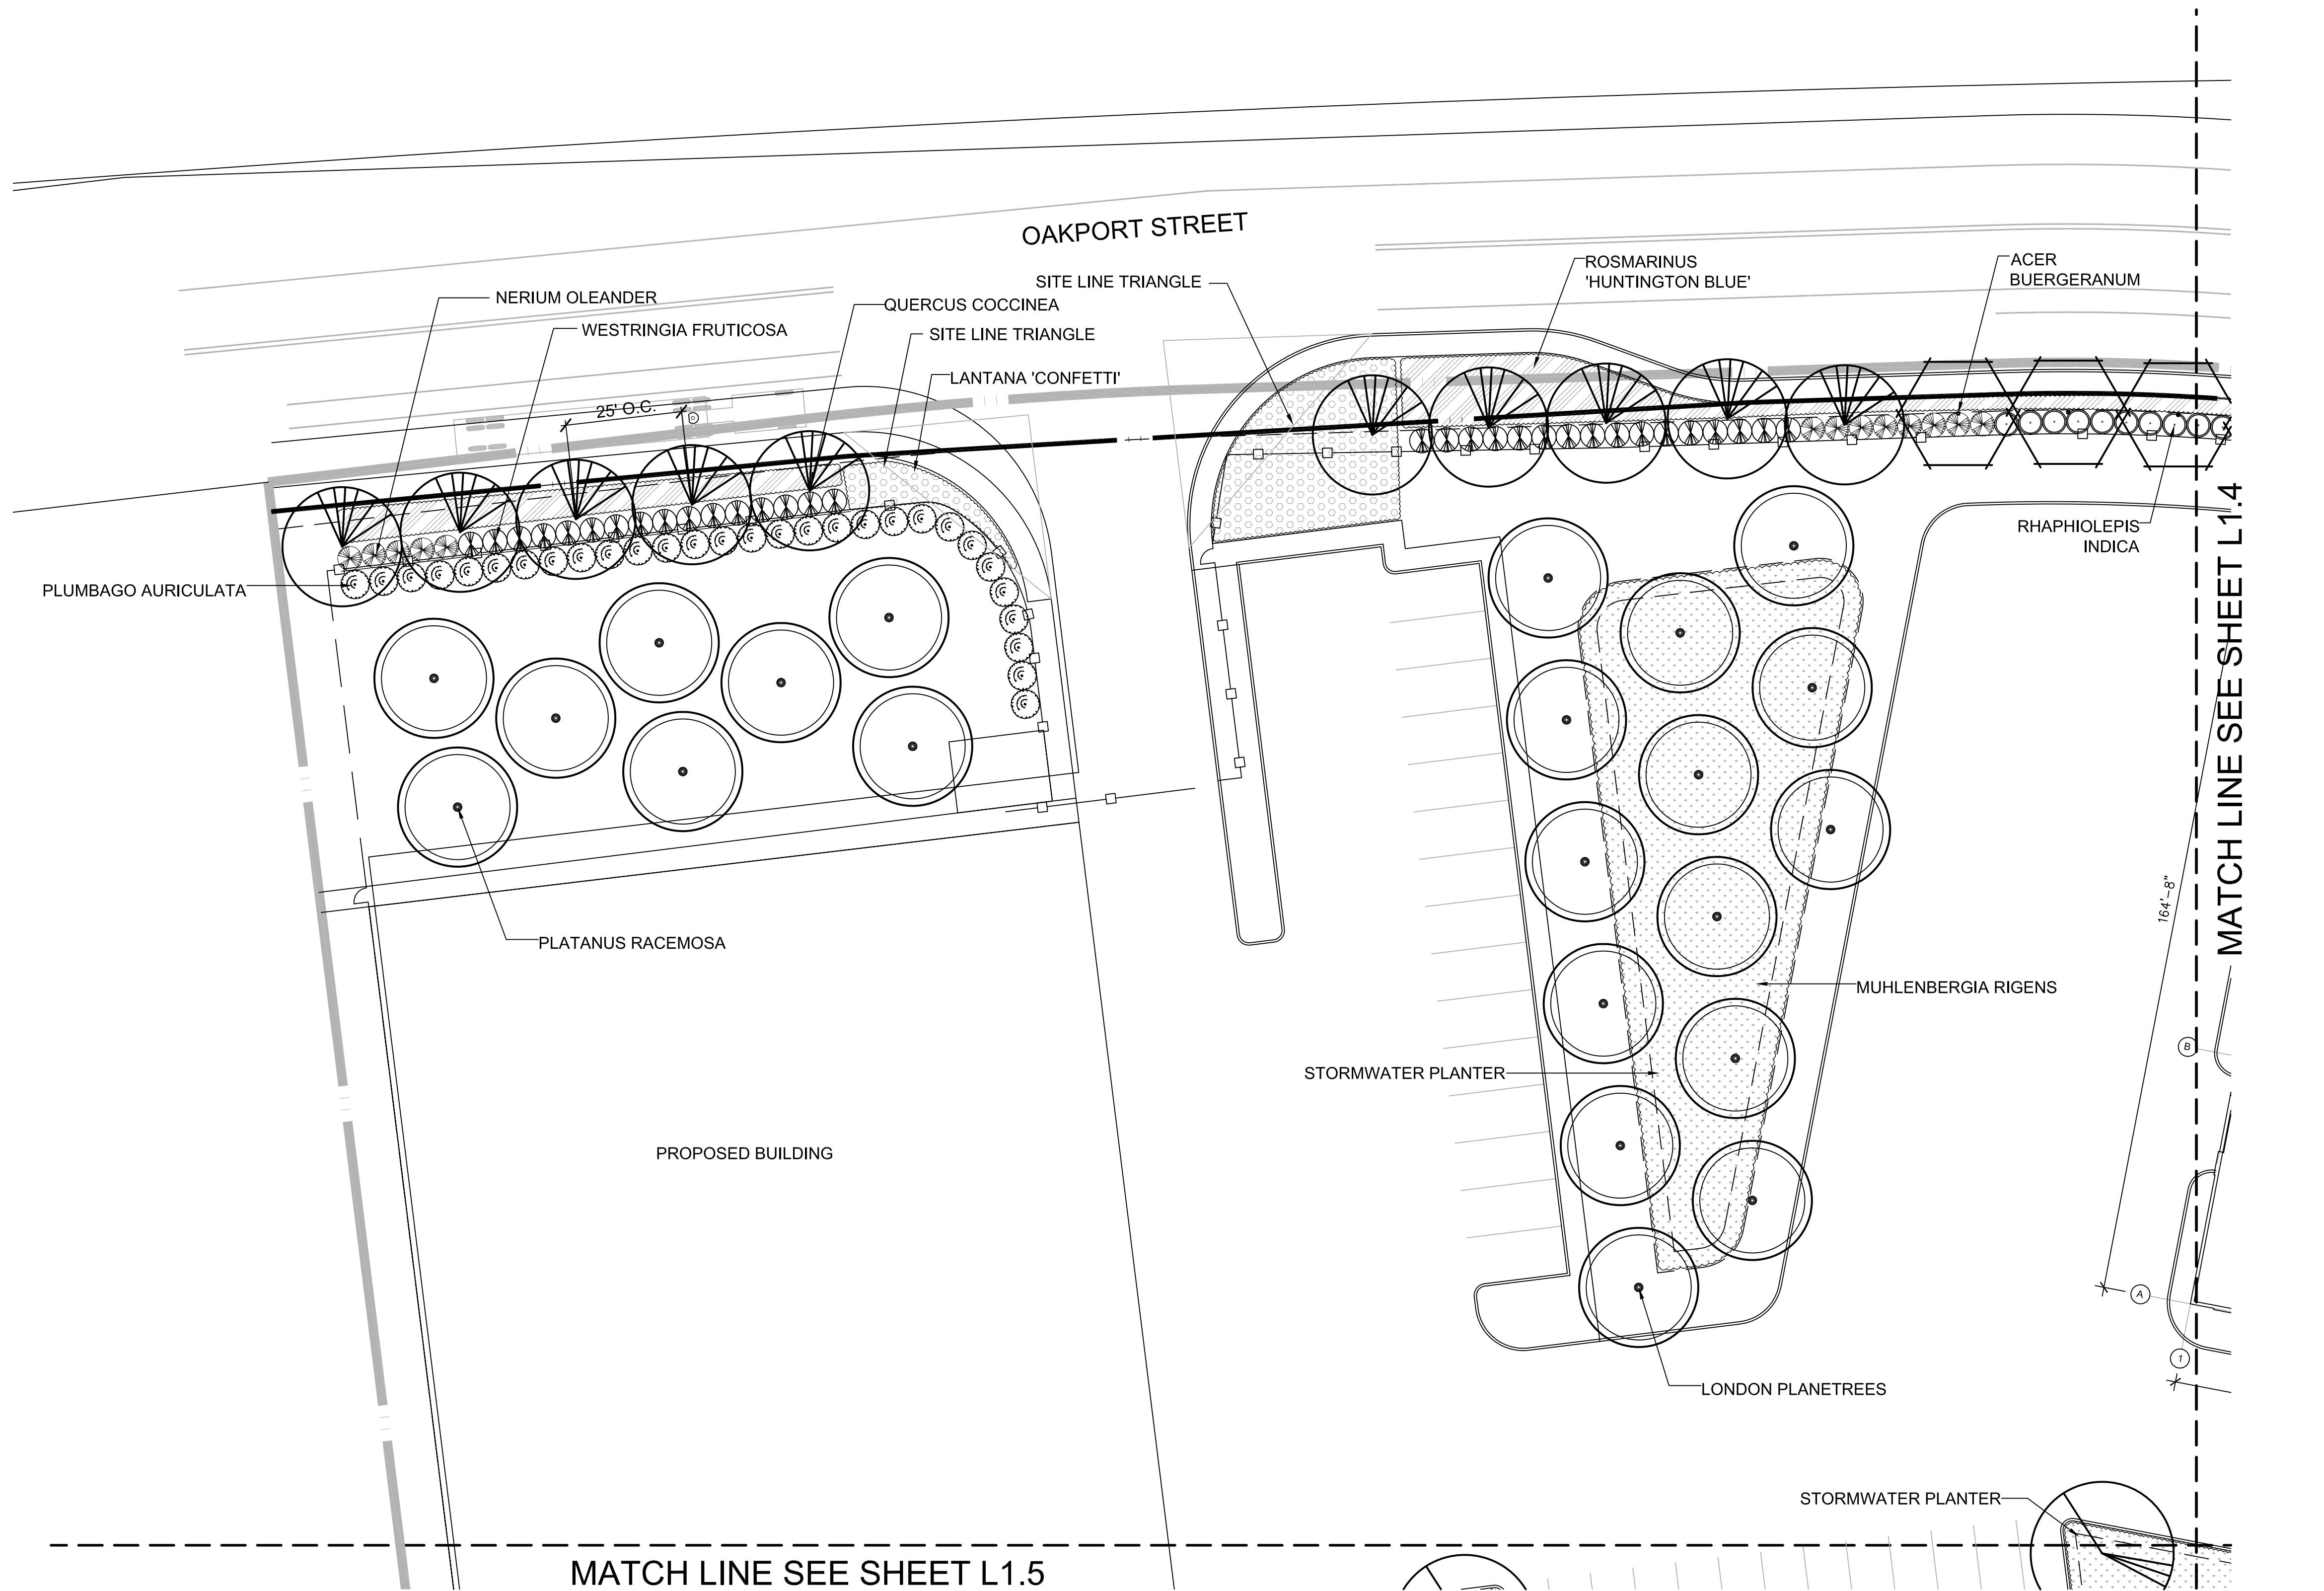
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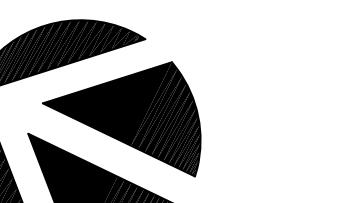
PA / PM: J. BABINE  
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SHEET

L1.5

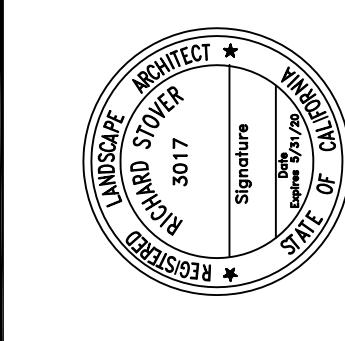


REFER TO SHEET L1.8 FOR PLANT LEGEND



GRAPHIC SCALE

20 0 10 20 40 80  
( IN FEET )  
1 inch = 20 ft.

**PRELIMINARY PLAN**

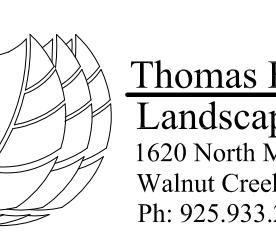

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DATE	REMARKS
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04-03-19	


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JOB NO.: SNR17-0069-00

SHEET

**L1.6**

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OAKLAND, CALIFORNIA


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04-03-19	

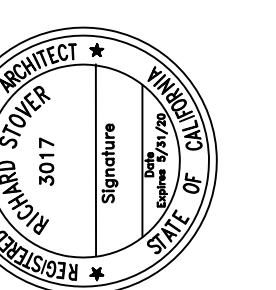PA / PM: J. BABINE  
DRAWN BY:  
JOB NO.: SNR17-0069-00


SHEET

L1.7


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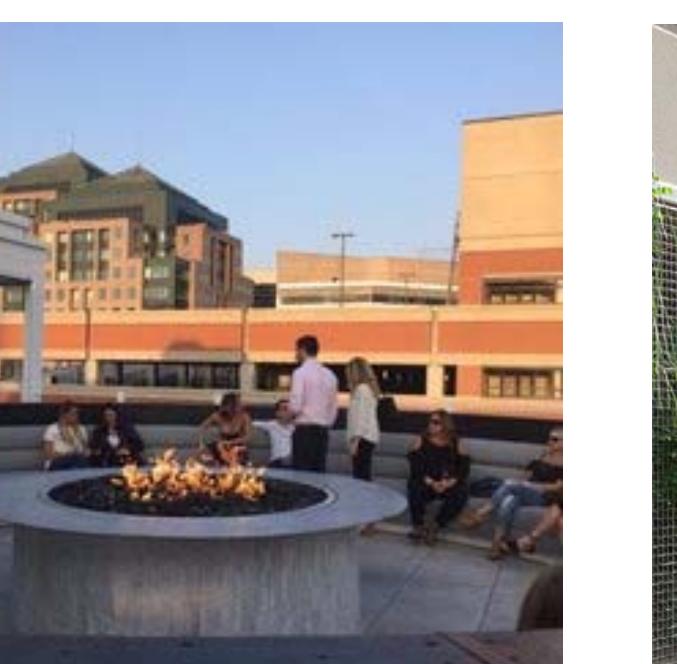
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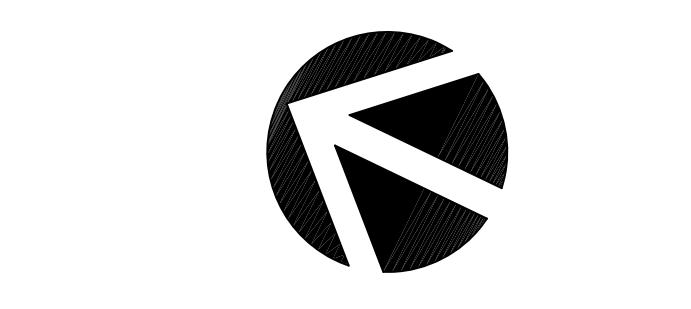
DECORATIVE PRECAST PAVERS

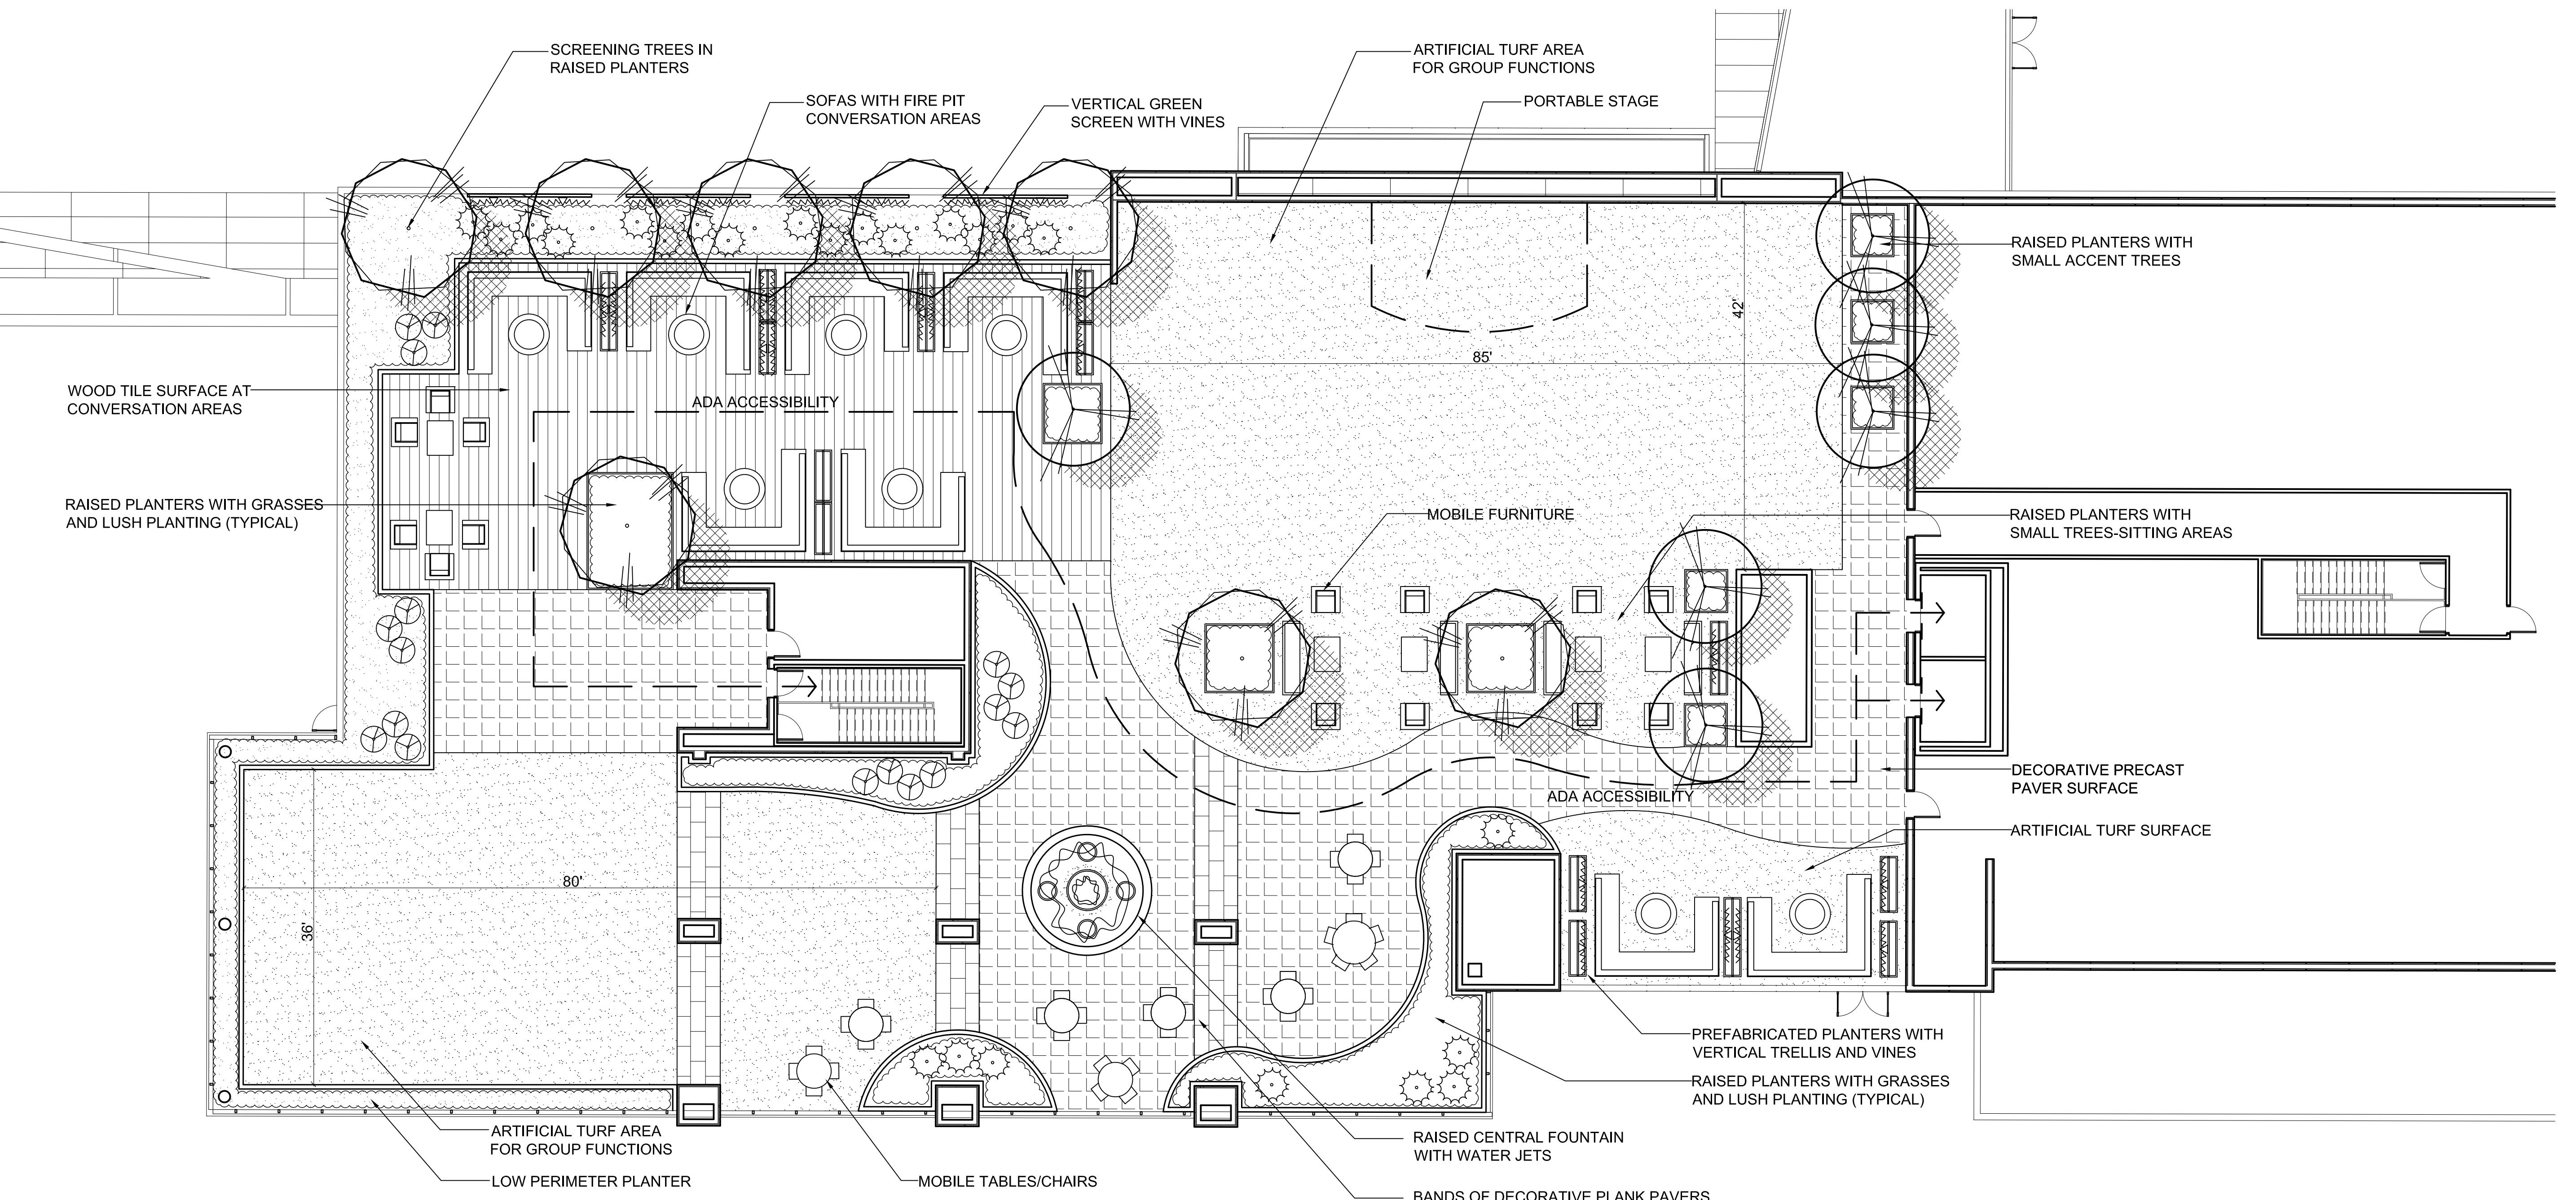

PREFABRICATED PLANTERS WITH VERTICAL TRELLISES

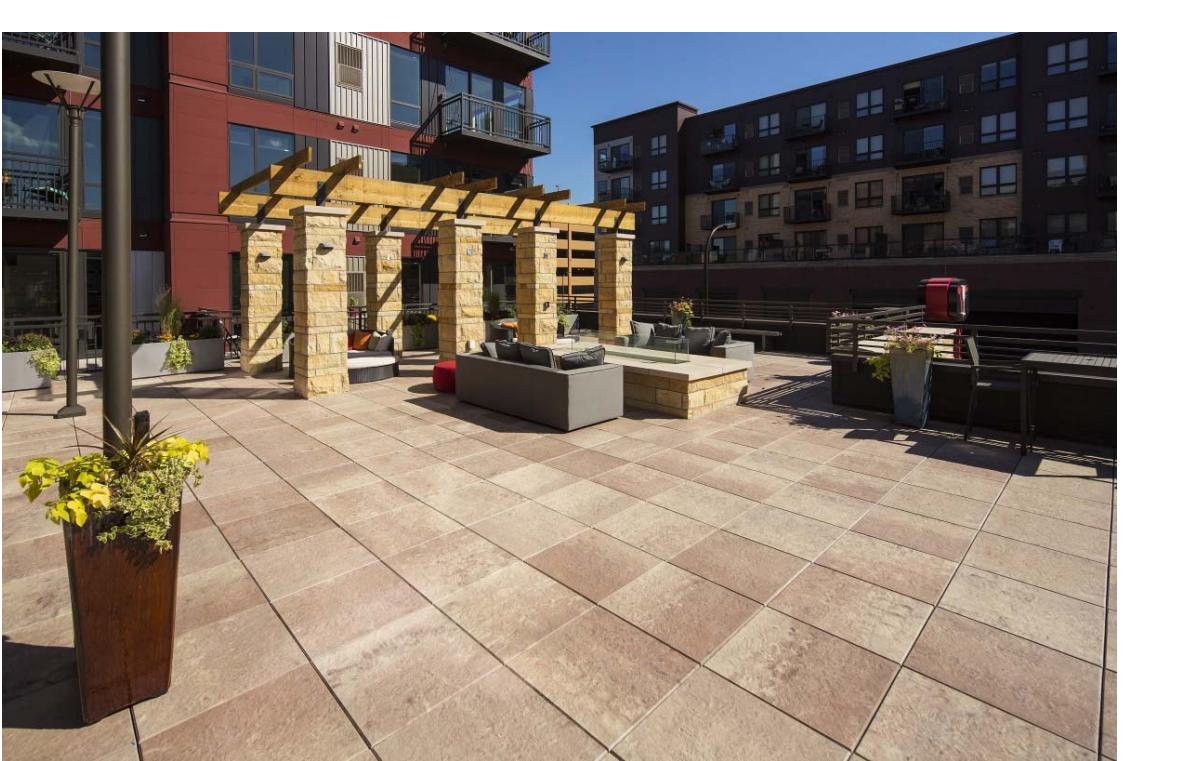

FIRE PITS

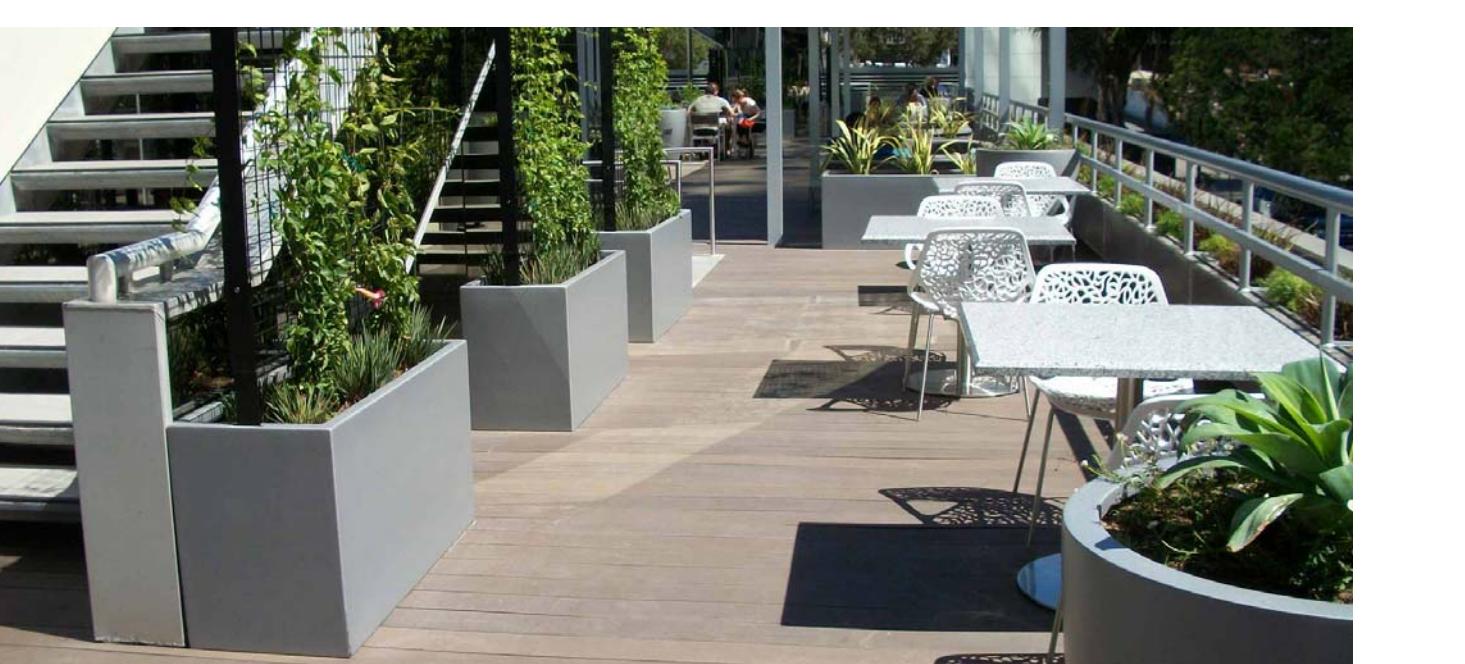
GREEN SCREENS  
VERTICAL TRELLISES

GRAPHIC SCALE  
( IN FEET )  
1 inch = 10 ft.


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Landscape Architects  
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Walnut Creek, CA 94596  
Ph: 925.933.2583

REFER TO SHEET L1.8 FOR PLANT LEGEND

PLANT LEGEND: SYMBOL / BOTANICAL NAME		COMMON NAME
<b>TREES:</b>		
	ACER BUERGERANUM	TRIDENT MAPLE
	ALNUS RUBRA	RED ALDER
	CARPINUS BETULUS 'FASTIGIATA'	EUROPEAN HORNBEAM
	GINKGO BILOBA 'SARATOGA'	MAIDENHAIR TREE
	PISTACIA CHINENSIS 'KEITH DAVEY'	CHINESE PISTACHE
	PLATANUS RACEMOSA	CALIFORNIA SYCAMORE
	QUERCUS COCCINEA	SCARLET OAK
	QUERCUS LOBATA	VALLEY OAK
	TRISTANIA LAURINA 'ELEGANT'	WATER GUM
<b>SHRUBS:</b>		
	COTINUS COGGYGRIA	SMOKE TREE
	FRANGULA CALIFORNICA	COFFEEBERRY
	HETEROMELES ARBUTIFOLIA	TOYON
	LANTANA 'CONFETTI'	LANTANA
	MAHONIA REPENS	CREEPING MAHONIA
	MYRICA CALIFORNICA	PACIFIC WAX MYRTLE
	MYRTUS COMMUNIS 'COMPACTA'	COMMON MYRTLE
	NERIUM OLEANDER 'PETITE PINK'	OLEANDER
	PLUMBAGO AURICULATA	CAPE PLUMBAGO
	RHAPHIOLEPIS INDICA 'SPRINGTIME'	INDIAN HAWTHORN
	ROSMARINUS 'TUSCAN BLUE'	TUSCAN BLUE ROSEMARY
	WESTRINGIA FRUTICOSA 'WYNYABBIE'	COAST ROSEMARY
<b>PERENNIALS:</b>		
	AGAVE 'BLUE GLOW'	
	ANIGOZANTHOS FLAVIDUS 'BIG RED'	
	LOMANDRA LONGIFOLIA 'SEA BREEZE'	
	PENNSETUM 'RUBRUM'	
	PHORMIUM 'MAORI QUEEN'	
<b>GROUNDCOVERS:</b>		
	JUNCUS PATENS	CALIFORNIA GRAY RUSH
	LANTANA 'CONFETTI'	LANTANA
	LANTANA MONTEVIDENSIS (WHITE)	LANTANA
	MUHLENBERGIA RIGENS	DEERGRASS
	PENNSETUM 'LITTLE BUNNY'	DWARF FOUNTAIN GRASS
	ROSMARINUS O. 'HUNTINGTON BLUE'	ROSEMARY
	TEUCRIUM LUCIDRYS	GERMANDER

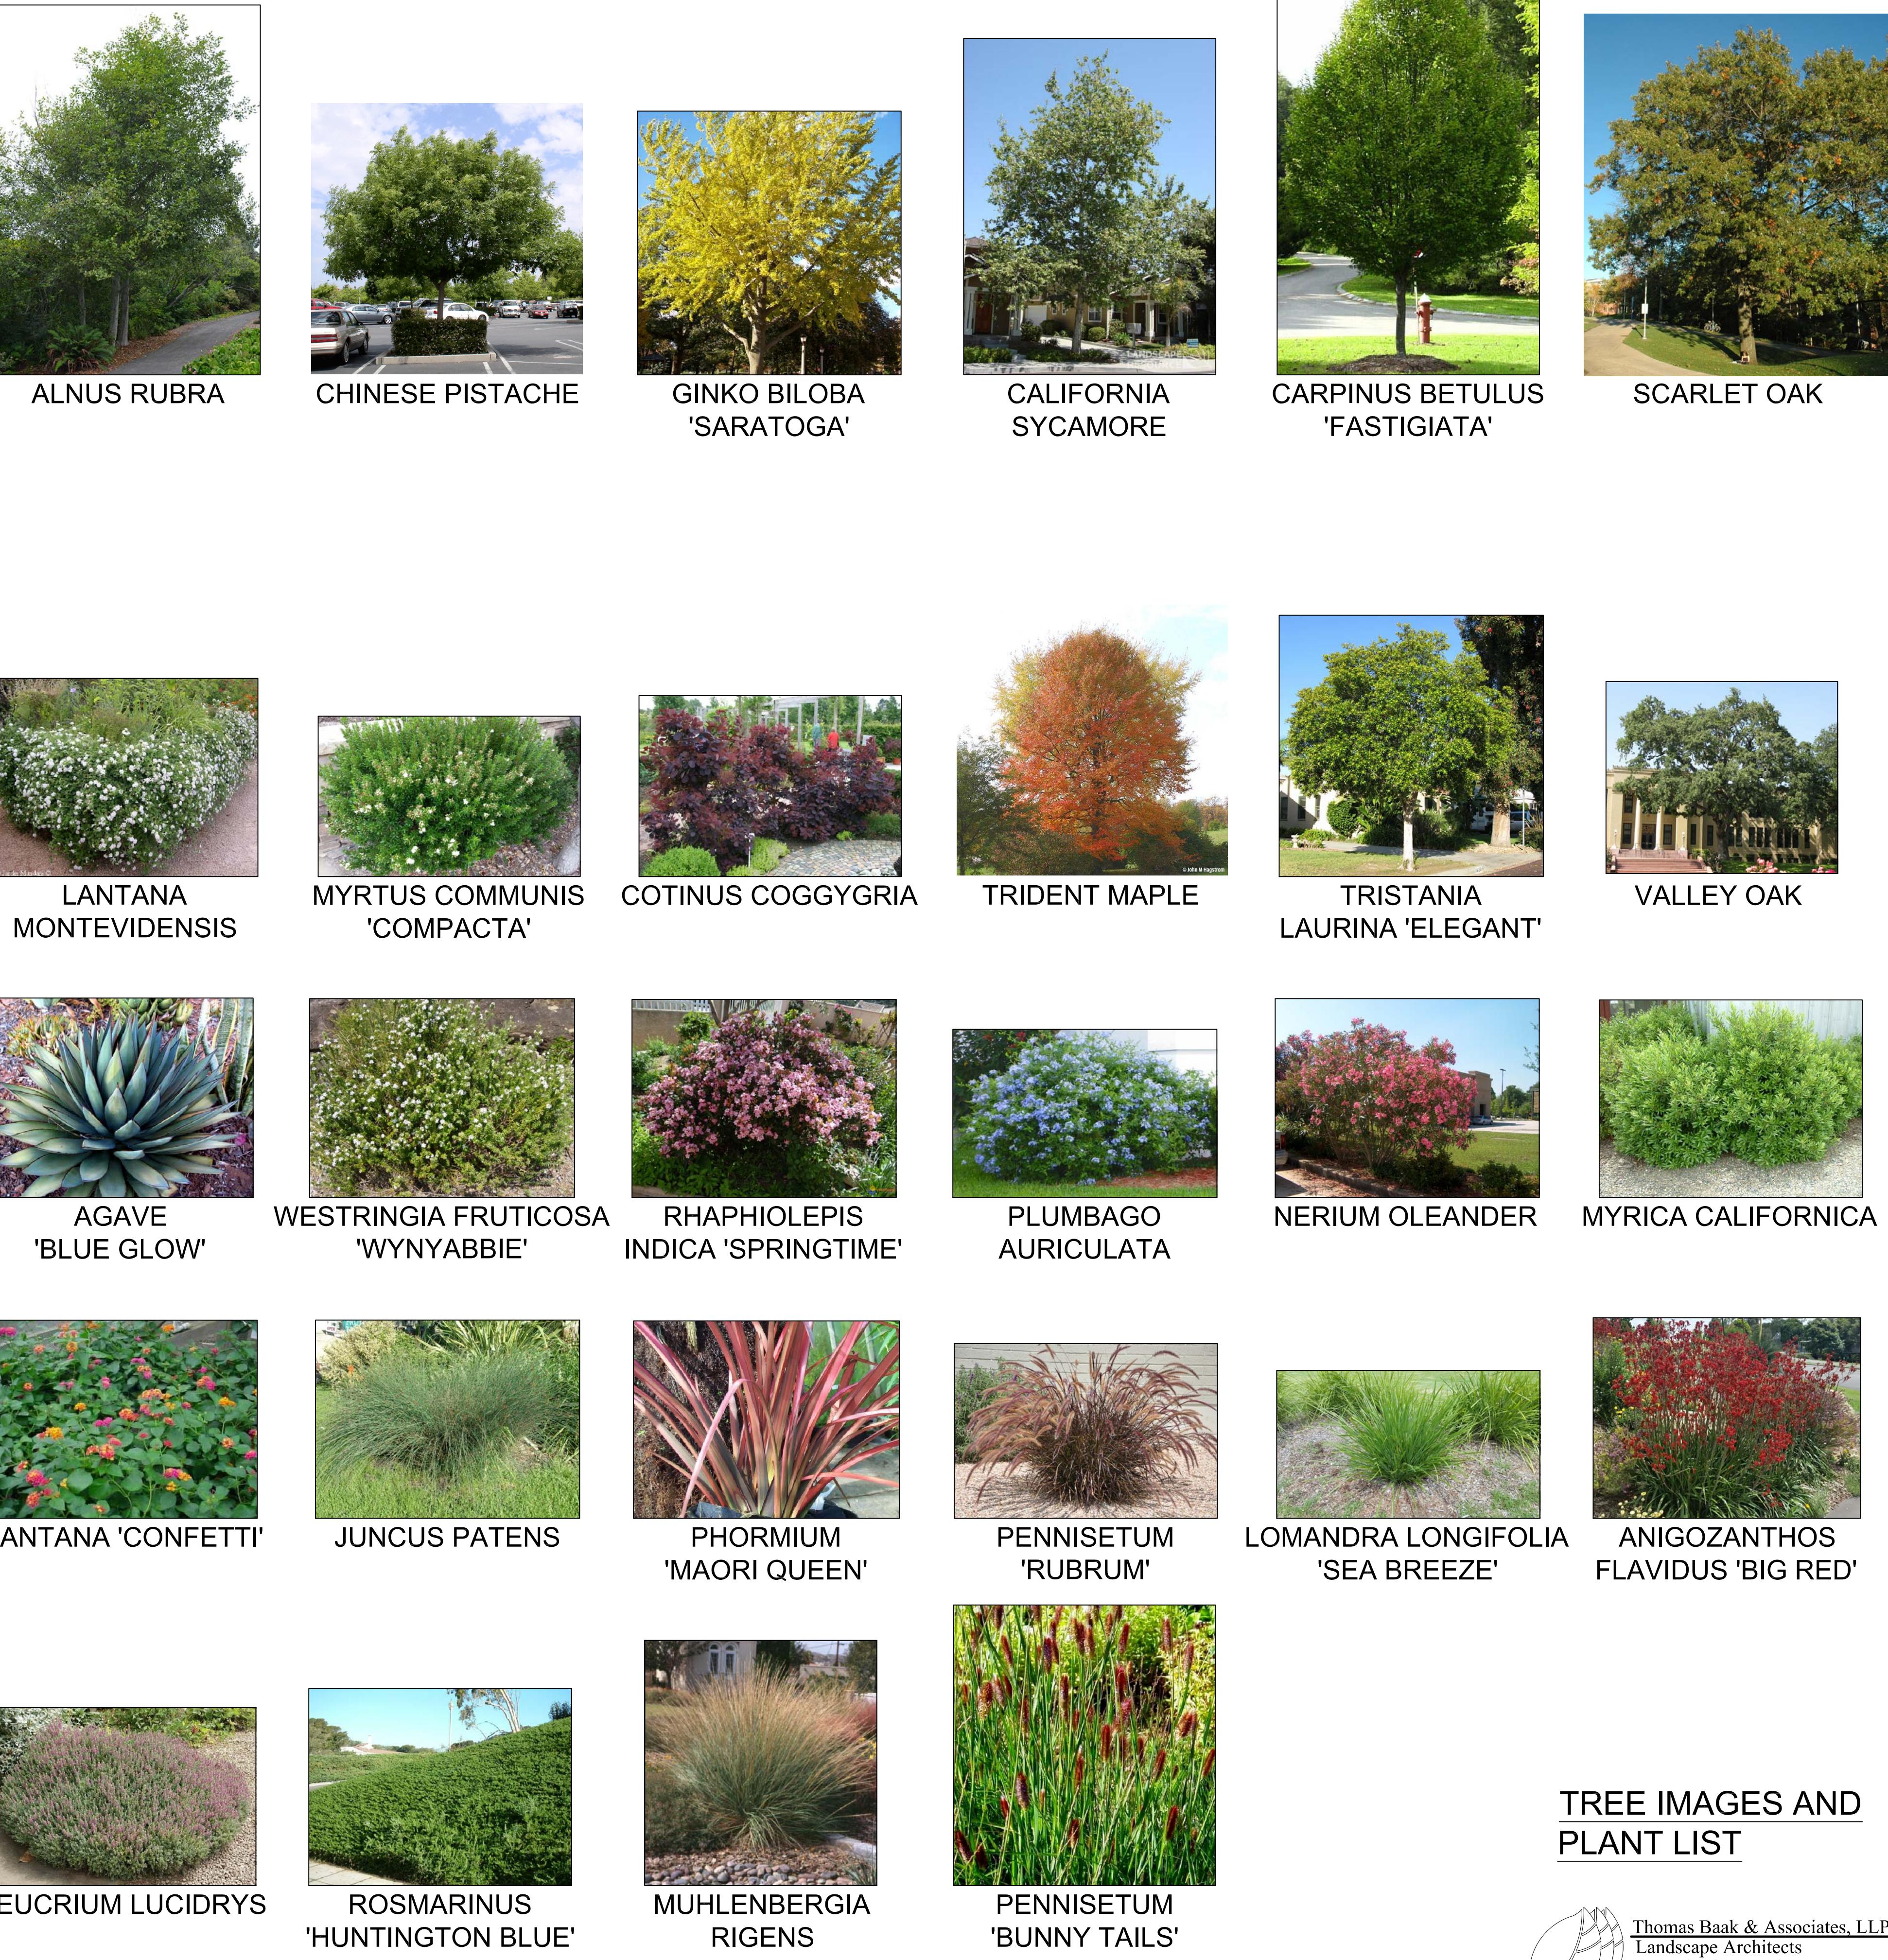

### TREE IMAGES AND PLANT LIST

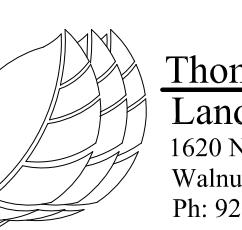


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DATE	REMARKS
01/30/2019	PLANNING SUBMITTAL
04-03-19	

PA / PM:	J. BABINE
DRAWN BY:	
JOB NO.:	SNR17-0069-00
SHEET	L1.8

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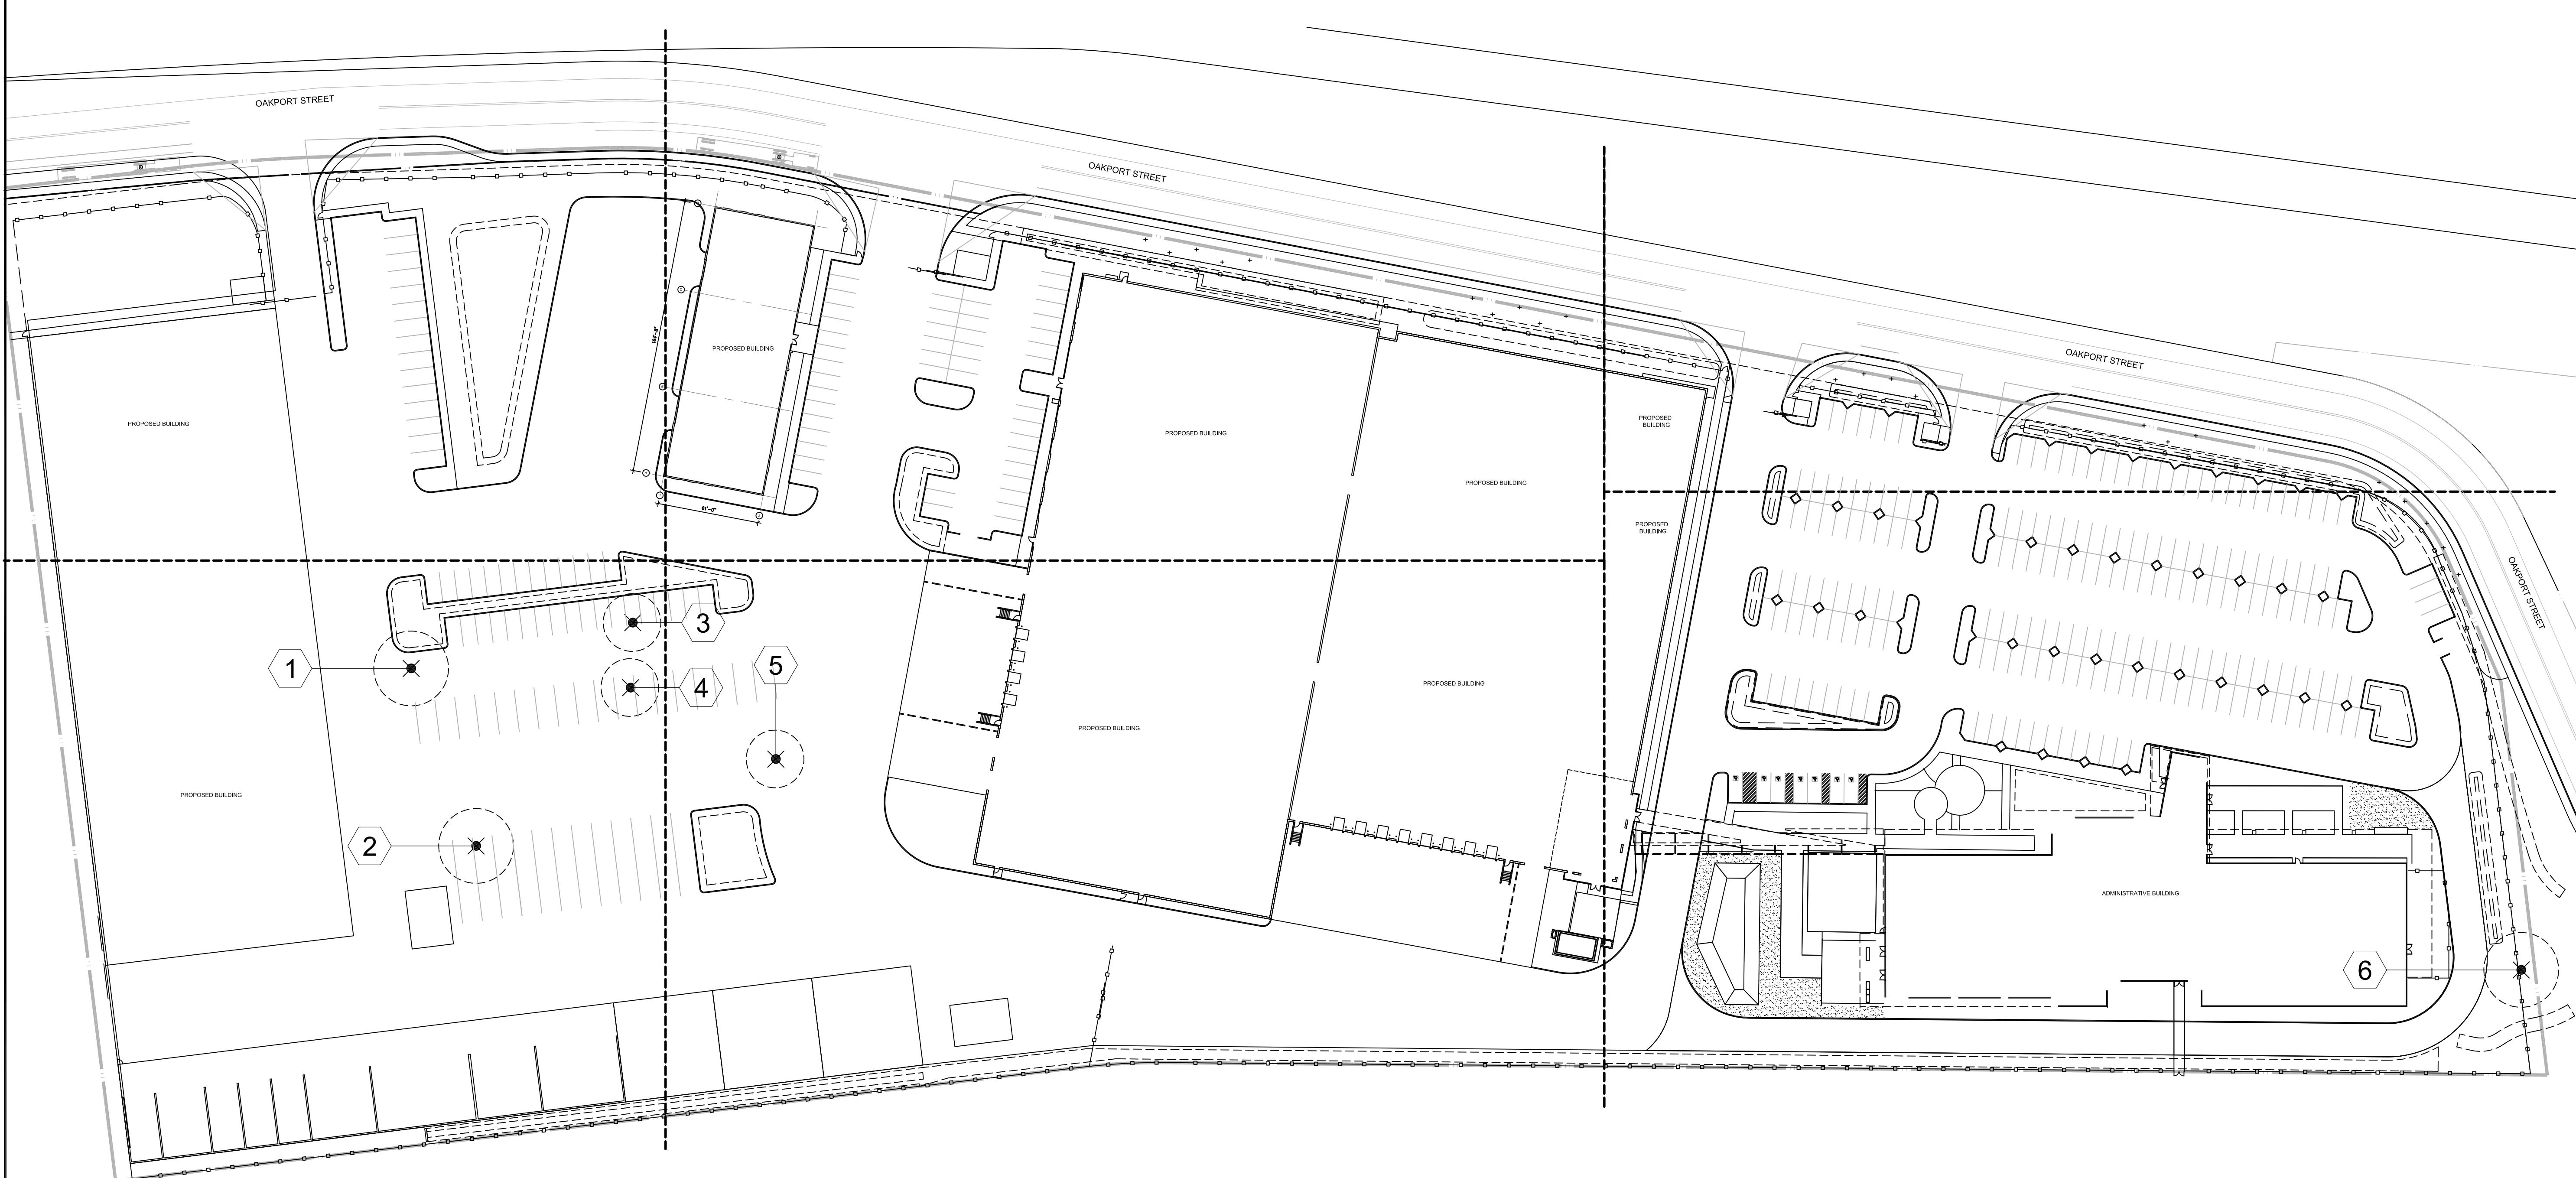
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01/30/2019	PLANNING SUBMITTAL
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**L1.9**

L1.9

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WATER EFFICIENT LANDSCAPE WORKSHEET							
REFERENCE EVAPOTRANSPIRATION (ETO): 41.8							
HYDROZONE / PLANTING DESCRIPTION	PLANT FACTOR (PF)	IRRIGATION METHOD	IRRIGATION EFFICIENCY (IE)	ETAF (PF / IE)	LANDSCAPE AREA (sq. ft.)	ETAF x AREA	ESTIMATED TOTAL WATER USE (ETWU)
<b>REGULAR LANDSCAPE AREAS:</b>							
LOW WATER USE	0.2	Drip	0.81	0.2469135	72444	17887.40159	463569.9
MEDIUM WATER USE	0.5	BUBBLER	0.81	0.61728395	2007	1238.888888	32107.0
HIGH WATER USE	0.7	Drip	0.81	0.86419753	10491	9066.296287	234962.1
HIGH WATER USE	0.7	SPRAY	0.75	0.9333333	15782	14729.86614	381739.2
<b>TOTALS:</b>				100724	42922		
<b>SPECIAL LANDSCAPE AREAS:</b>							
REC. AREA				1	0	0	0
WATER FEATURE 1				1	0	0	0
WATER FEATURE 2				1	0	0	0
<b>TOTALS:</b>				0	0	0	
<b>ETWU TOTAL:</b> 1,112,378							
<b>MAXIMUM ALLOWED WATER ALLOWANCE (MAWA):</b> 1,174,663							
<b>ETAF CALCULATIONS:</b>							
<b>REGULAR LANDSCAPE AREAS:</b>							
TOTAL ETAF x AREA	42,922	NOTE: AVERAGE ETAF FOR REGULAR LANDSCAPE AREAS MUST BE 0.55 OR BELOW FOR RESIDENTIAL AREAS, AND 0.45 OR BELOW FOR NON-RESIDENTIAL AREAS.					
TOTAL LANDSCAPE AREA	100,724						
AVERAGE ETAF	0.43						
<b>ALL LANDSCAPE AREAS:</b>							
TOTAL ETAF x AREA	42,922						
TOTAL LANDSCAPE AREA	100,724						
SITEWIDE ETAF	0.43						

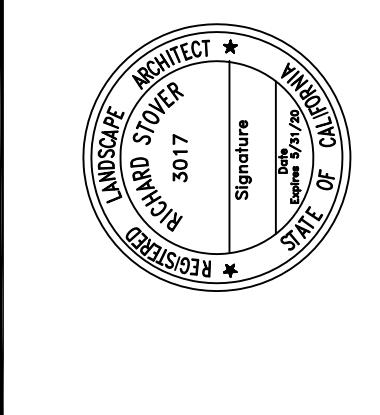NOTES:



1. ALL PLANTING SHALL BE WATERED BY A FULLY AUTOMATIC RECYCLED WATER IRRIGATION SYSTEM WITH WEATHER-BASED CONTROLLER OPERATION.
2. ALL PLANTING (EXCEPT LAWNS) SHALL RECEIVE A 3" DEEP LAYER OF FIR BARK MULCH DRESSING.

EXISTING TREE SURVEY SYMBOL	TREE COMMON NAME	CALIPER DIAMETER	STATUS
<b>TREES:</b>			
①	EUCALYPTUS	28"Ø	REMOVE
②	DATE PALM	48"Ø	REMOVE
③	OLIVE	12"Ø	REMOVE
④	OLIVE	12"Ø	REMOVE
⑤	OLIVE	10"Ø	REMOVE
⑥	DATE PALM	48"Ø	REMOVE


**STREET TREE REQUIREMENTS:**

PER CITY OF OAKLAND LANDSCAPING AND SCREENING STANDARDS, ONE STREET TREE IS REQUIRED FOR EVERY 25 FEET OF PROJECT STREET FRONTAGE (NOT NECESSARILY EVEN 25 FT. SPACING).

TOTAL PROJECT STREET FRONTAGE ALONG RIGHT OF WAY: 1,442 FT. TOTAL NUMBER OF (15 GALLON) STREET TREES REQUIRED: 58 TOTAL NUMBER OF (15 GALLON) STREET TREES PROVIDED: 58

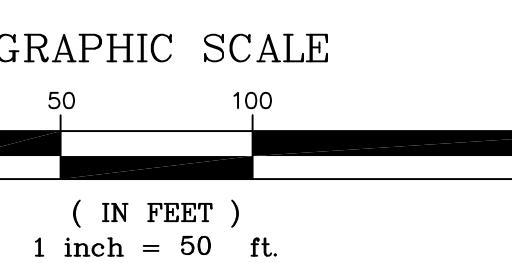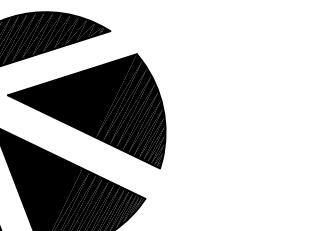

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TREE SURVEY PLAN
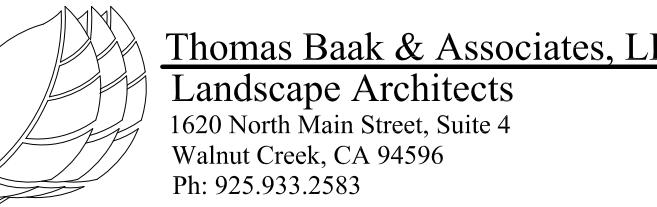
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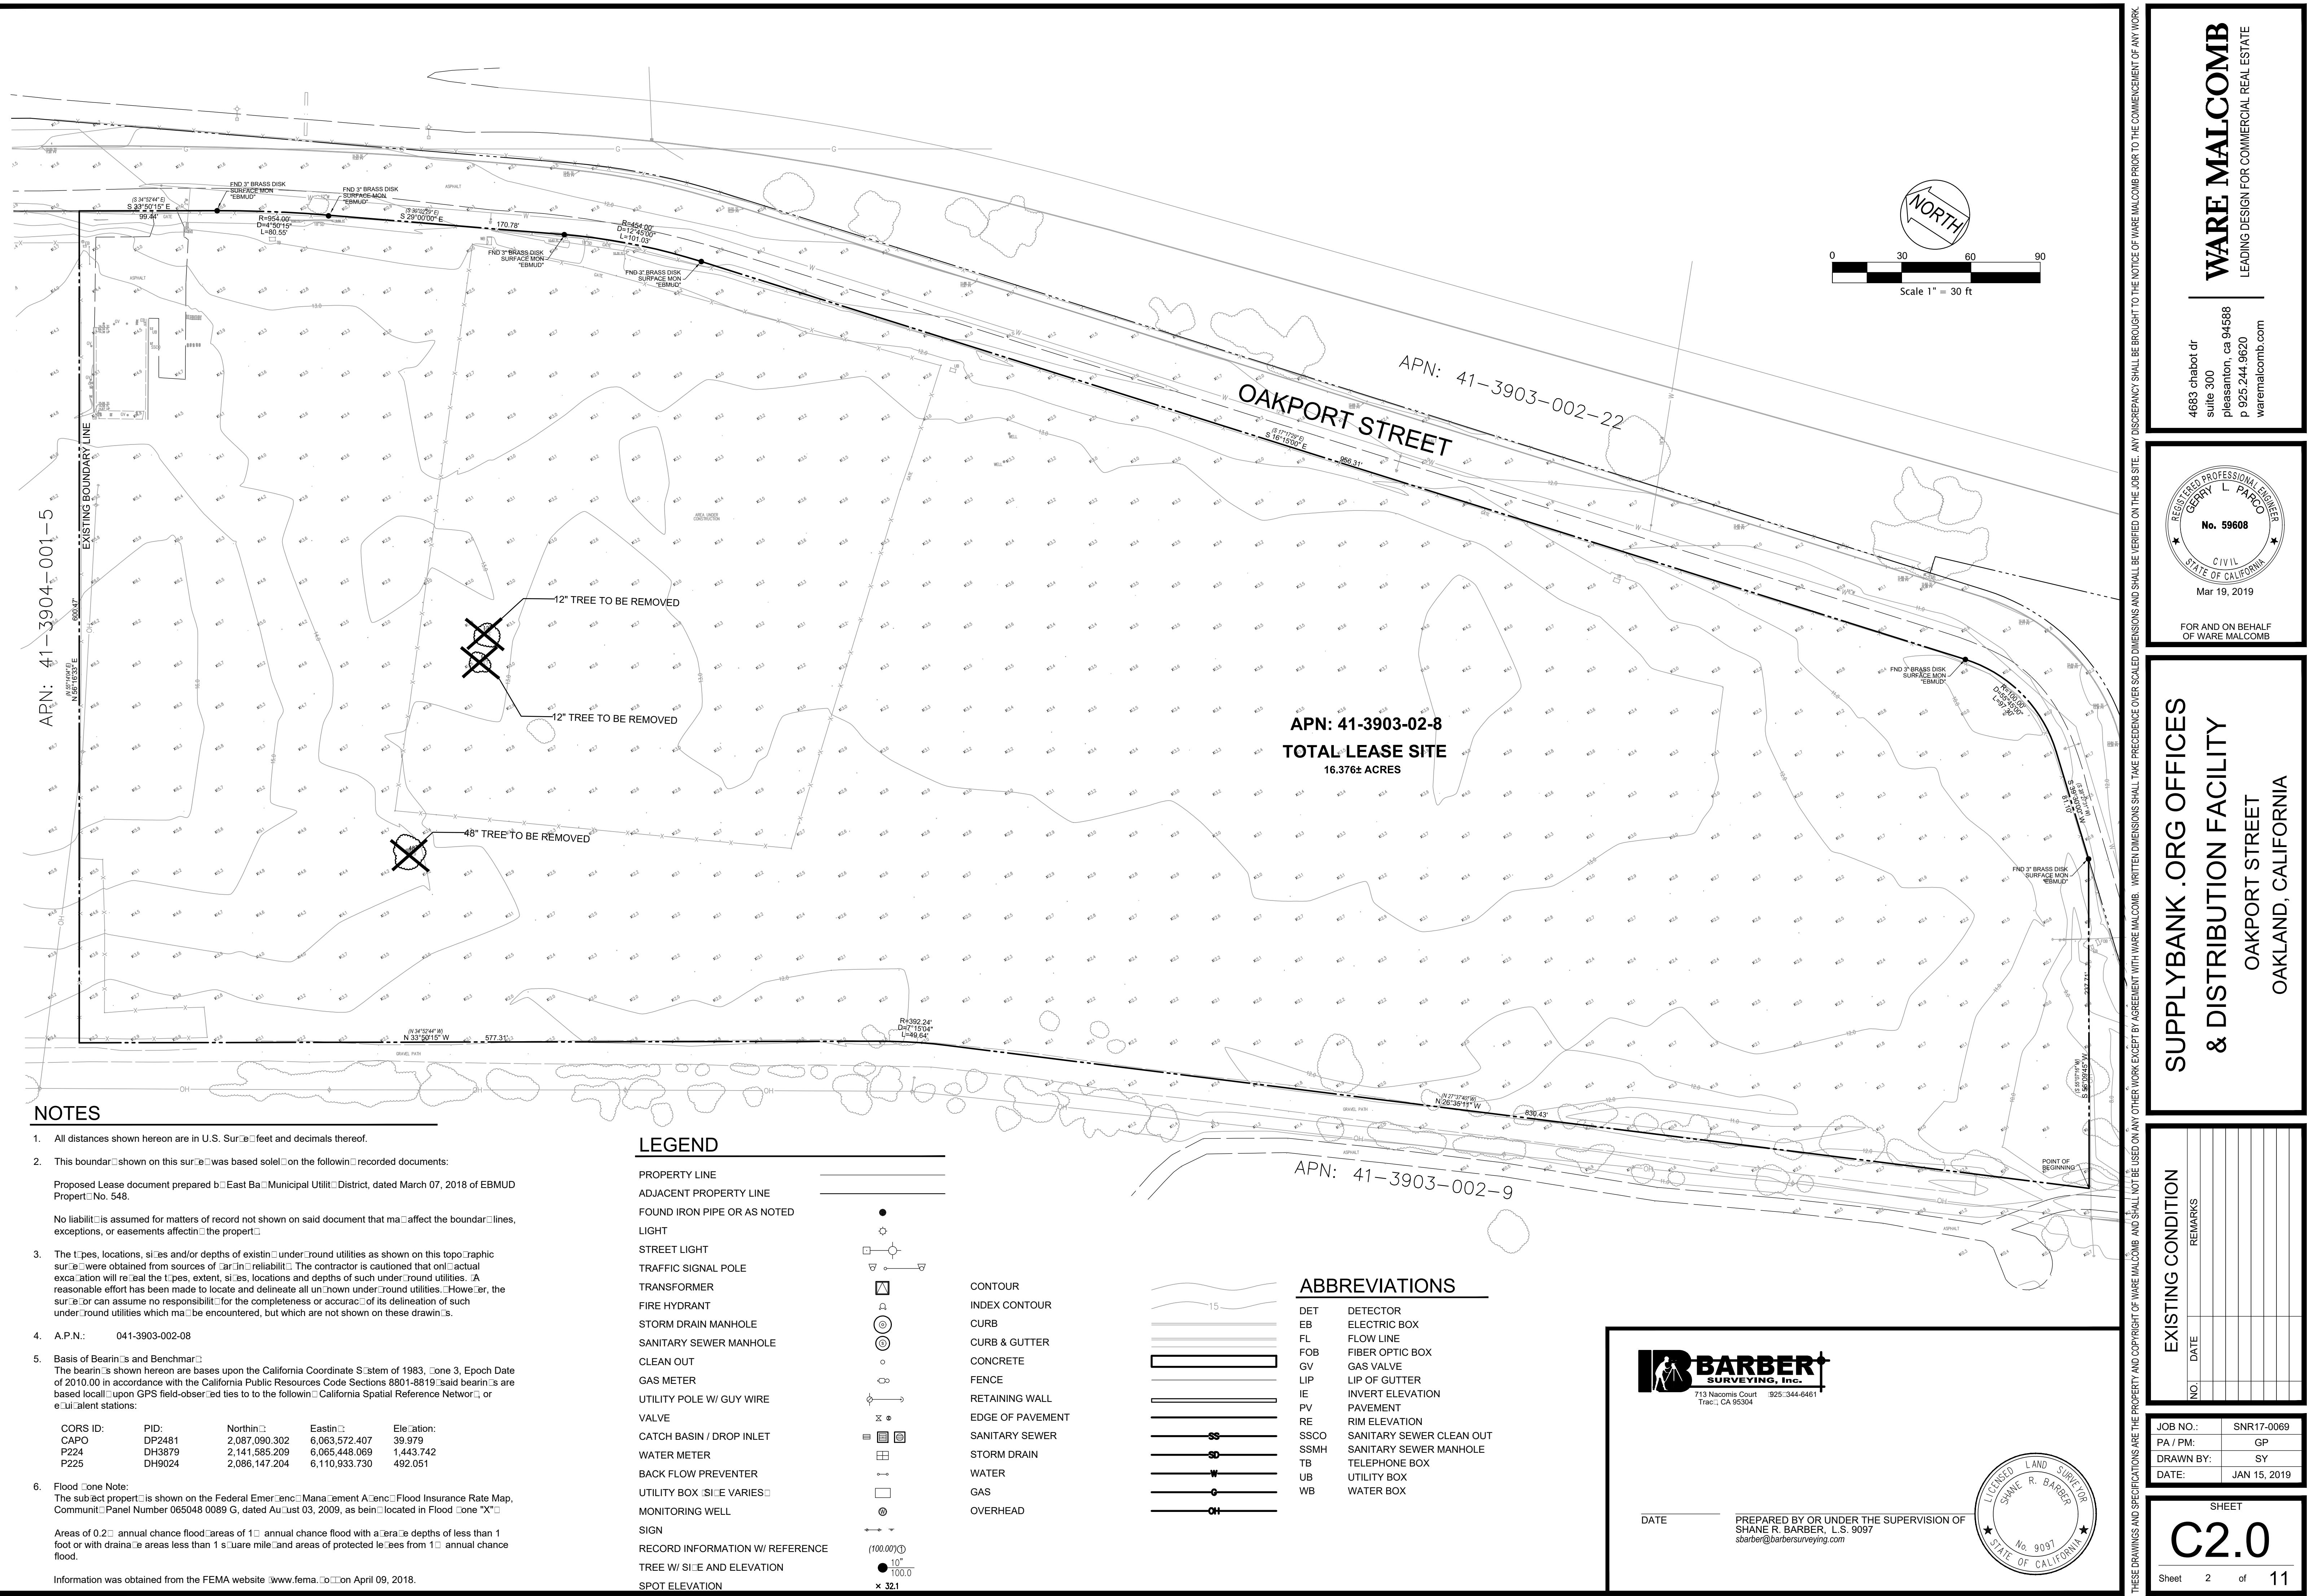


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Sheet 11 of 11



NIMITZ FREEWAY



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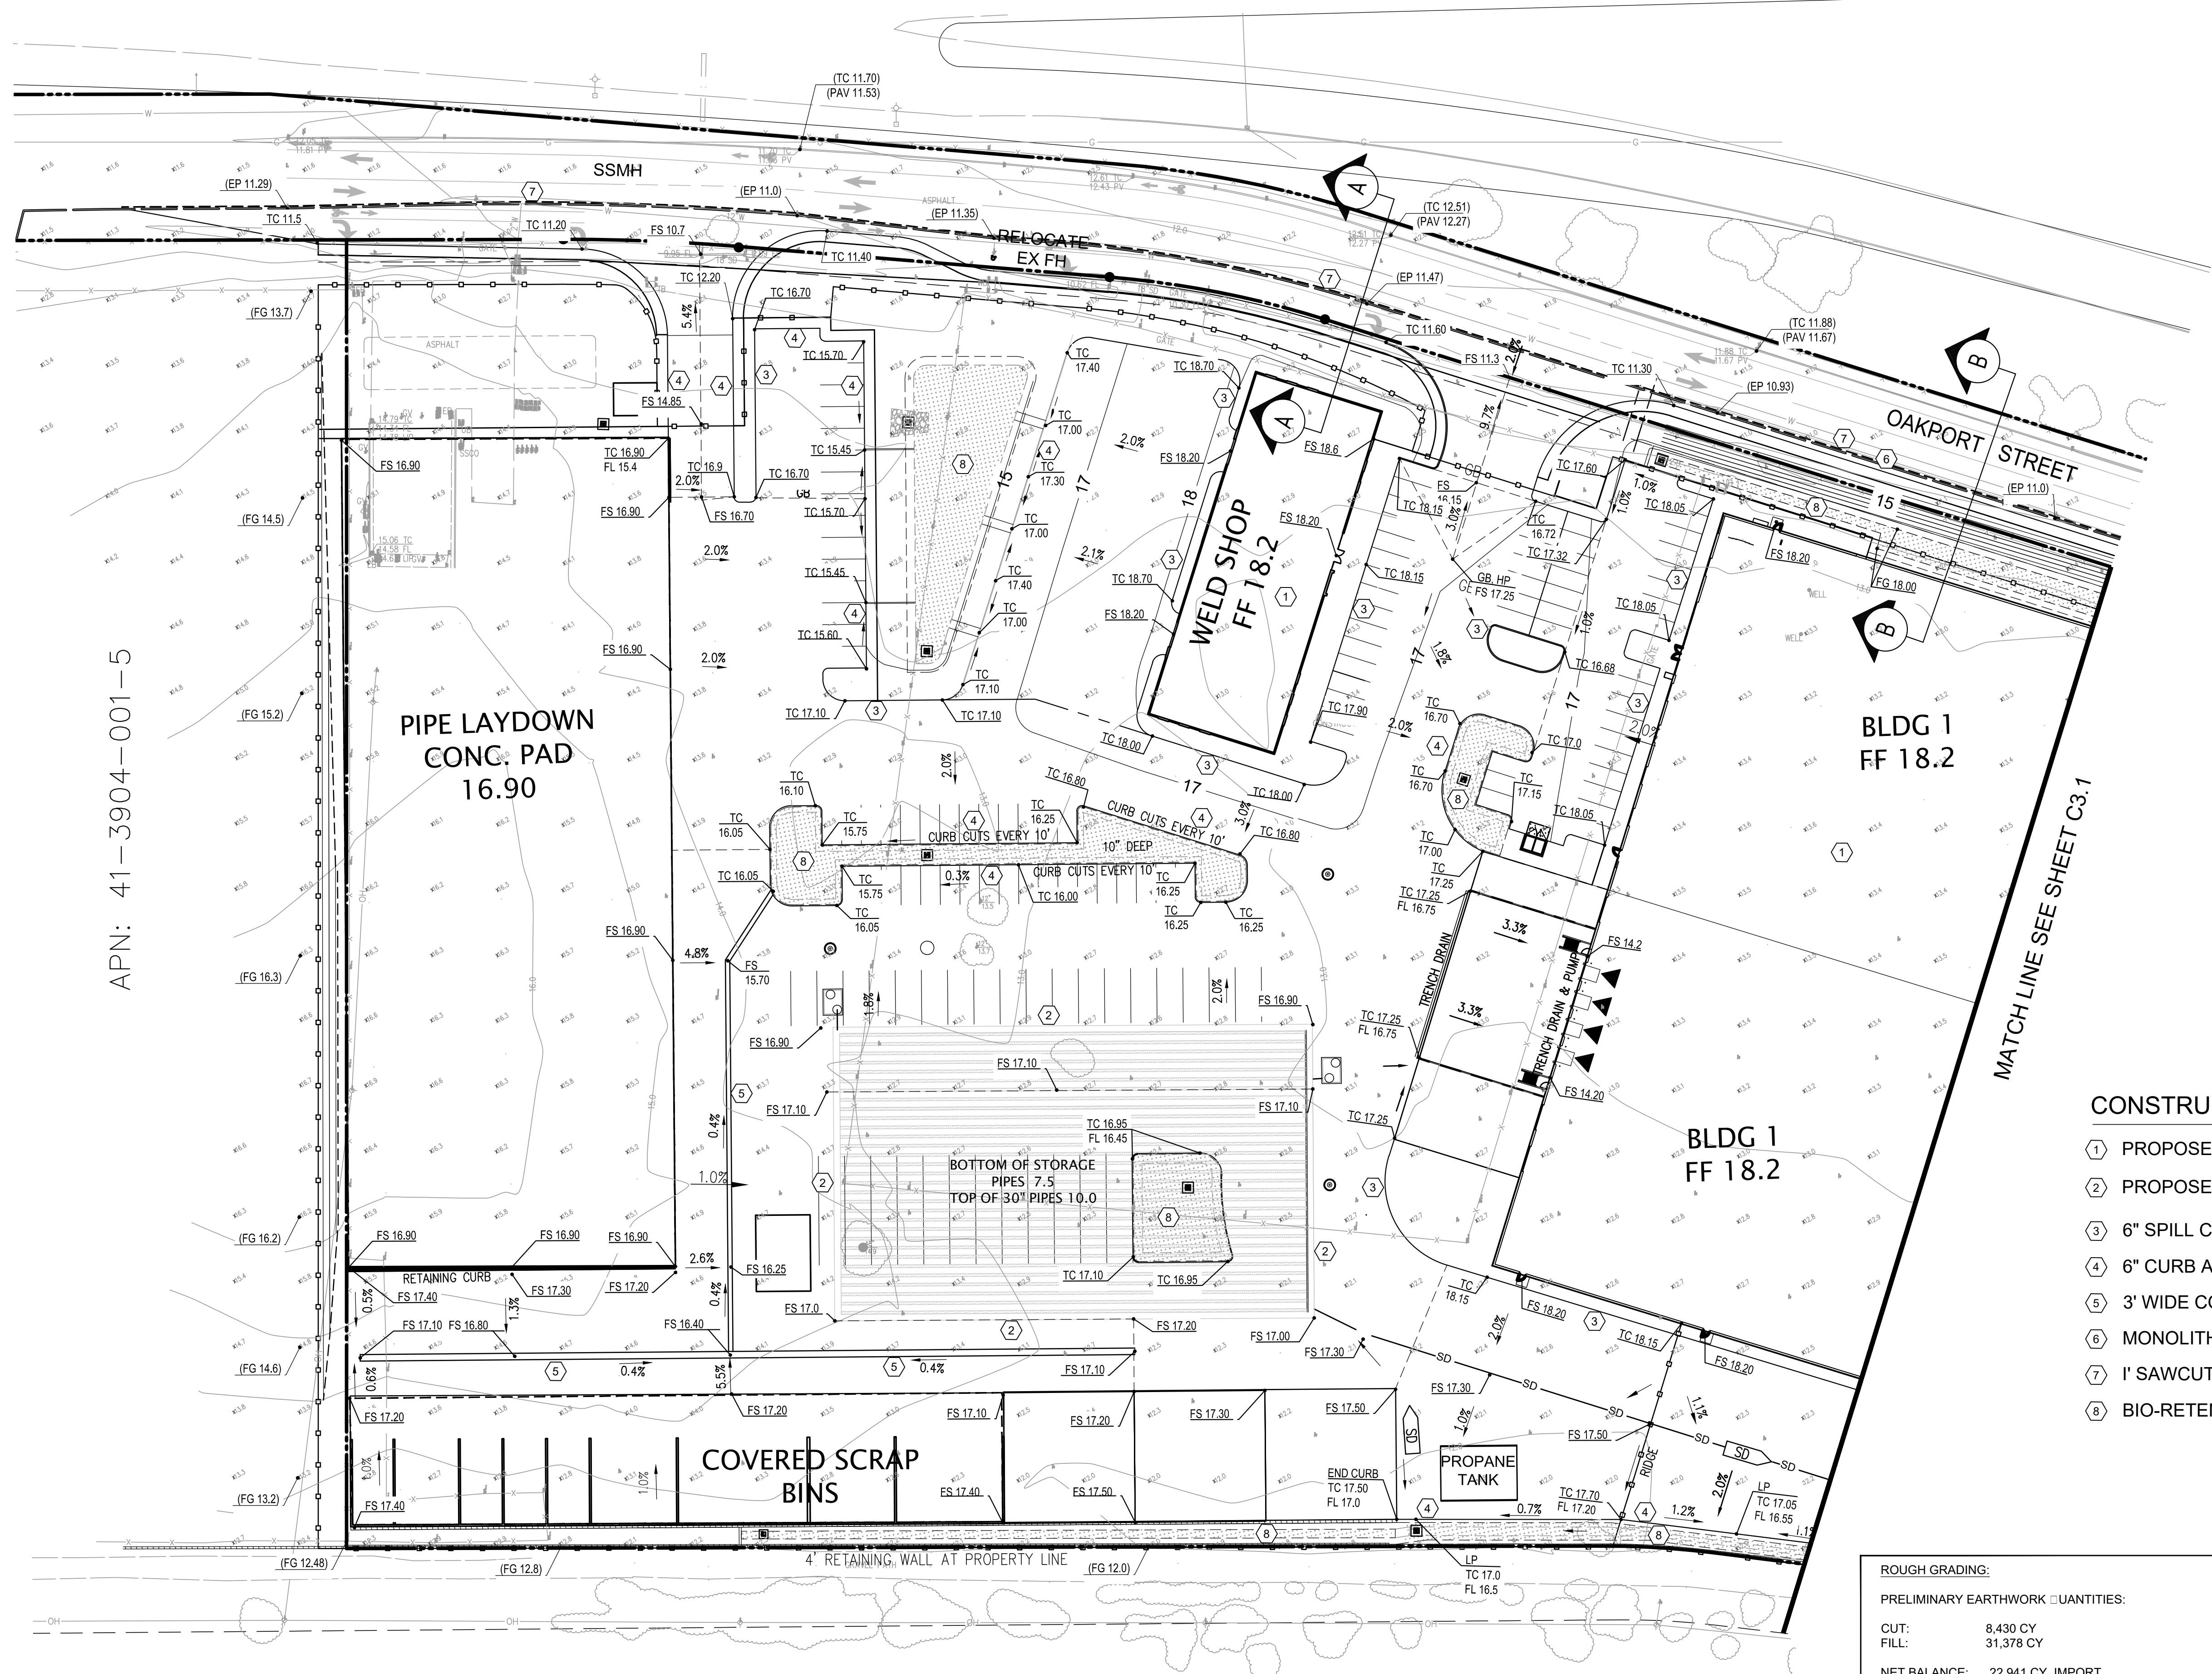
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APN: 41-3904-001-5



MATCH LINE SEE SHEET C3.1

**CONSTRUCTION NOTES:**

- ① PROPOSED BUILDING, SEE ARCHITIURAL PLANS
- ② PROPOSED UNDERGROUND SD STORAGE PIPE SYSTEM
- ③ 6" SPILL CURB SEE DETAIL SHEET
- ④ 6" CURB AND GUTTER PER CITY STANDARDS
- ⑤ 3' WIDE CONCRETE VALLEY GUTTER
- ⑥ MONOLITHIC CURB & GUTTER AND SIDEWALK
- ⑦ I' SAWCUT LINE
- ⑧ BIO-RETENTION AREA

**ROUGH GRADING:**

## PRELIMINARY EARTHWORK QUANTITIES:

CUT: 8,430 CY  
FILL: 31,378 CY

NET BALANCE: 22,941 CY IMPORT

QUANTITIES SHOWN ARE "FINISHED GRADE" CALCULATIONS. NO SHRINK, SWELL, OR COMPACTION FACTORS HAVE BEEN USED. PAVEMENT AND BUILDING SLAB DEPTH HAVE NOT BEEN REMOVED FROM QUANTITIES LISTED.  
QUANTITIES ARE SHOWN FOR INFORMATION ONLY AND SHALL BE CONFORMED BY CONTRACTOR PRIOR TO START OF CONSTRUCTION. ALL EARTHWORK OPERATIONS SHALL BE PREPARED PER GEOTECHNICAL REPORT BY RANEY GEOTECHNICAL INC. DATED MAY 24, 2018 INCLUDING SUBGRADE PERPETRATION AND DEPTHS.

PRELIMINARY GRADING AND DRAINAGE PLAN	REMARKS
NO.	DATE

JOB NO.:	SNR17-0069
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DRAWN BY:	SY
DATE:	JAN 15, 2019

SHEET	C3.0
Sheet	3 of 11



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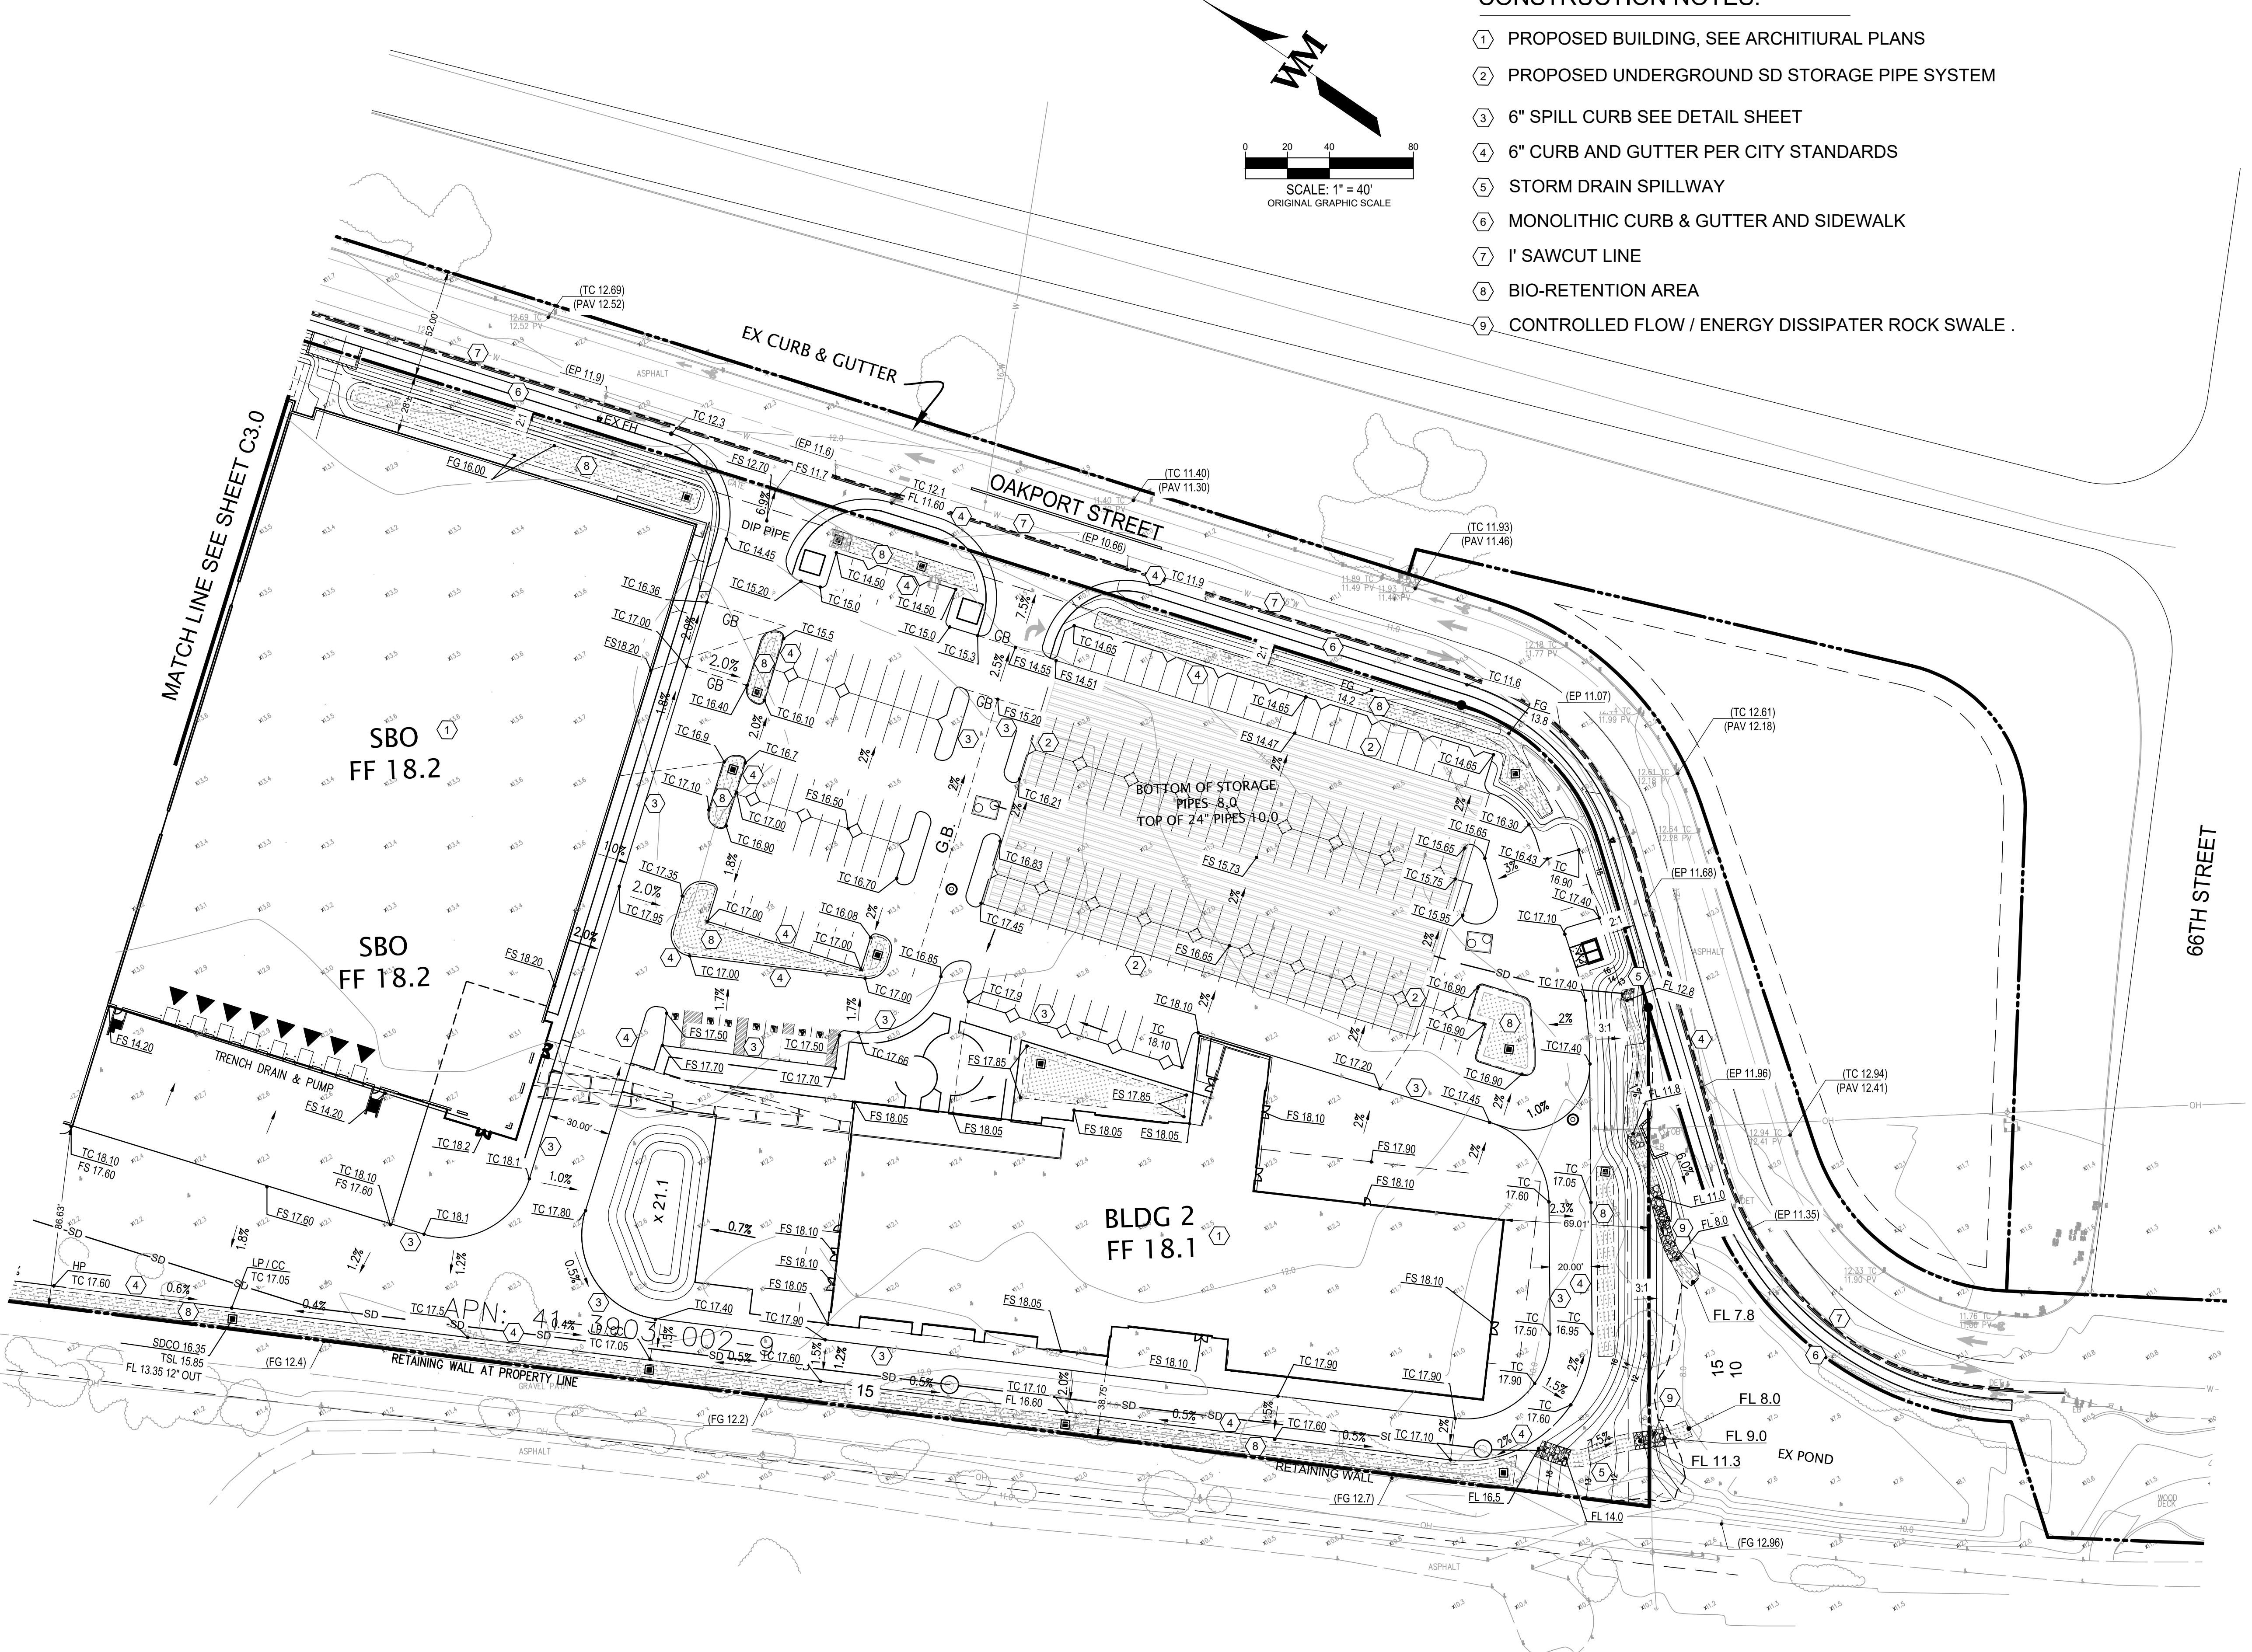


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### CONSTRUCTION NOTES:

- ① PROPOSED BUILDING, SEE ARCHITIURAL PLANS
- ② PROPOSED UNDERGROUND SD STORAGE PIPE SYSTEM
- ③ 6" SPILL CURB SEE DETAIL SHEET
- ④ 6" CURB AND GUTTER PER CITY STANDARDS
- ⑤ STORM DRAIN SPILLWAY
- ⑥ MONOLITHIC CURB & GUTTER AND SIDEWALK
- ⑦ I' SAWCUT LINE
- ⑧ BIO-RETENTION AREA
- ⑨ CONTROLLED FLOW / ENERGY DISSIPATER ROCK SWALE .



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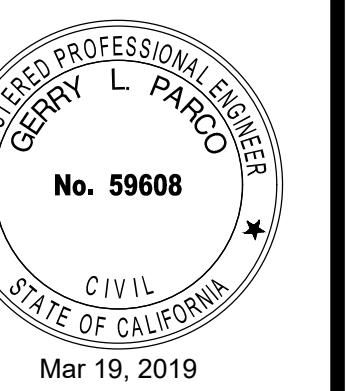
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**C3.1**  
Sheet 4 of 11



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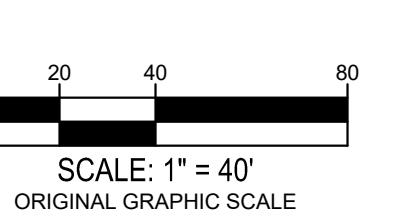
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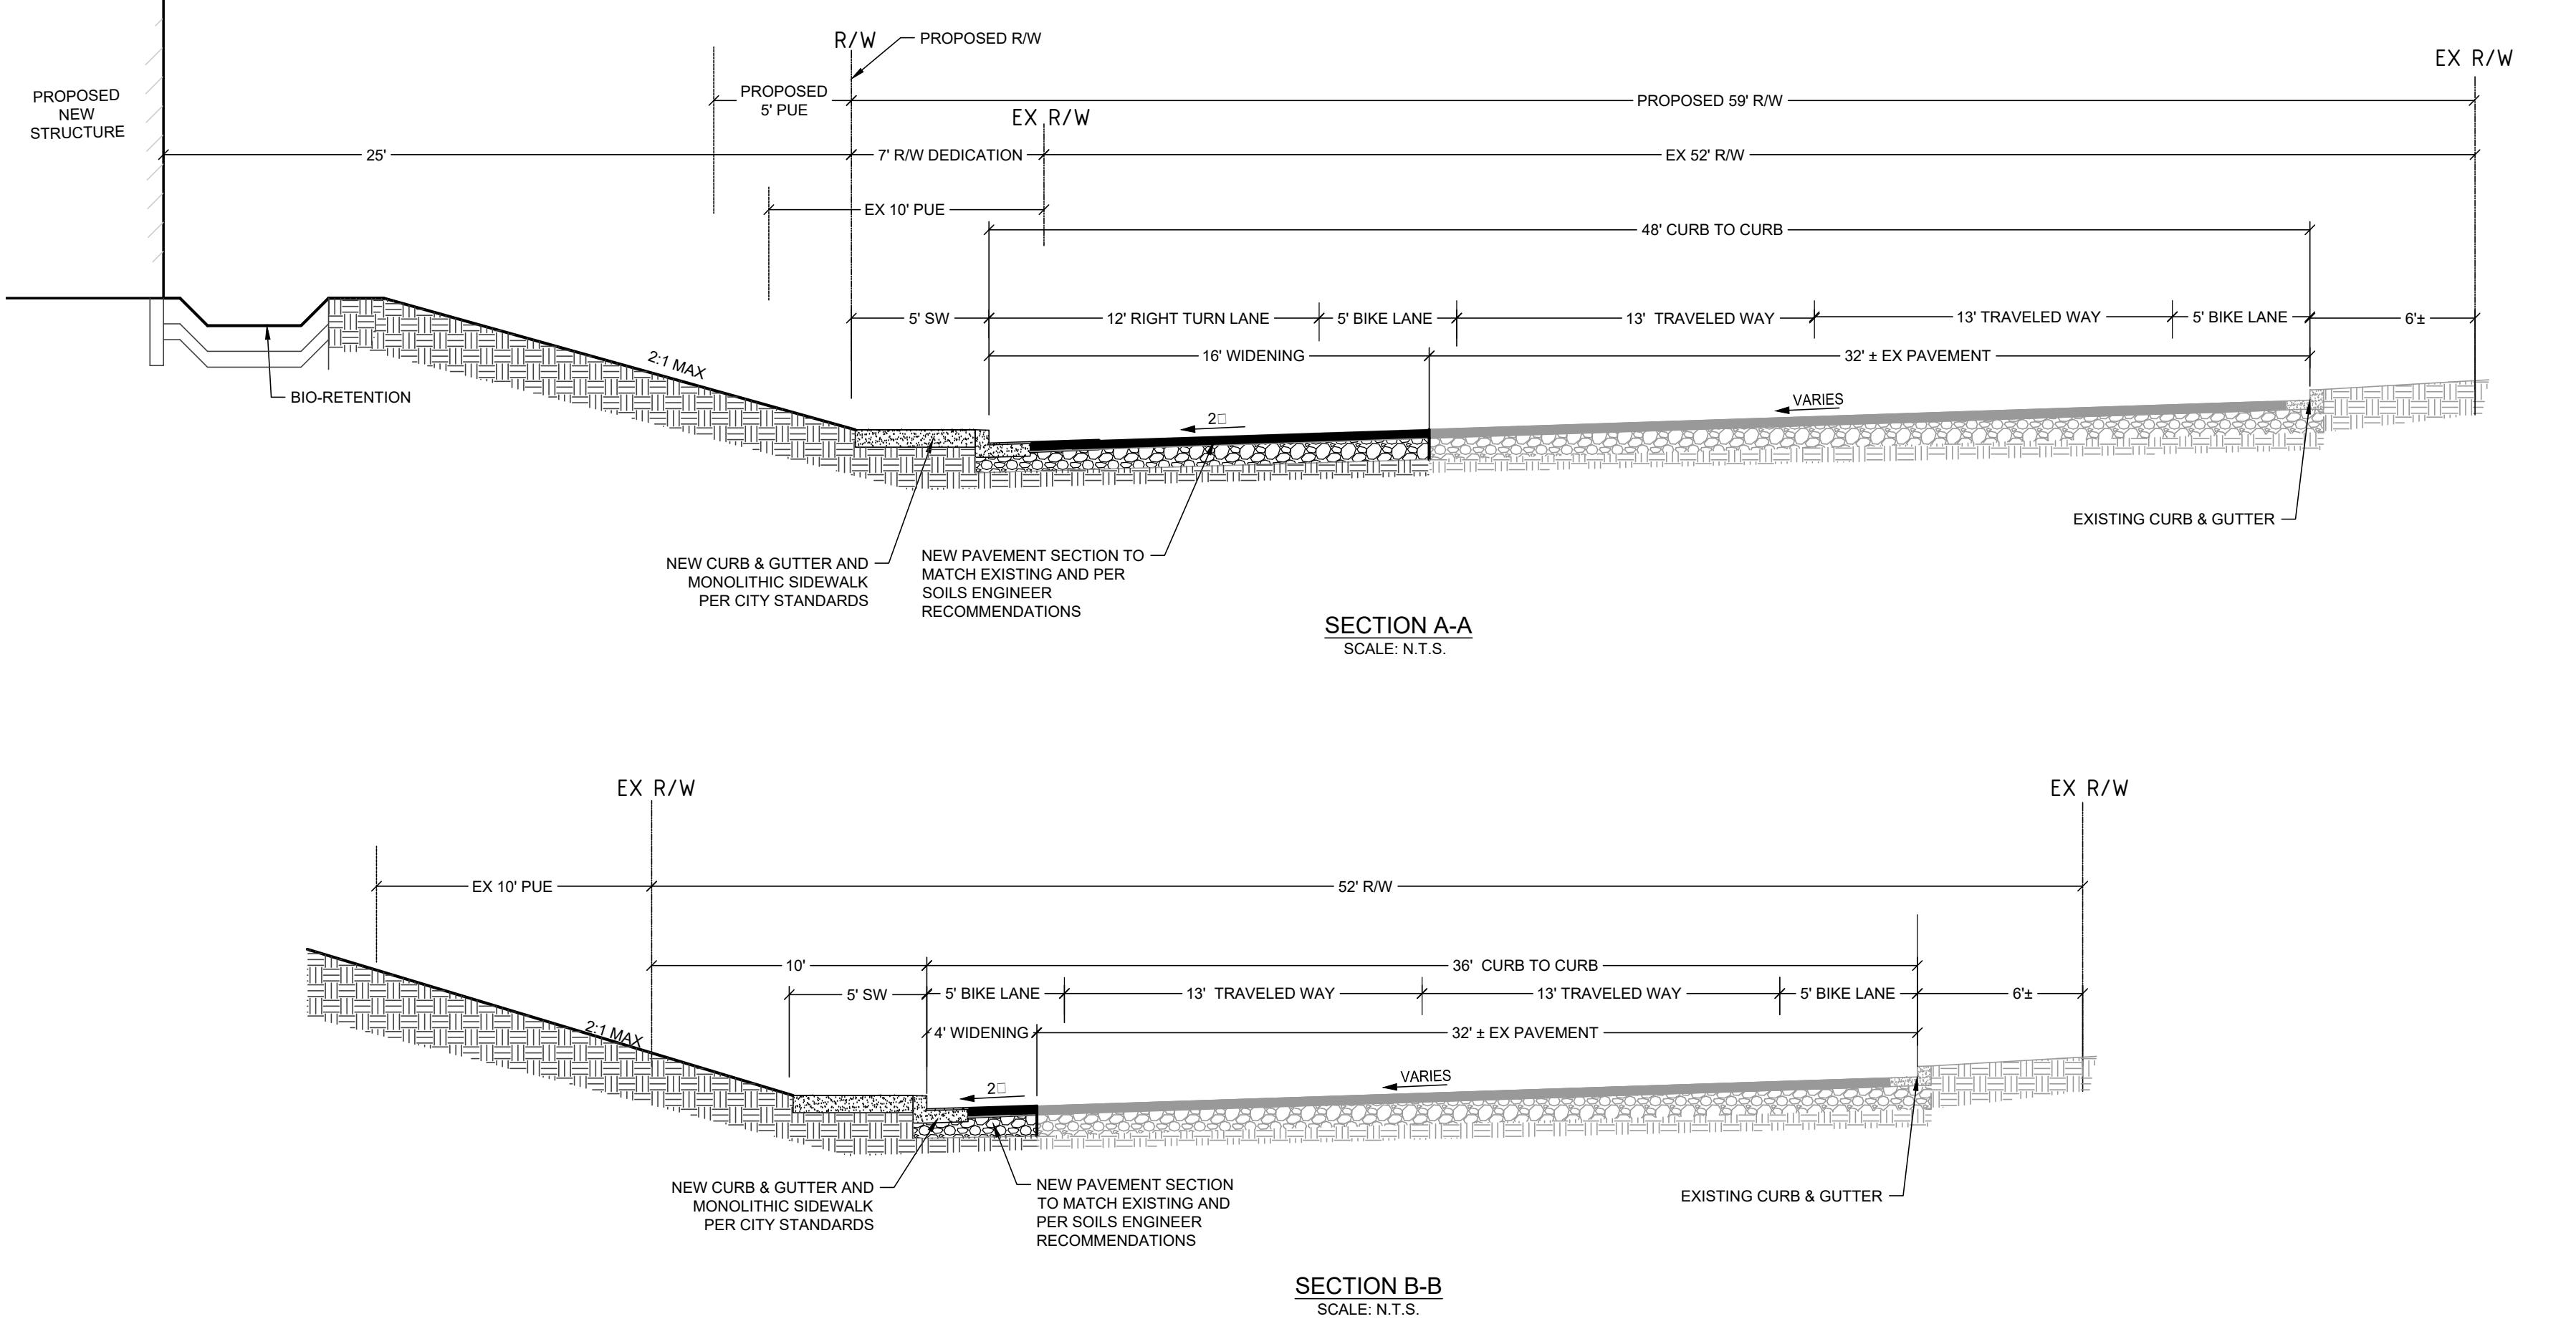
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SHEET	C3.2
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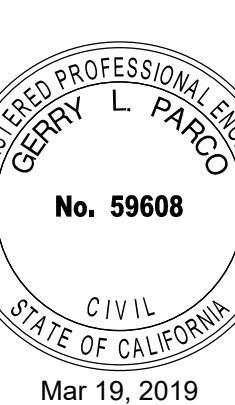




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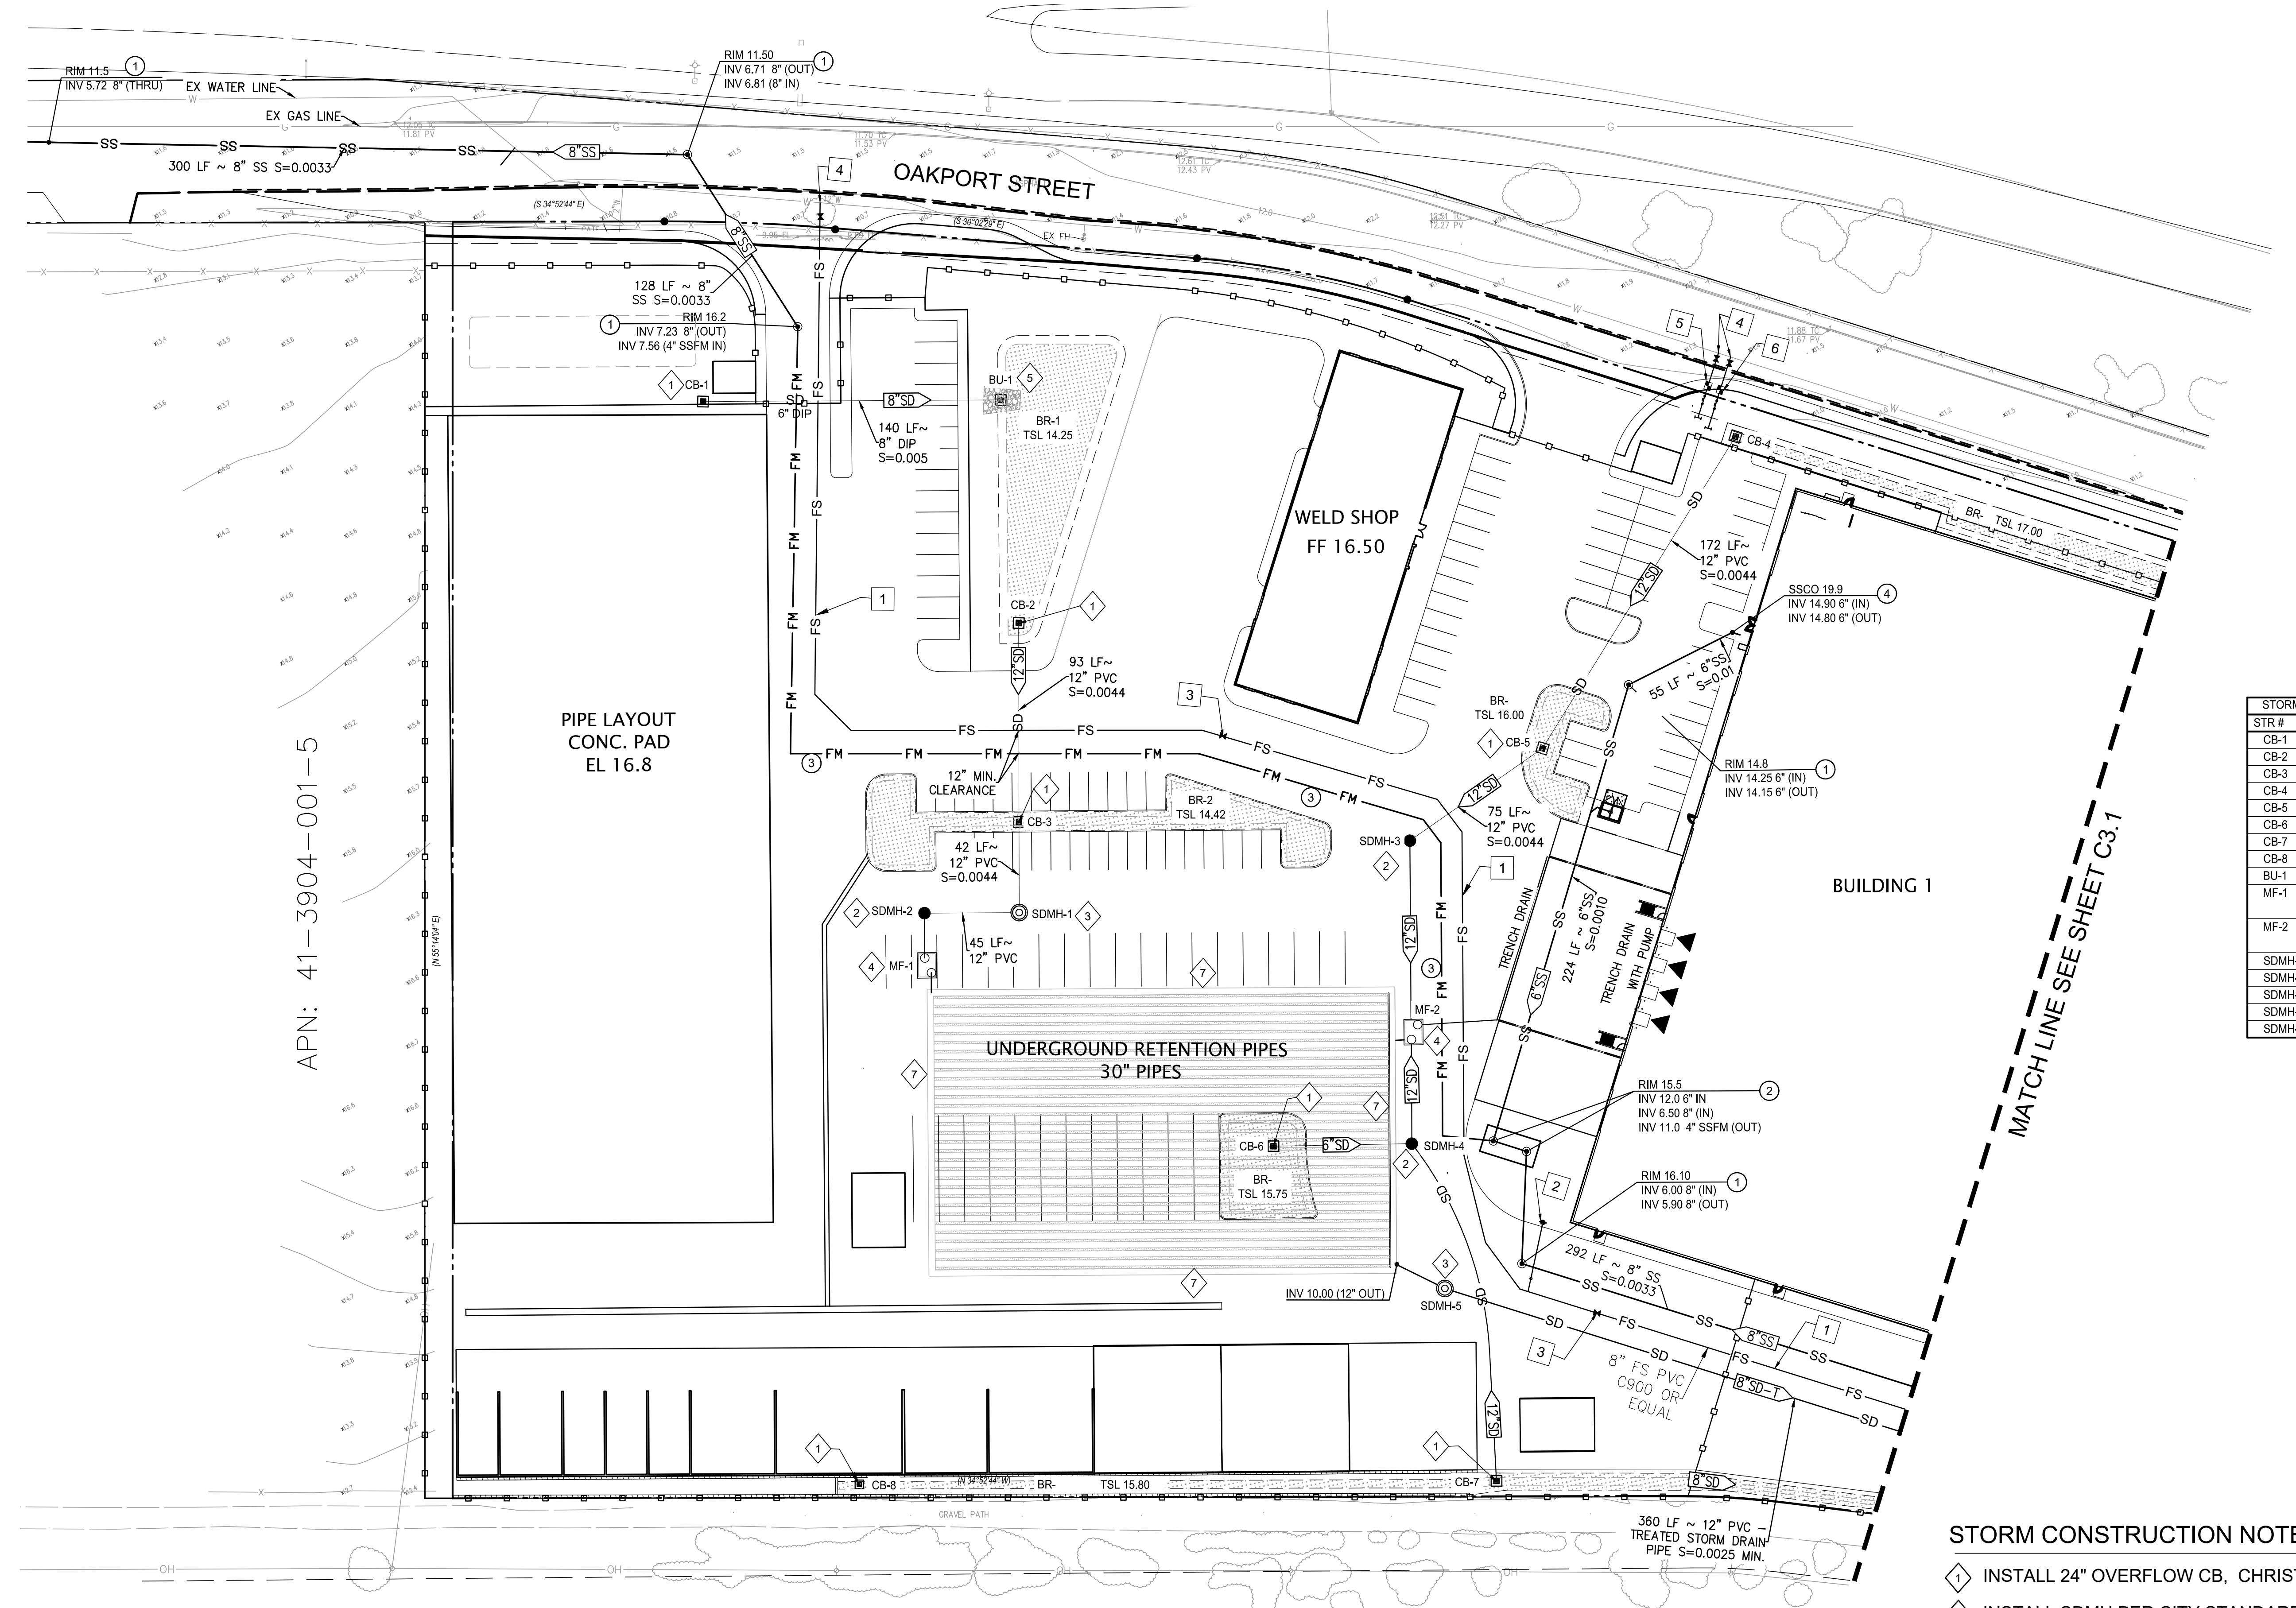
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### WATER CONSTRUCTION NOTES:

- ① INSTALL NEW FIRE SERVICE LINE C900 PR APPROVED EQUAL.
- ② INSTALL NEW FIRE HYDRANT PER CITY STANDARDS
- ③ NEW SECTIONAL VALVE PER EBMUD STD.
- ④ CONNECT TO EXISTING 16" MAIN PER E.B.U.D. STD.
- ⑤ INSTALL WM AND IRRIGATION LINE PER E.B.M.U.D. STD.
- ⑥ INSTALL WM AND DOMESTIC WATER LINE PER E.B.U.D. STD.

### SEWER CONSTRUCTION NOTES

- ① INSTALL NEW SSMH PER CITY STANDARDS.
- ② INSTALL NEW SEWER LIFT STATION
- ③ INSTALL 4" SS FORCE MAIN.
- ④ INSTALL 4" SS CO

### STORM CONSTRUCTION NOTES:

- ① INSTALL 24" OVERFLOW CB, CHRISTY OR EQUAL.
- ② INSTALL SDMH PER CITY STANDARDS
- ③ INSTALL SDMH WITH PUMP
- ④ INSTALL MEDIA FILTER STORM WATER TREATMENT DEVICE
- ⑤ INSTALL NEW BUBBLE-UP
- ⑥ TREATED STORM DRAIN PIPE.
- ⑦ UNDERGROUND STORM WATER STORAGE SYSTEM

NOTES:  
ALL PIPES SHALL BE PVC SDR-35 OR APPROVED EQUAL  
UNLESS OTHERWISE NOTED.

CONCEPTUAL UTILITY PLAN	
REMARKS	

JOB NO.: SNR17-0069  
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SHEET  
**C4.0**

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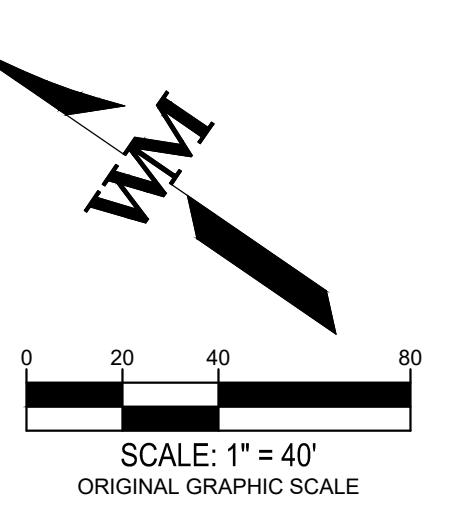
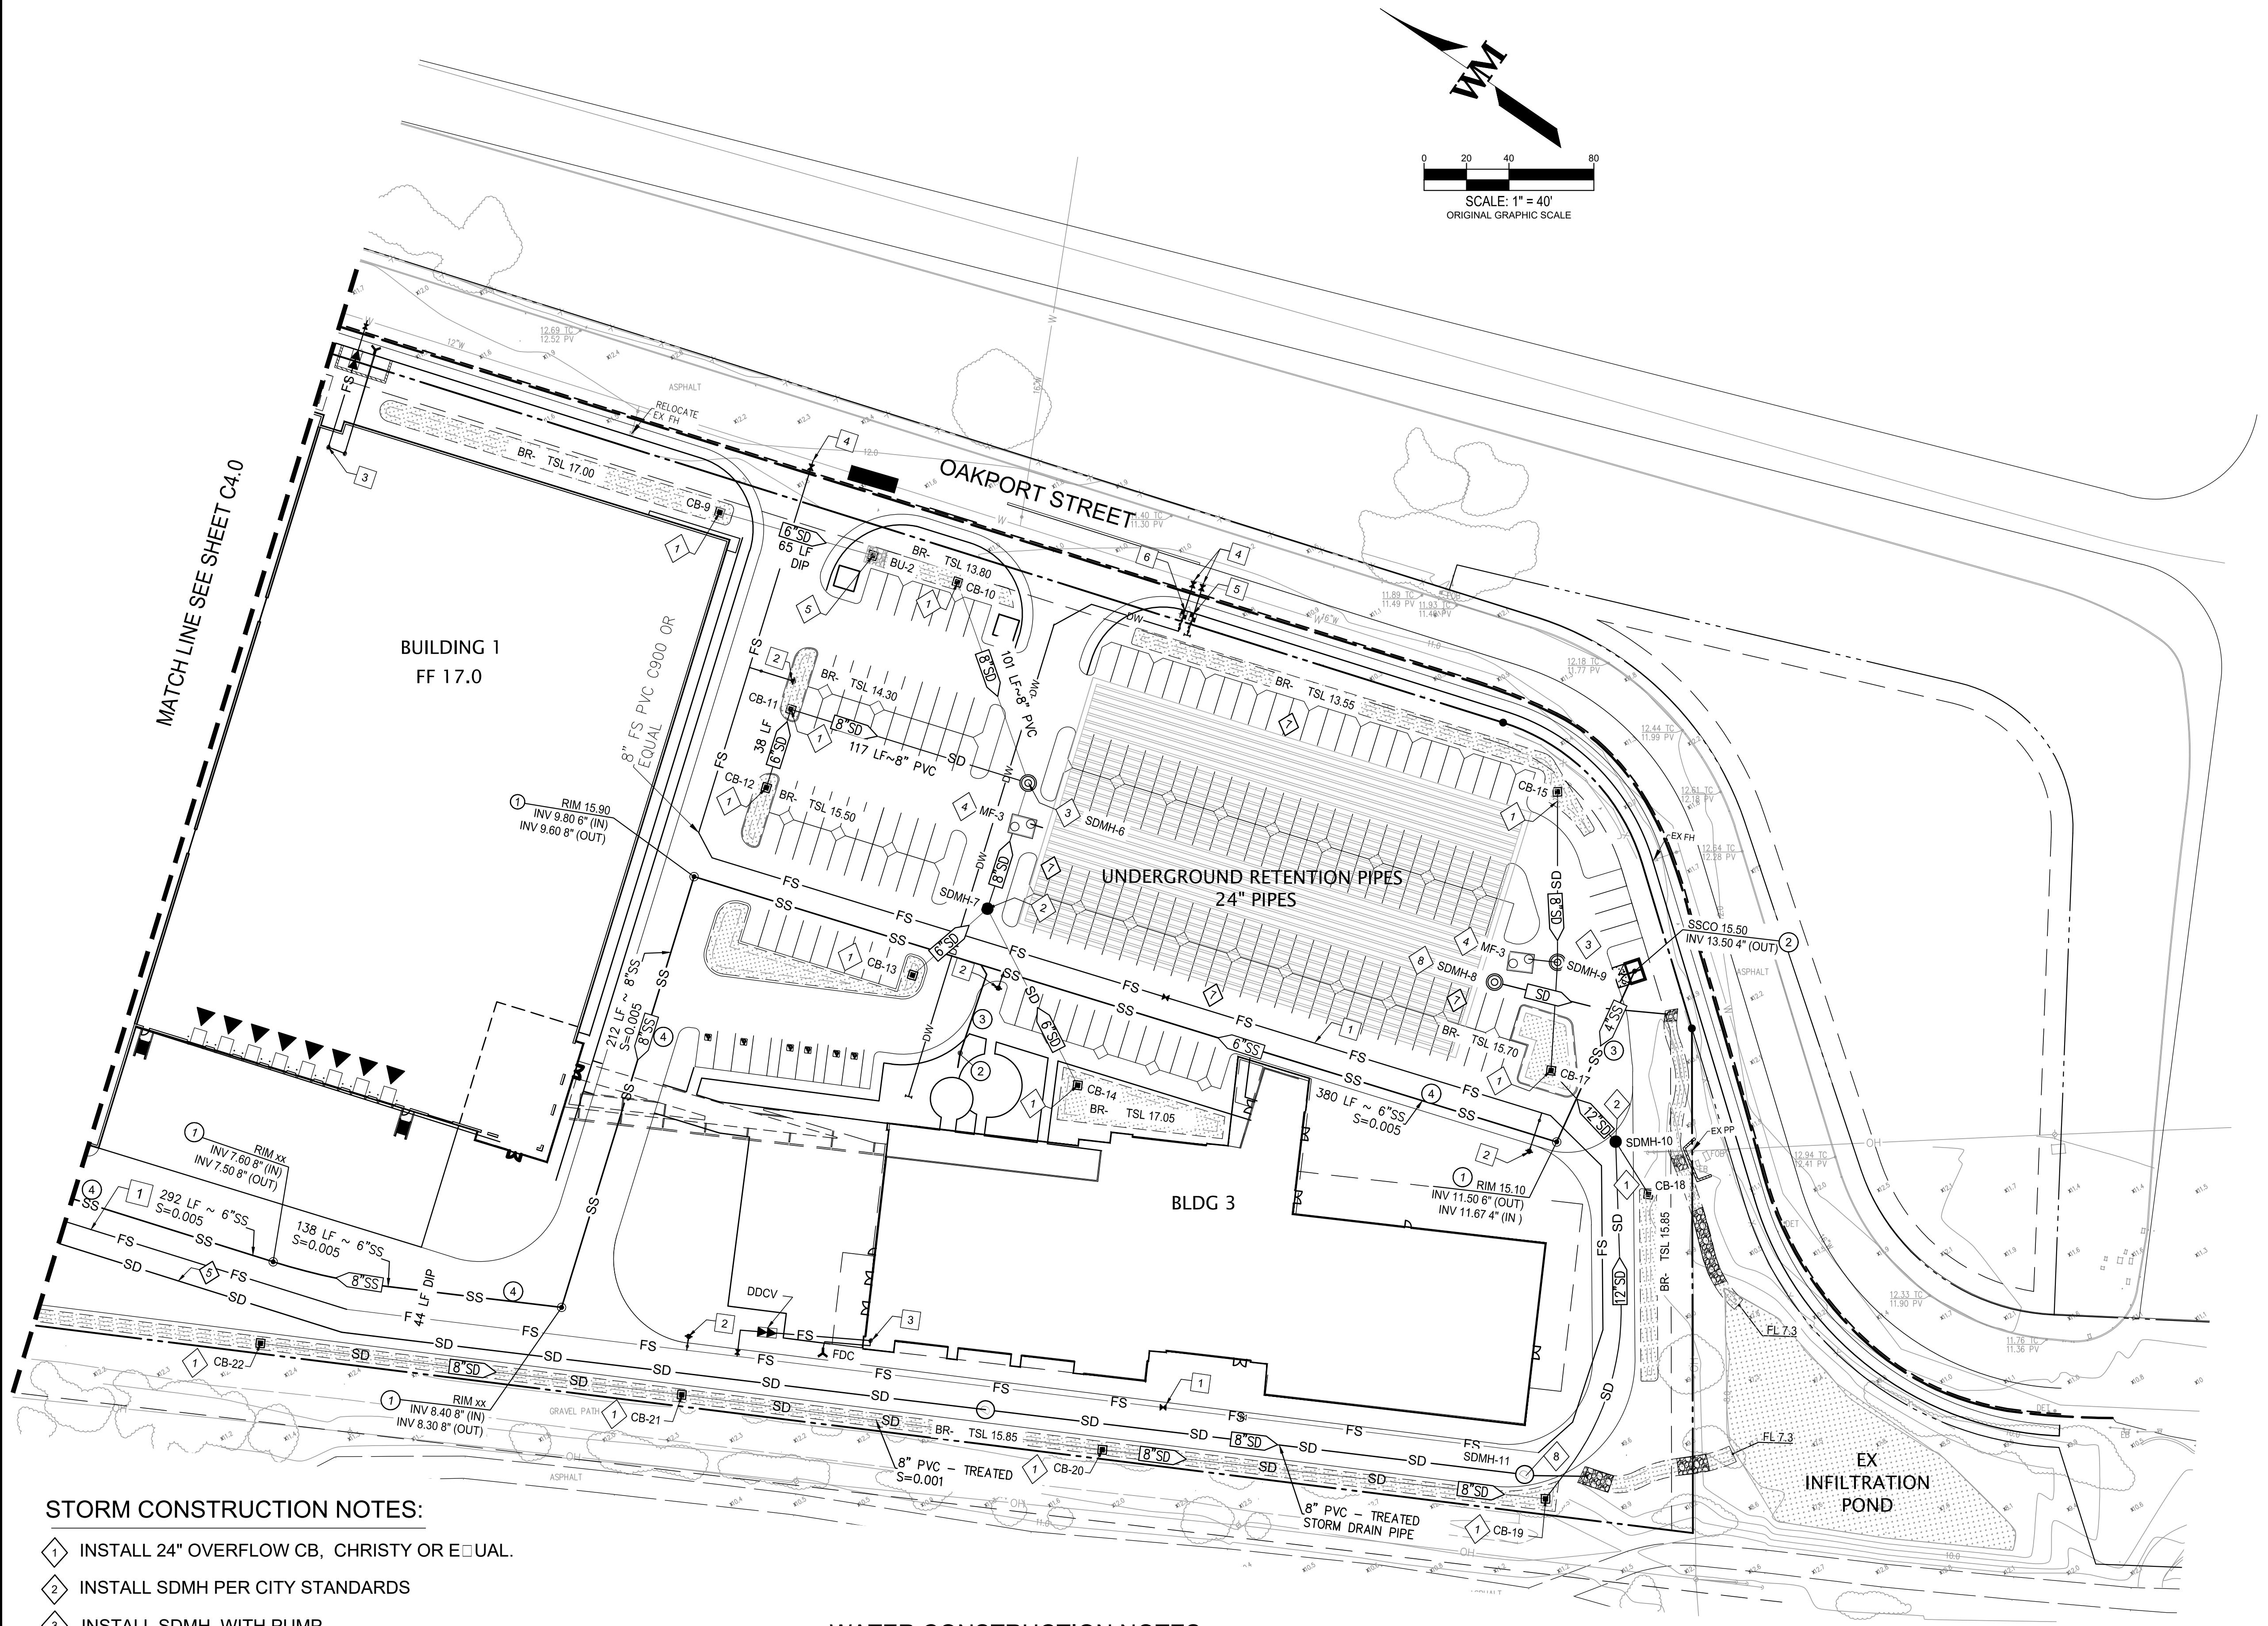
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CONCEPTUAL UTILITY PLAN		
NO.	DATE	REMARKS

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**C4.1**  
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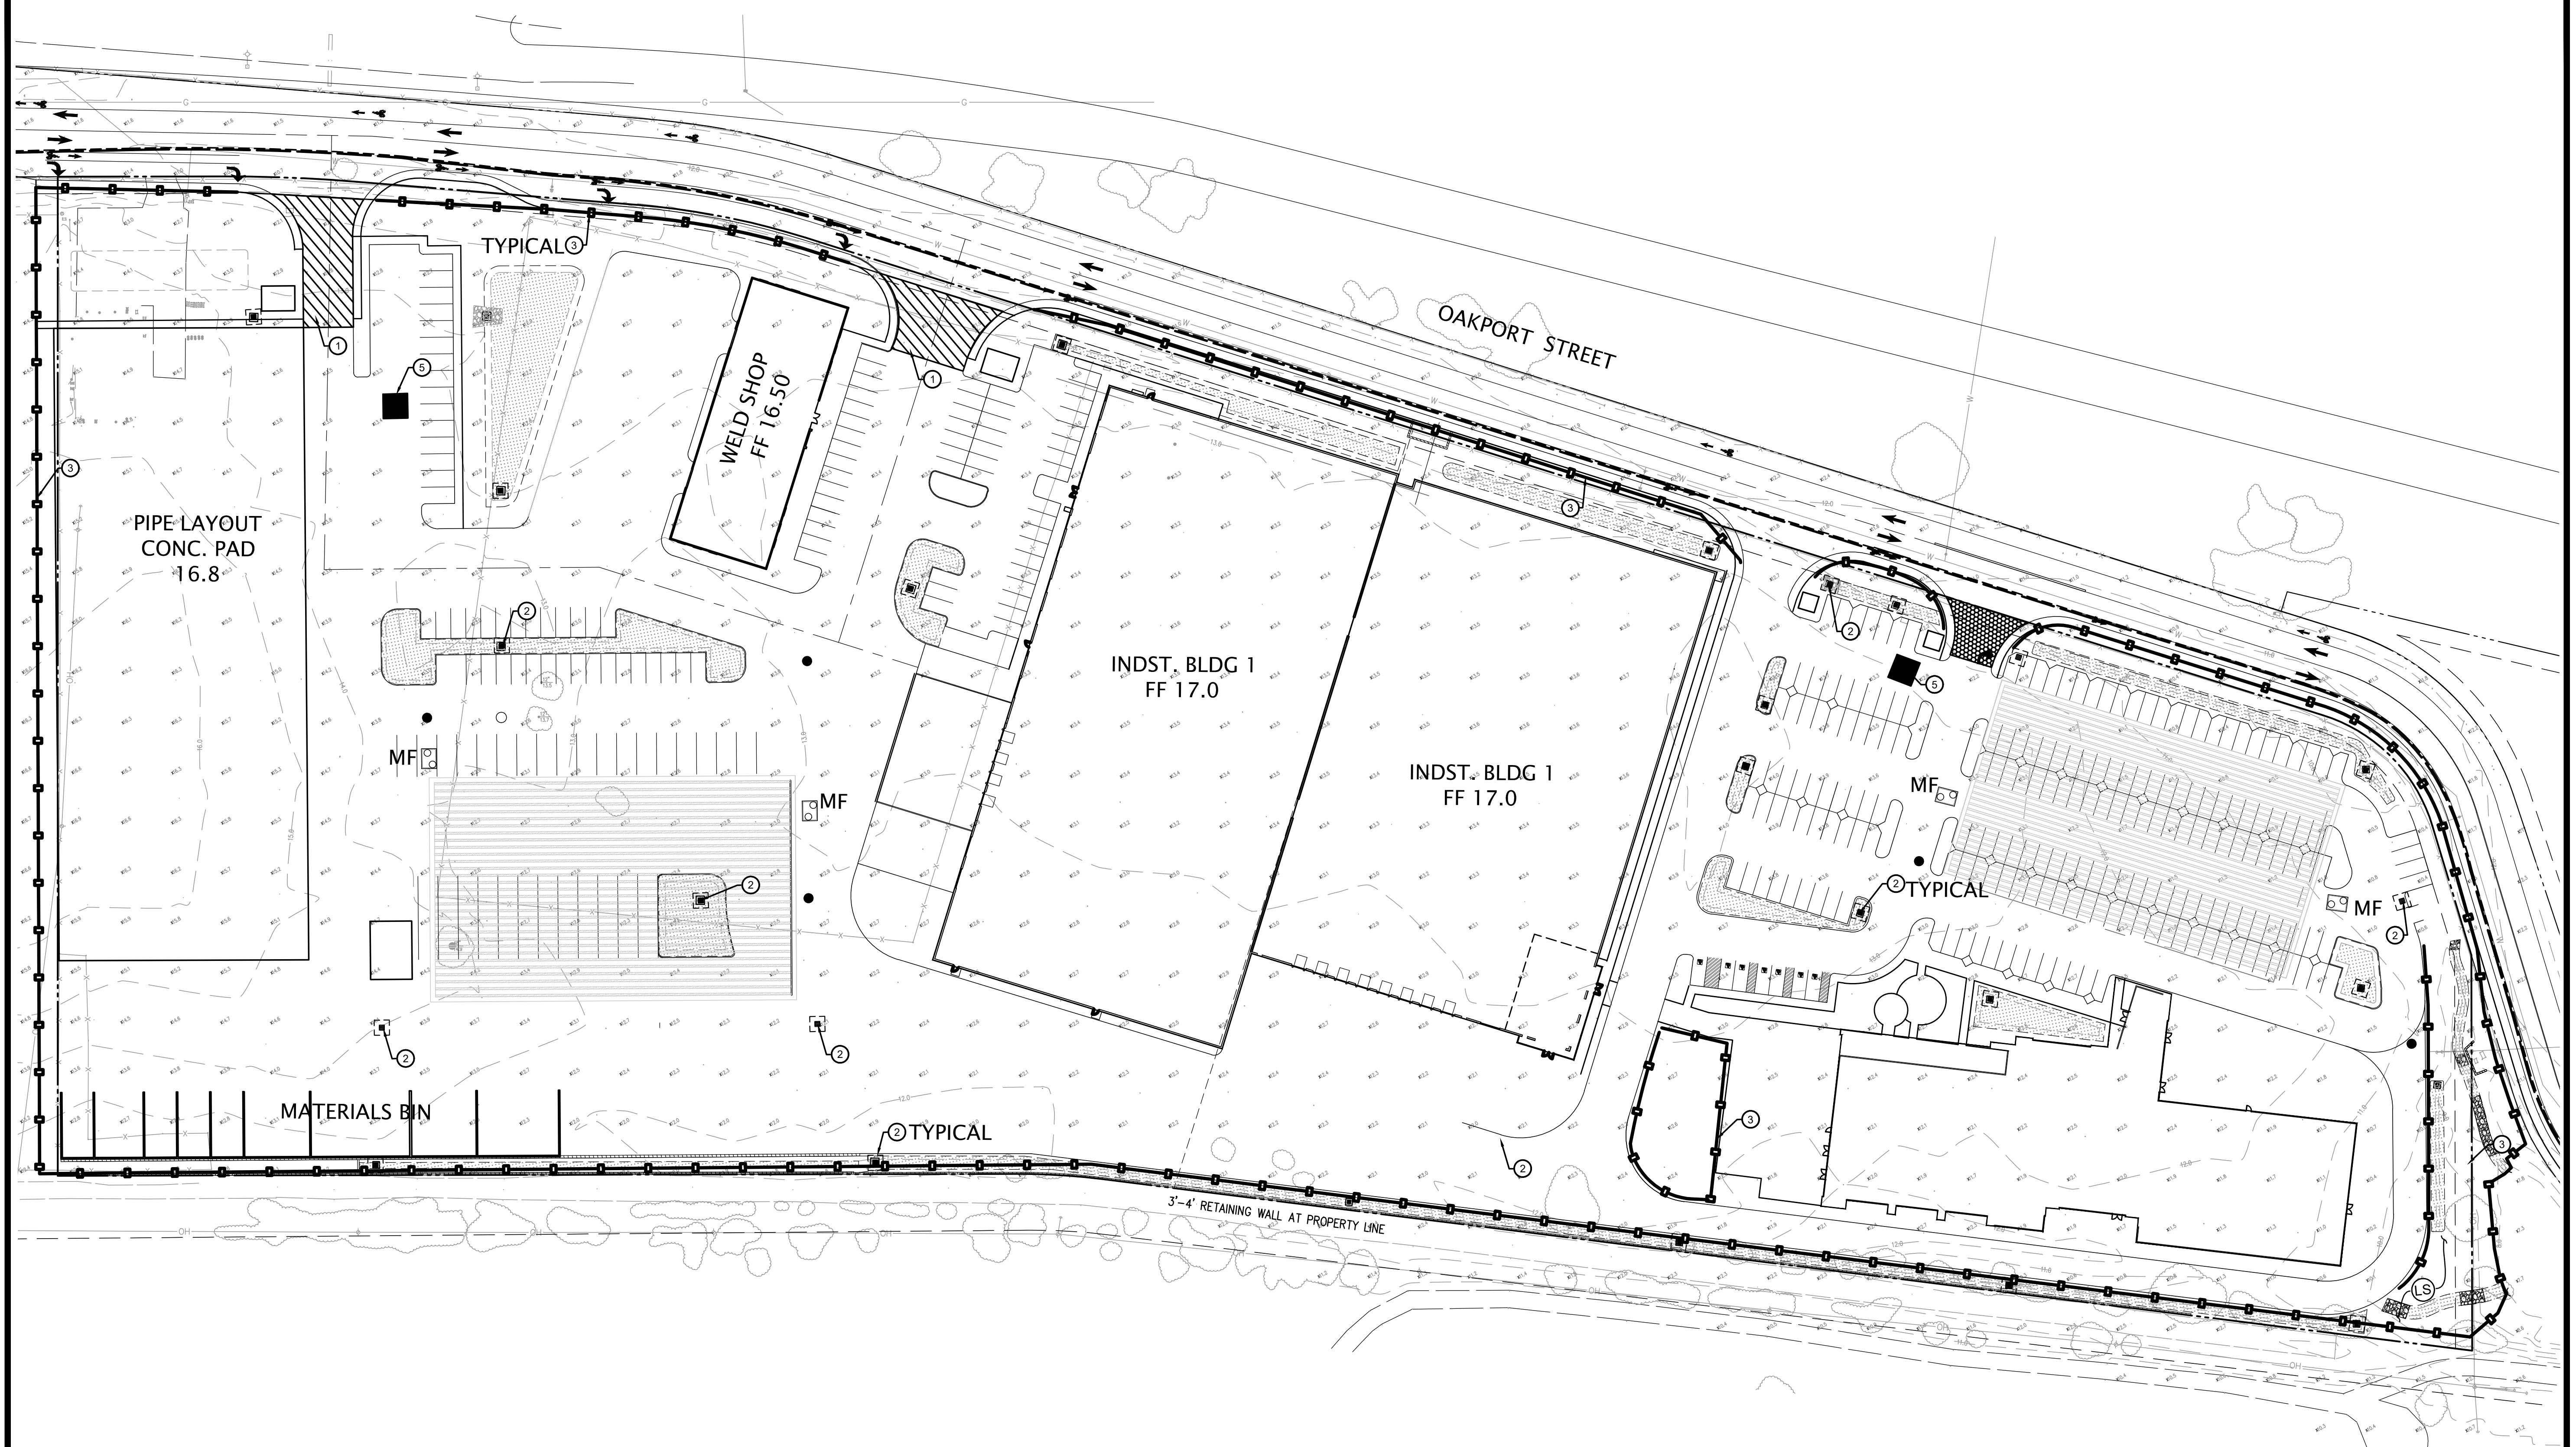


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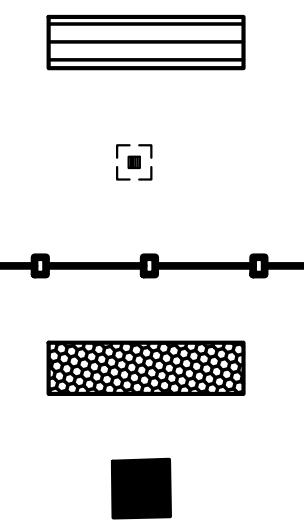
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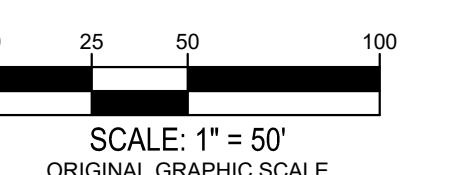
### LEGEND

- ① STABILIZED CONSTRUCTION ENTRANCE WITH RUMBLE STRIPS SEE DETAIL D SHEET C6.1
- ② INLET PROTECTION SEE DETAIL A SHEET C6.1
- ③ FIBER ROLL / SILT FENCE BARRIER SEE DETAIL C SHEET C6.1
- ④ STABILIZED CONSTRUCTION ENTRANCE WITH COARSE AGGREGATE SEE DETAIL D SHEET C6.1
- ⑤ CONCRETE WASH OUT AREA SEE DETAIL B SHEET C6.1



### ABBREVIATIONS

CDS MECHANICAL WATER TREATMENT DEVICE BY



SCALE: 1" = 50'  
ORIGINAL GRAPHIC SCALE



JOB NO.: SNR17-0069  
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Sheet C5.0  
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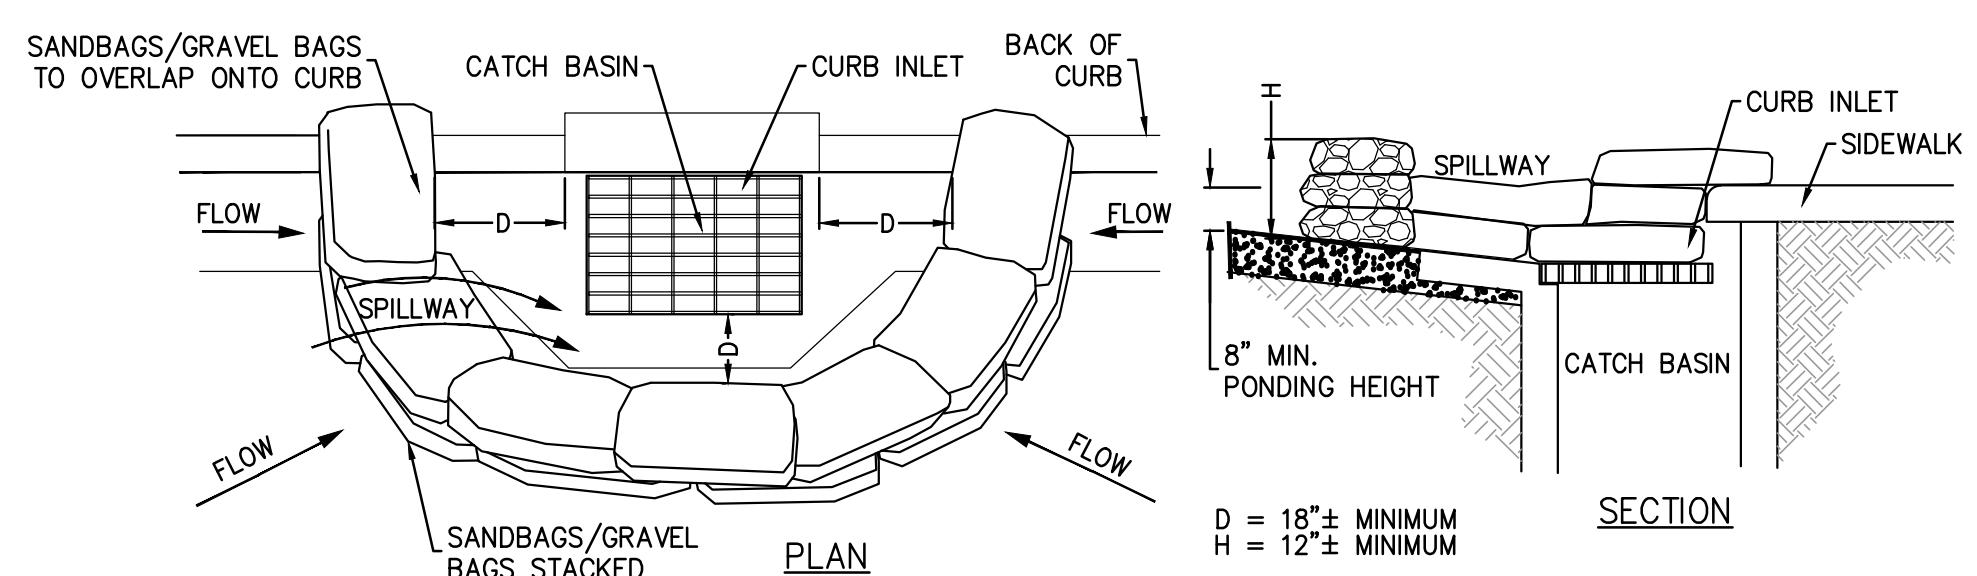
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### EROSION CONTROL DETAILS

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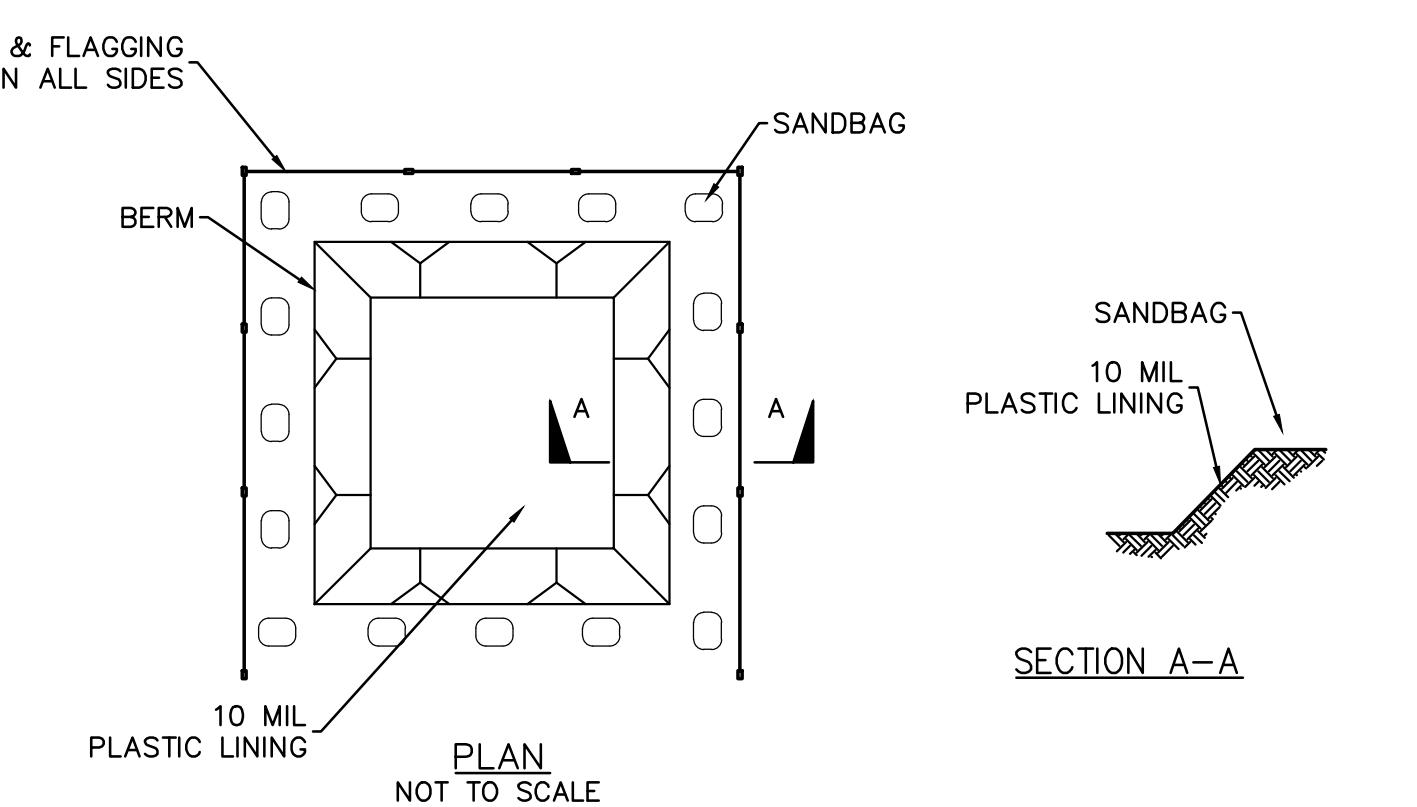
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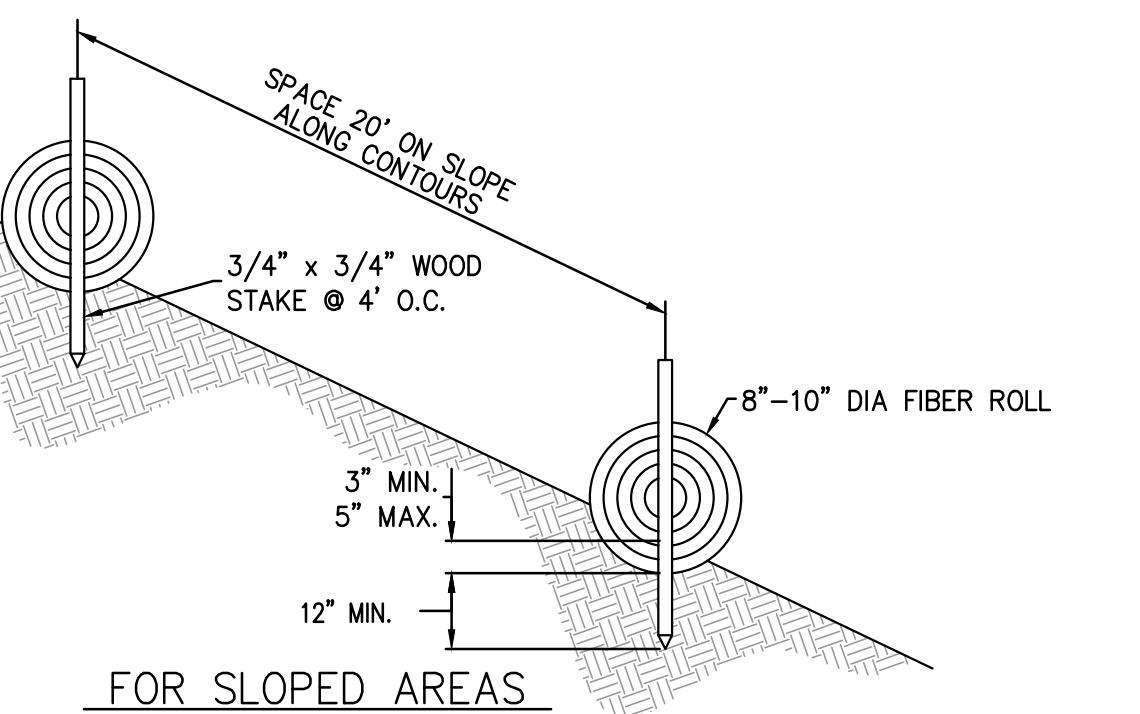
**NOTES:**

- CATCH BASIN/INLET PROTECTION SHALL BE INSTALLED WHEREVER THERE IS A POTENTIAL OF STORMWATER OR NON-STORMWATER BEING DISCHARGED INTO IT.
- INLET PROTECTION IS REQUIRED ALONG WITH OTHER POLLUTION PREVENTION MEASURES SUCH AS: EROSION CONTROL, SOIL STABILIZATION, AND MEASURES TO PREVENT TRACKING ONTO PAVED SURFACES. MODIFY INLET PROTECTION AS NEEDED TO AVOID CREATING TRAFFIC HAZARDS.
- INCLUDE INLET PROTECTION MEASURES AT HILLSIDE V-DITCHES AND MISC. DRAINEAGE SWALES.
- INLET PROTECTION SHALL BE INSPECTED AND ACCUMULATED SEDIMENTS REMOVED. SEDIMENT SHALL BE DISPOSED OF PROPERLY IN A MANNER THAT ASSURES THAT THE SEDIMENT DOES NOT ENTER THE STORM DRAIN SYSTEM.
- DAMAGED BAGS SHALL BE REPLACED IMMEDIATELY.
- ADDITIONAL SANDBAG SEDIMENT TRAPS SHALL BE PLACED AT INTERVALS AS INDICATED ON SITE PLAN.
- REFER TO CASQA SE-10 STORM DRAIN INLET PROTECTION FOR ADDITIONAL GUIDANCE.



**NOTES:**

- ACTUAL LAYOUT DETERMINED IN FIELD.
- THE CONCRETE WASHOUT SIGN SHALL BE INSTALLED WITHIN 30 FT. OF THE TEMPORARY CONCRETE WASHOUT FACILITY.




**NOTES:**

- FIBER ROLL COMPOSED OF BIO-DEGRADABLE FIBERS STUFFED INTO A PHOTO-DEGRADABLE OPEN WEAVE NETTING.
- FIBER ROLL EROSION BARRIER TRAPS SEDIMENT AND REDUCES SHEET AND HILL SIDE EROSION BY REDUCING SLOPE GRADIENT, IT INCREASING INFILTRATION RATES AND BY PRODUCING A FAVORABLE ENVIRONMENT FOR PLANT ESTABLISHMENT.
- FIBER ROLL INSTALLATION REQUIRES THE PLACEMENT AND SECURE STAKING OF THE FIBER ROLL IN A TRENCH 3'-5" DEEP, DUG ON CONTOUR. RUNOFF MUST NOT BE ALLOWED TO RUN UNDER OR AROUND FIBER ROLL.

### CATCH BASIN/DRAIN INLET PROTECTION (A)


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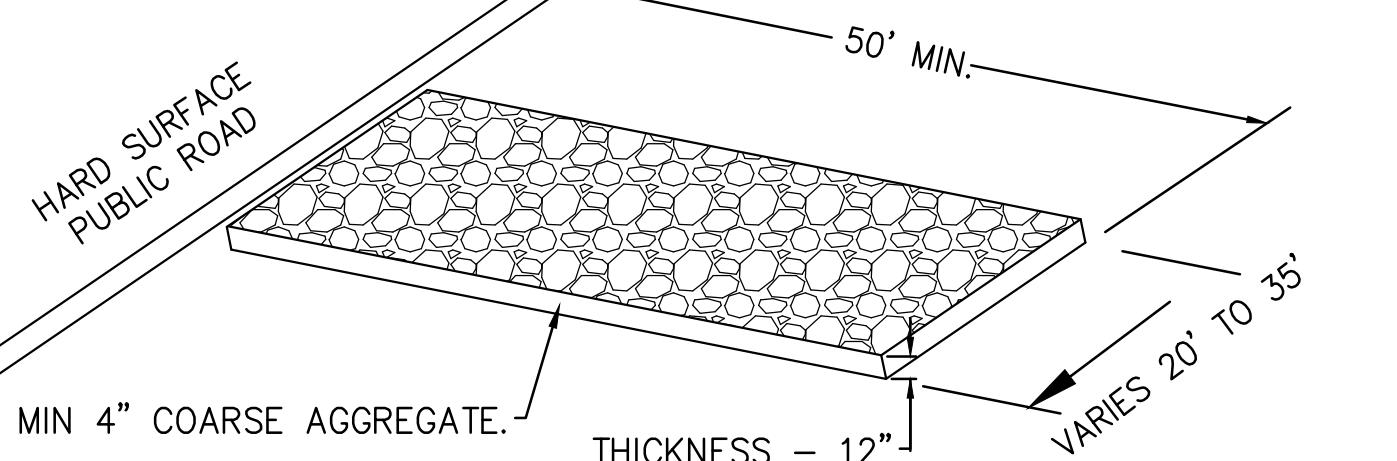
SCALE: N.T.S.
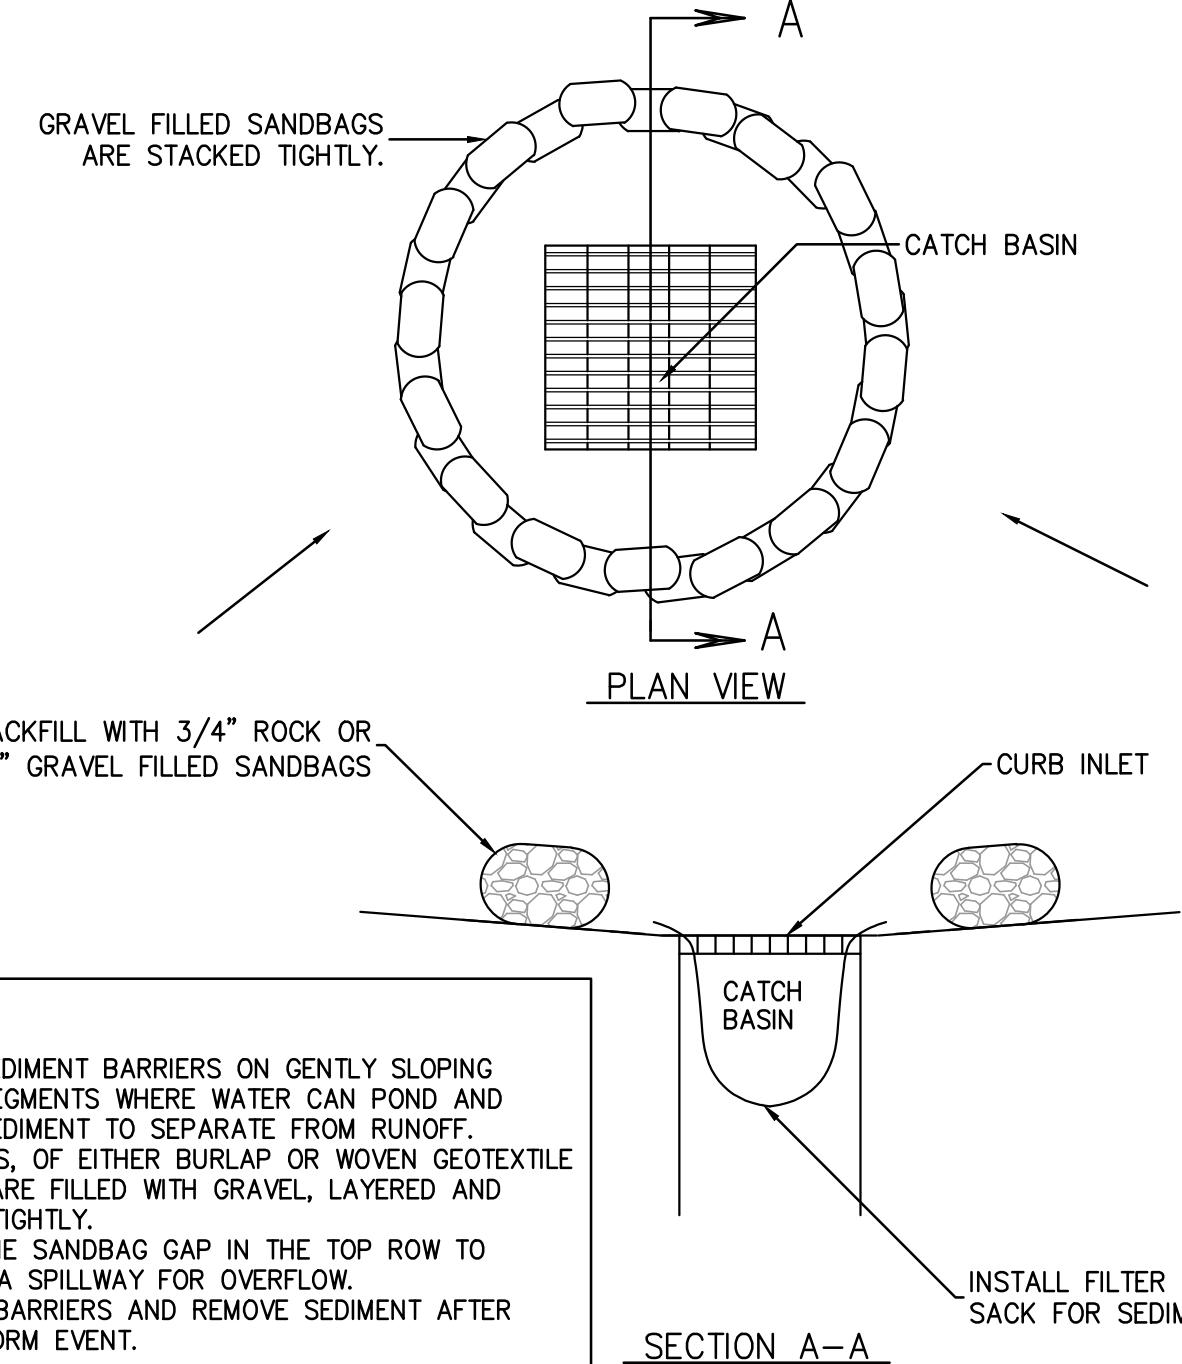
### STABILIZED ENTRANCE WITH RUMBLE STRIPS (D)

SCALE: N.T.S.




### STABALIZED ENTRANCE WITH COARSE AGGREGATE (D)

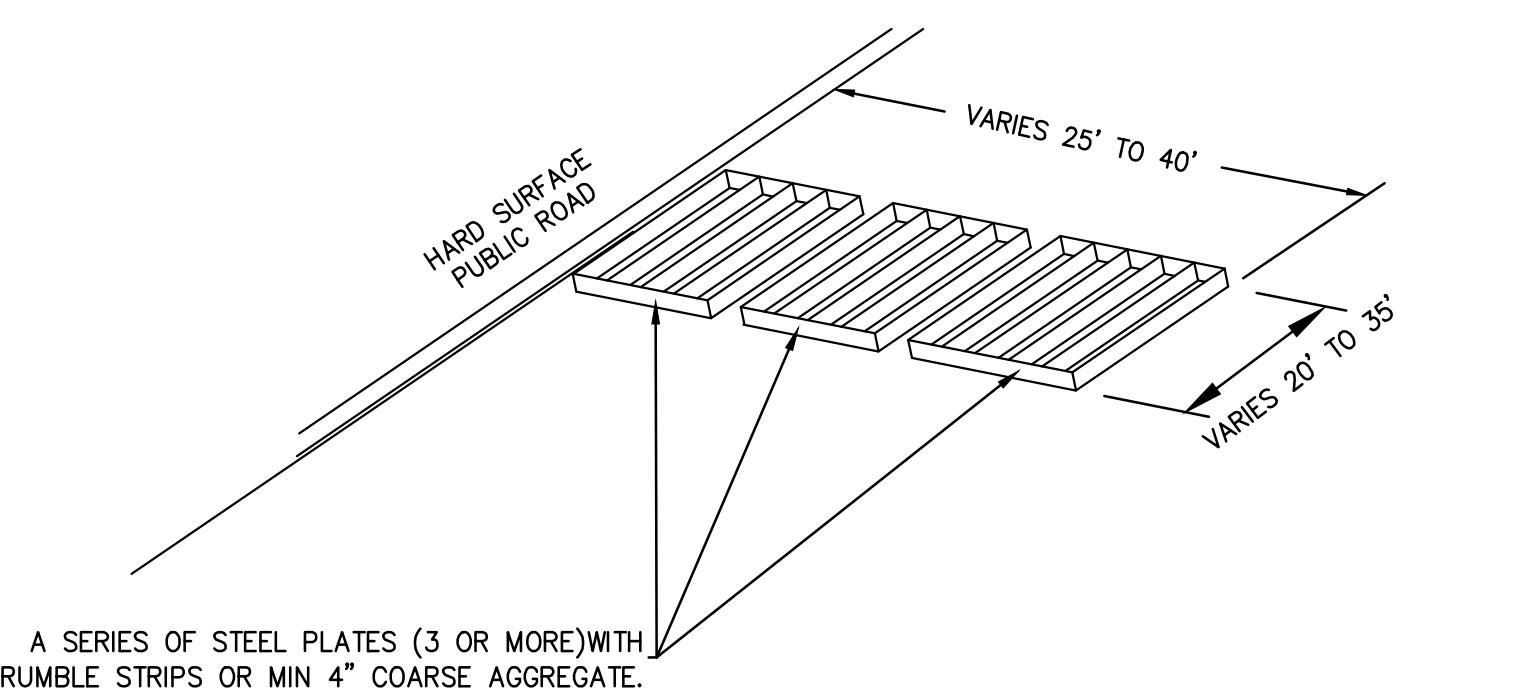

SCALE: N.T.S.

### FIBER ROLL EROSION BARRIER (C)

SCALE: N.T.S.

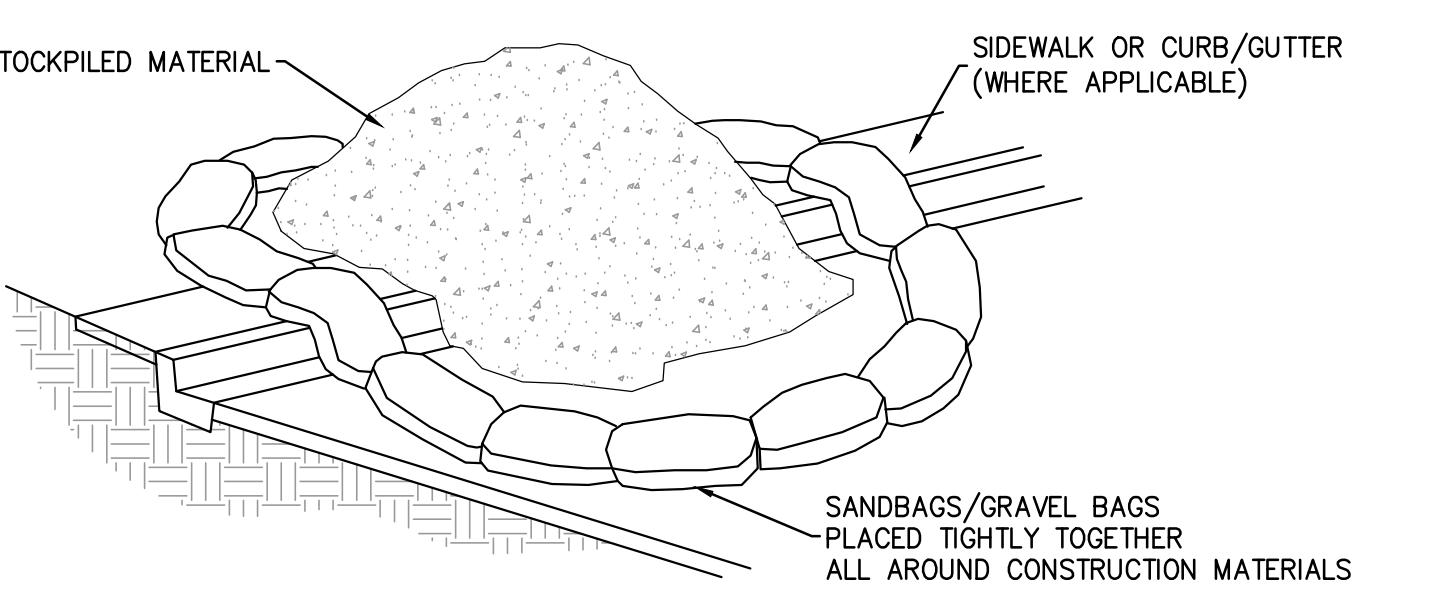


#### STOCK PILING NOTE:

- DIRT AND OTHER CONSTRUCTION RELATED MATERIALS PLACED IN THE STREET OR ON OTHER IMPERVIOUS SURFACES MUST BE CONTAINED WITH SANDBAGS OR OTHER MEASURES TO PREVENT TRANSPORT TO THE STORM DRAIN SYSTEM. ANY CONSTRUCTION MATERIAL STORED OR STOCKPILED ON-SITE SHALL BE PROTECTED FROM BEING TRANSPORTED BY THE FORCE OF WIND OR WATER. COVER MATERIAL WITH PLASTIC SHEETS (MIN. 10 MIL) WITH SAND BAGS FOR ANCHORING.
- REFER TO CASQA VM-3 STOCKPILE MANAGEMENT FOR ADDITIONAL GUIDANCE.

### MATERIAL STOCK PILING (F)

SCALE: N.T.S.

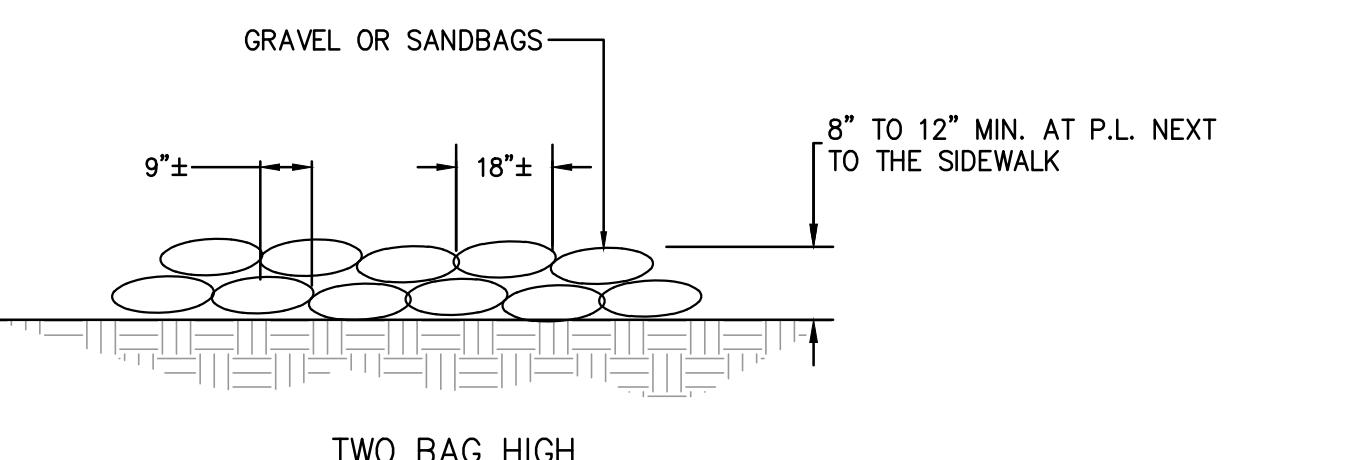

SCALE: N.T.S.

REMARKS	
NO.	
DATE	

Sheet 9 of 11



Know what's below.  
Call 811 before you dig.

## ABBREVIATIONS &amp; LEGEND

MF	MEDIA FILTER
DMA	DRAINAGE MANAGEMENT AREA
LS	LANDSCAPE AREA
ST	SELF TREATED AREA
UT	UNTREATED AREA
BR	BIO-TREATMENT AREA
	BR-10

19

SCALE: 1"=50'  
0 25 50 100  
SCALE: 1" = 50'  
ORIGINAL GRAPHIC SCALE

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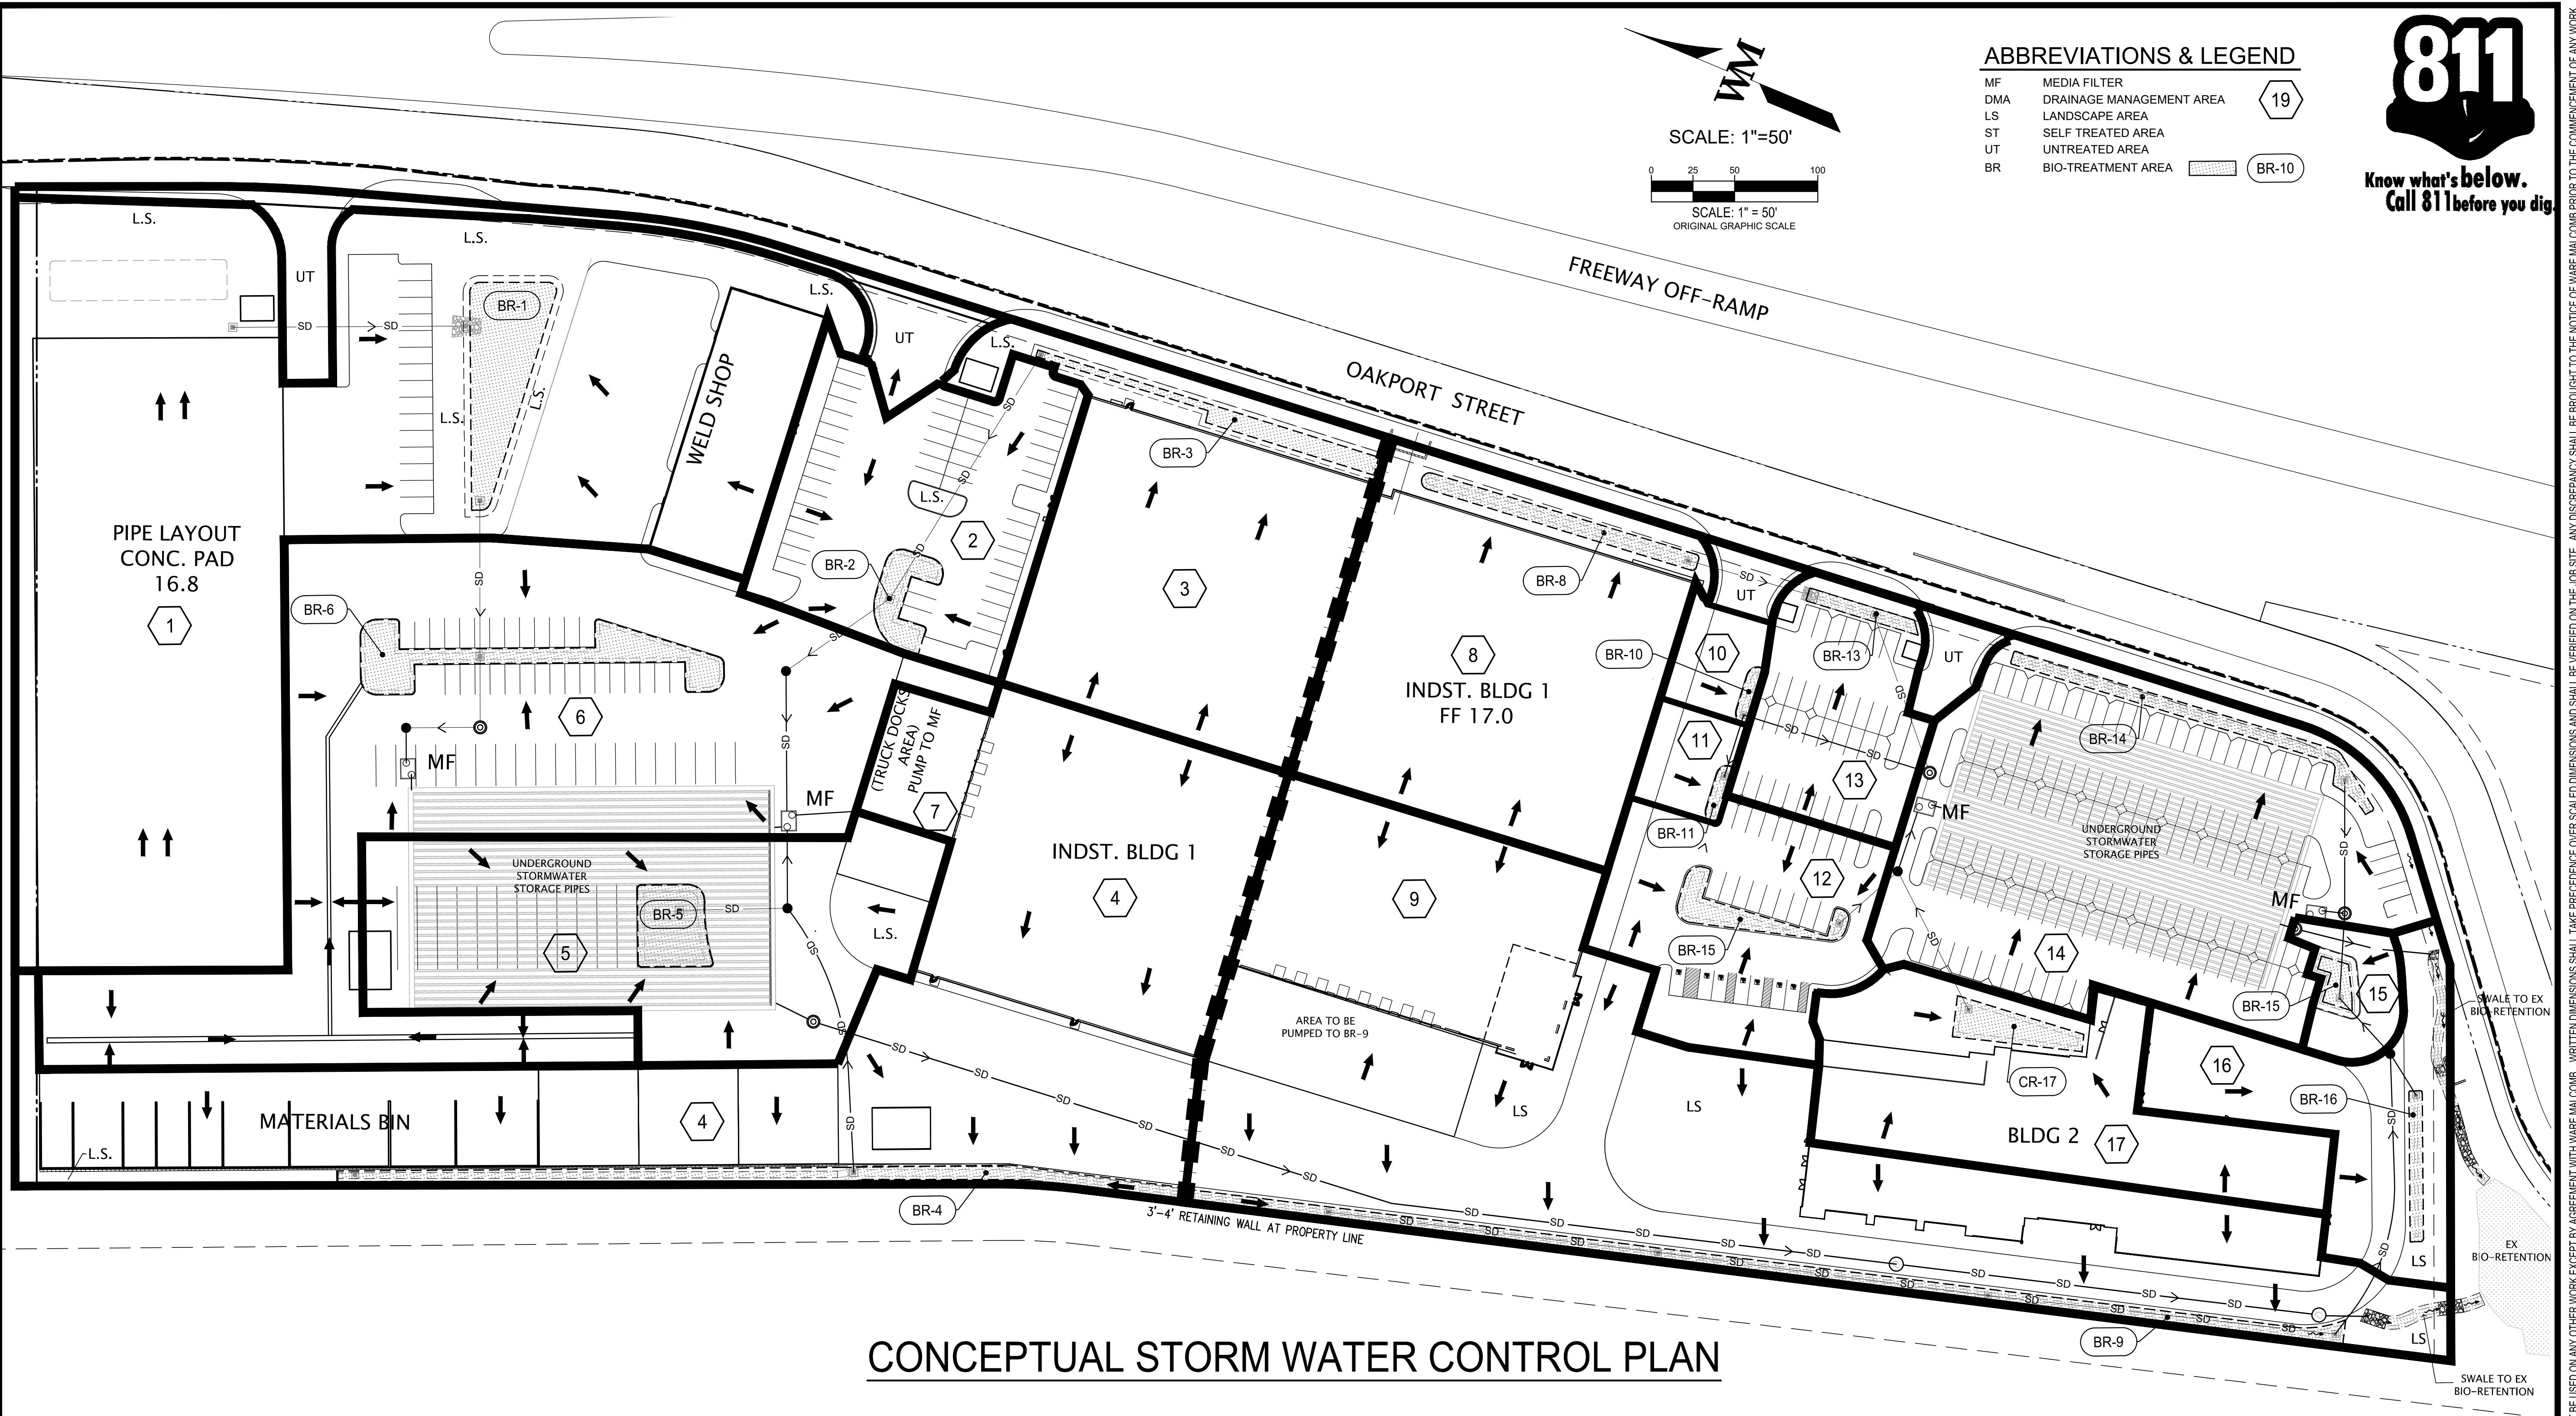
4683 chabot dr  
suite 300  
pleasanton, ca 94588  
waremalcomb.com



FOR AND ON BEHALF  
OF WARE MALCOMB

## SUPPLY BANK .ORG OFFICES & DISTRIBUTION FACILITY

OAKPORT STREET  
OAKLAND, CALIFORNIA



## CONCEPTUAL STORM WATER CONTROL PLAN

### STORM WATER TREATMENT MEASURES SUMMARY [EBMUD]

DRAINAGE MANAGEMENT AREAS (DMA)	TOTAL AREA (SF)	PERVIOUS (L.S. AREA) (SF)	TOTAL IMPERVIOUS AREA (SF)	TREATMENT AREA REQUIRED	TREATMENT AREA PROVIDED	TREATMENT CONTROL MEASURES (MF)	PIPE STORAGE VOLUME CU./FT
#1	132,293	34,683	93,255	3,869 SF	4,355 SF	BIO-TREATMENT	100%
#2	26,968	1,142	24,465	983 SF	1,361 SF	BIO-TREATMENT	100%
#3	40,668	5,601	33,447	1,360 SF	1,620 SF	BIO-TREATMENT	100%
#4	91,603	5,523	82,178	3,309 SF	3,902 SF	BIO-TREATMENT	100%
#5	39,469	2,564	34,905	1,406 SF	2,000 SF	BIO-TREATMENT	100%
#6	80,421	0	76,362	3,054 SF	3,680 SF	BIO-TREATMENT	100%
#7	4,850	0	4,850	194 SF	0	MECHANICAL	100%
UT 11,682 SF							
Total	416,272	49,514	349,461	14,176 SF	16,918 SF		100%

### AREA OF SUMMARY:

TOTAL SITE AREA: 721,182 SF

AREA A: 427,575 SF

TOTAL IMPERVIOUS AREA: 349,461 SF

UN-TREATED AREA: 11,682 SF

BIO-RETENTION AREA: 16,918 SF

LANDSCAPE AREA : 49,514 SF

AREA B: 293,607 SF

TOTAL IMPERVIOUS AREA: 248,297 SF

UN-TREATED AREA: 4,580 SF

BIO-RETENTION AREA: 13,035 SF

LANDSCAPE AREA : 27,695 SF

### STORM WATER TREATMENT MEASURES SUMMARY [OFFICE BUILDING SITE]

DRAINAGE MANAGEMENT AREAS (DMA)	TOTAL AREA (SF)	PERVIOUS (L.S. AREA) (SF)	TOTAL IMPERVIOUS AREA (SF)	TREATMENT AREA REQUIRED	TREATMENT AREA PROVIDED	TREATMENT CONTROL MEASURES (MF)	PIPE STORAGE VOLUME CU./FT	REMARKS
#8	42,255	4,230	36,305	1,469 SF	1,720 SF	BIO-TREATMENT	100%	
#9	102,610	12,200	86,010	3,589 SF	4,400 SF	BIO-TREATMENT	100%	
#10	3,480	0	3,183	127 SF	150 SF	BIO-TREATMENT	100%	
#11	3,455	0	3,158	126 SF	150 SF	BIO-TREATMENT	100%	
#12	20,788	180	19,326	774 SF	1,280 SF	BIO-TREATMENT	100%	
#13	14,106	960	12,601	508 SF	545 SF	BIO-TREATMENT	100%	
#14	54,060	4,700	46,930	1,910 SF	2,128 SF	BIO-TREATMENT	100%	
#15	4,290	0	4,290	155 SF	420 SF	BIO-TREATMENT	100%	
#16	18,186	5,425	12,037	503 SF	725 SF	BIO-TREATMENT	100%	
#17	26,256	0	244,976	995 SF	1,380 SF	BIO-TREATMENT	100%	
UT 4,580 SF								
Total	289,486	27,695	248,297	10,057 SF	13,035 SF		100%	

JOB NO.: SNR17-009  
PA / PM: GP  
DRAWN BY: SY  
DATE: JAN 15, 2019

SHEET  
C6.0  
Sheet 10 of 11

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pleasanton, ca 94588  
p 925.244.9620  
waremalcomb.com



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OF WARE MALCOMB

## SUPPLYBANK.ORG OFFICES & DISTRIBUTION FACILITY



OAKPORT STREET  
OAKLAND, CALIFORNIA

STORM WATER CONTROL DETAILS	
REMARKS	

JOB NO.: SNR17-0069  
PA / PM: GP  
DRAWN BY: SY  
DATE: JAN 15, 2019


811  
Know what's below.  
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C6.1  
SHEET  
Sheet 11 of 11

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## CALCULATION FOR DMA 1

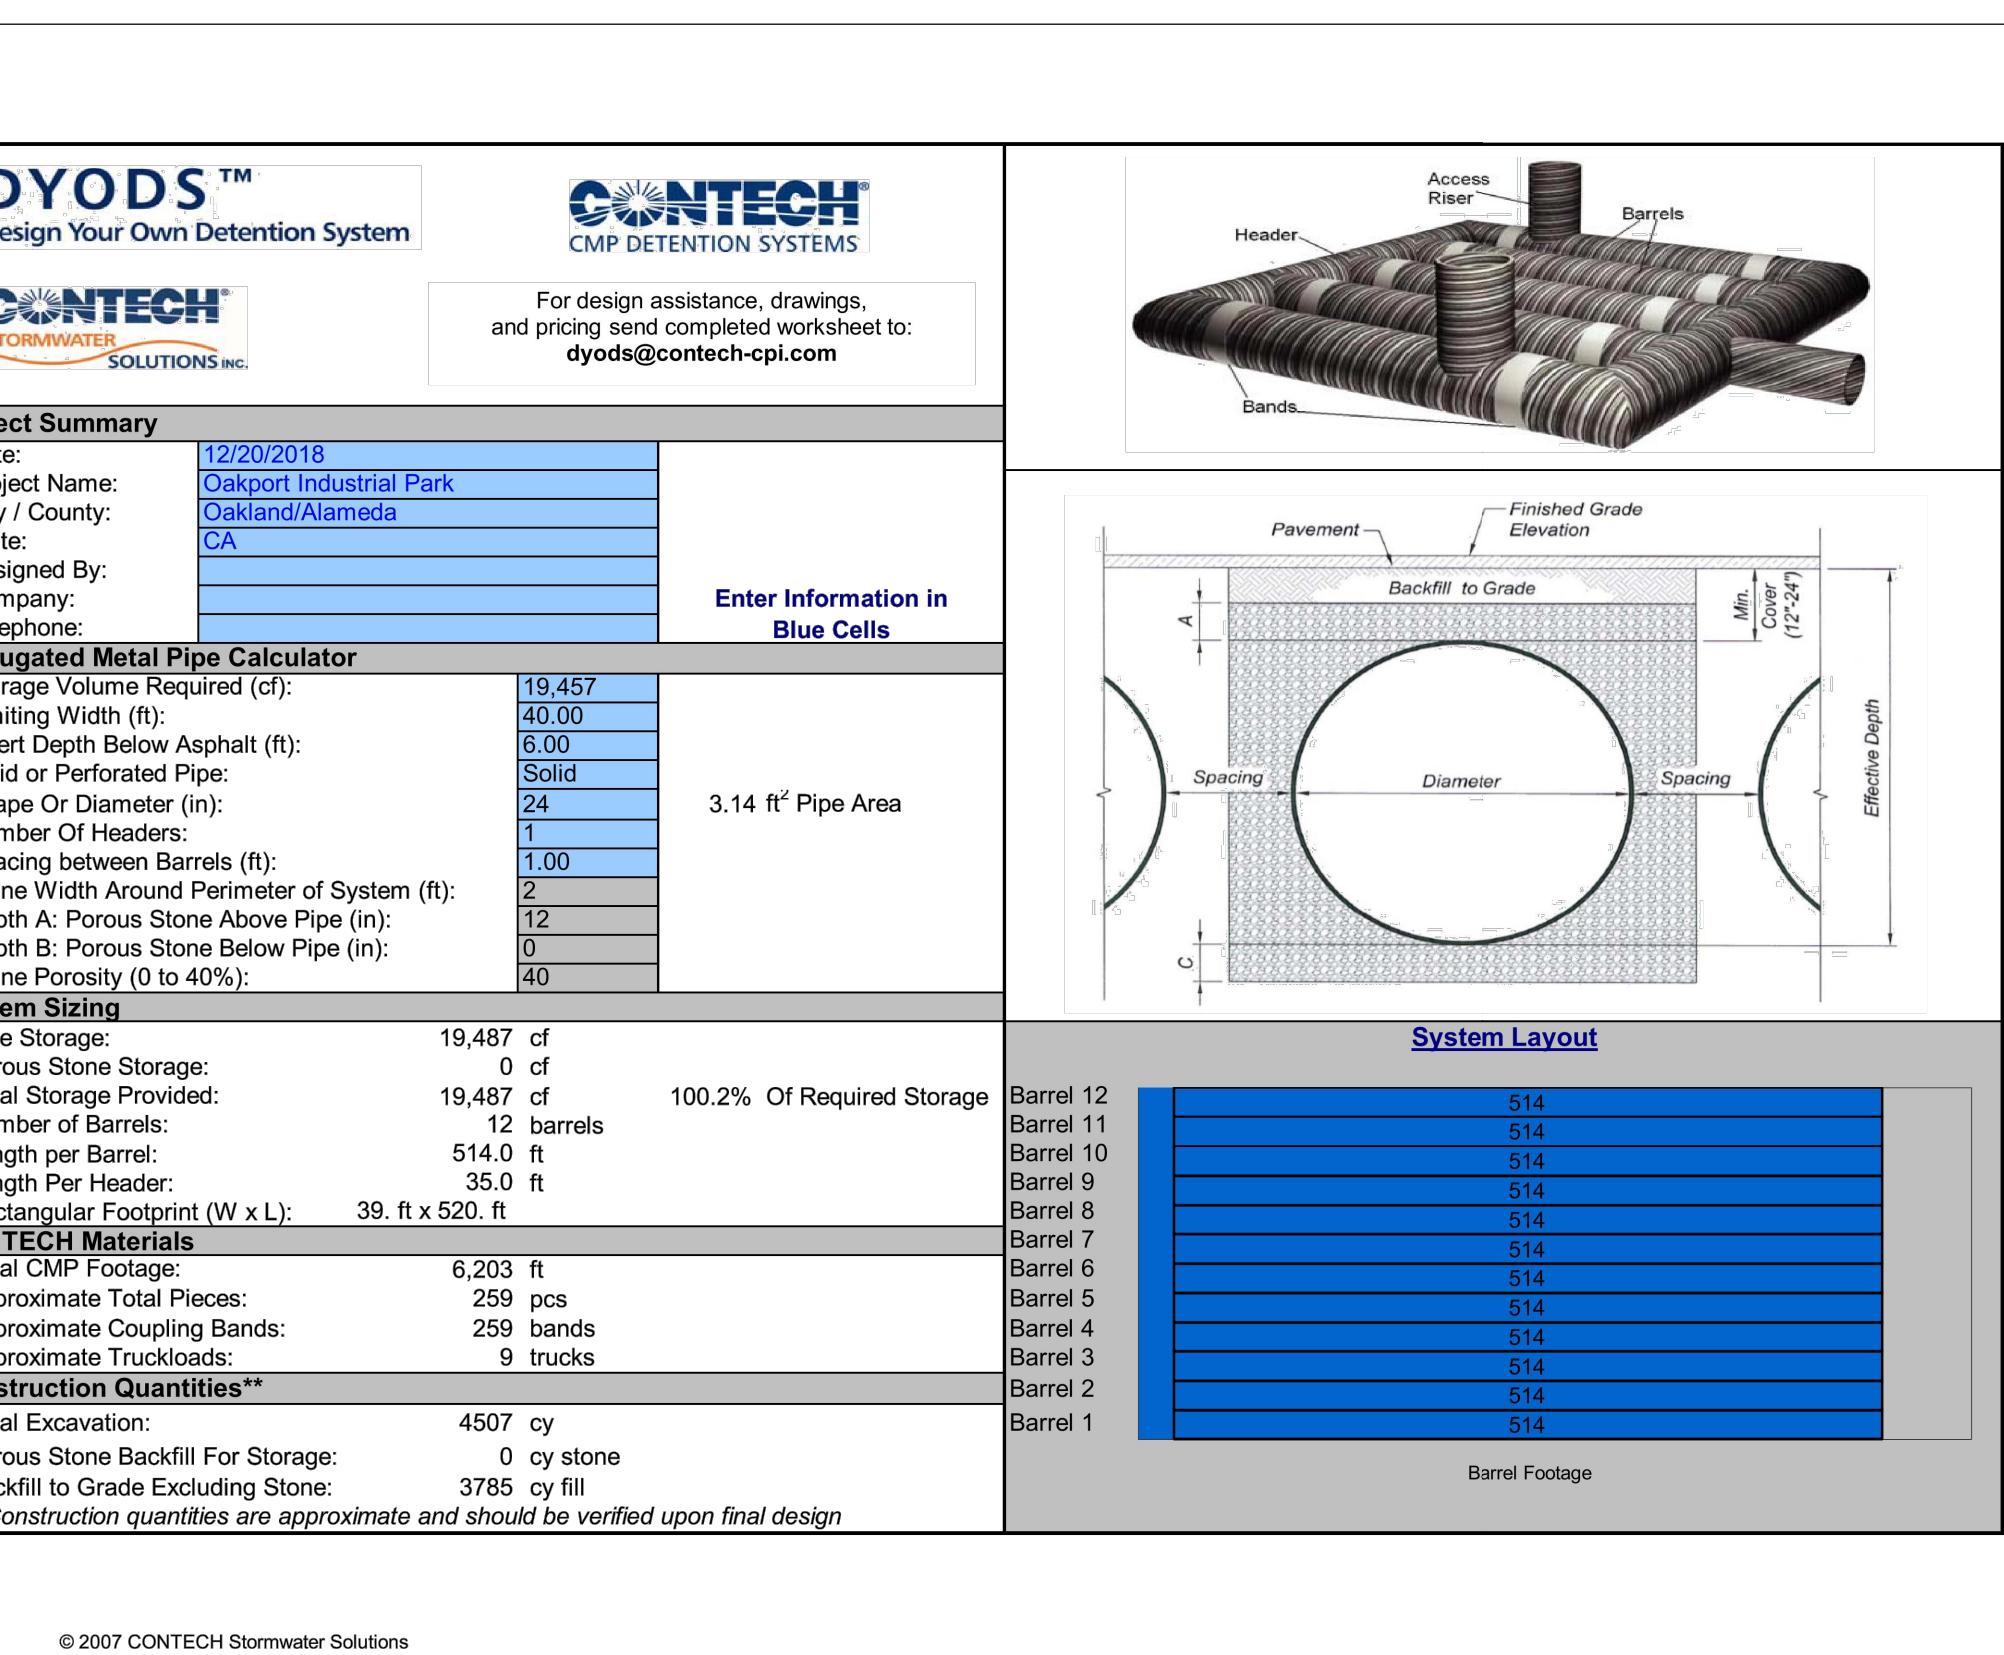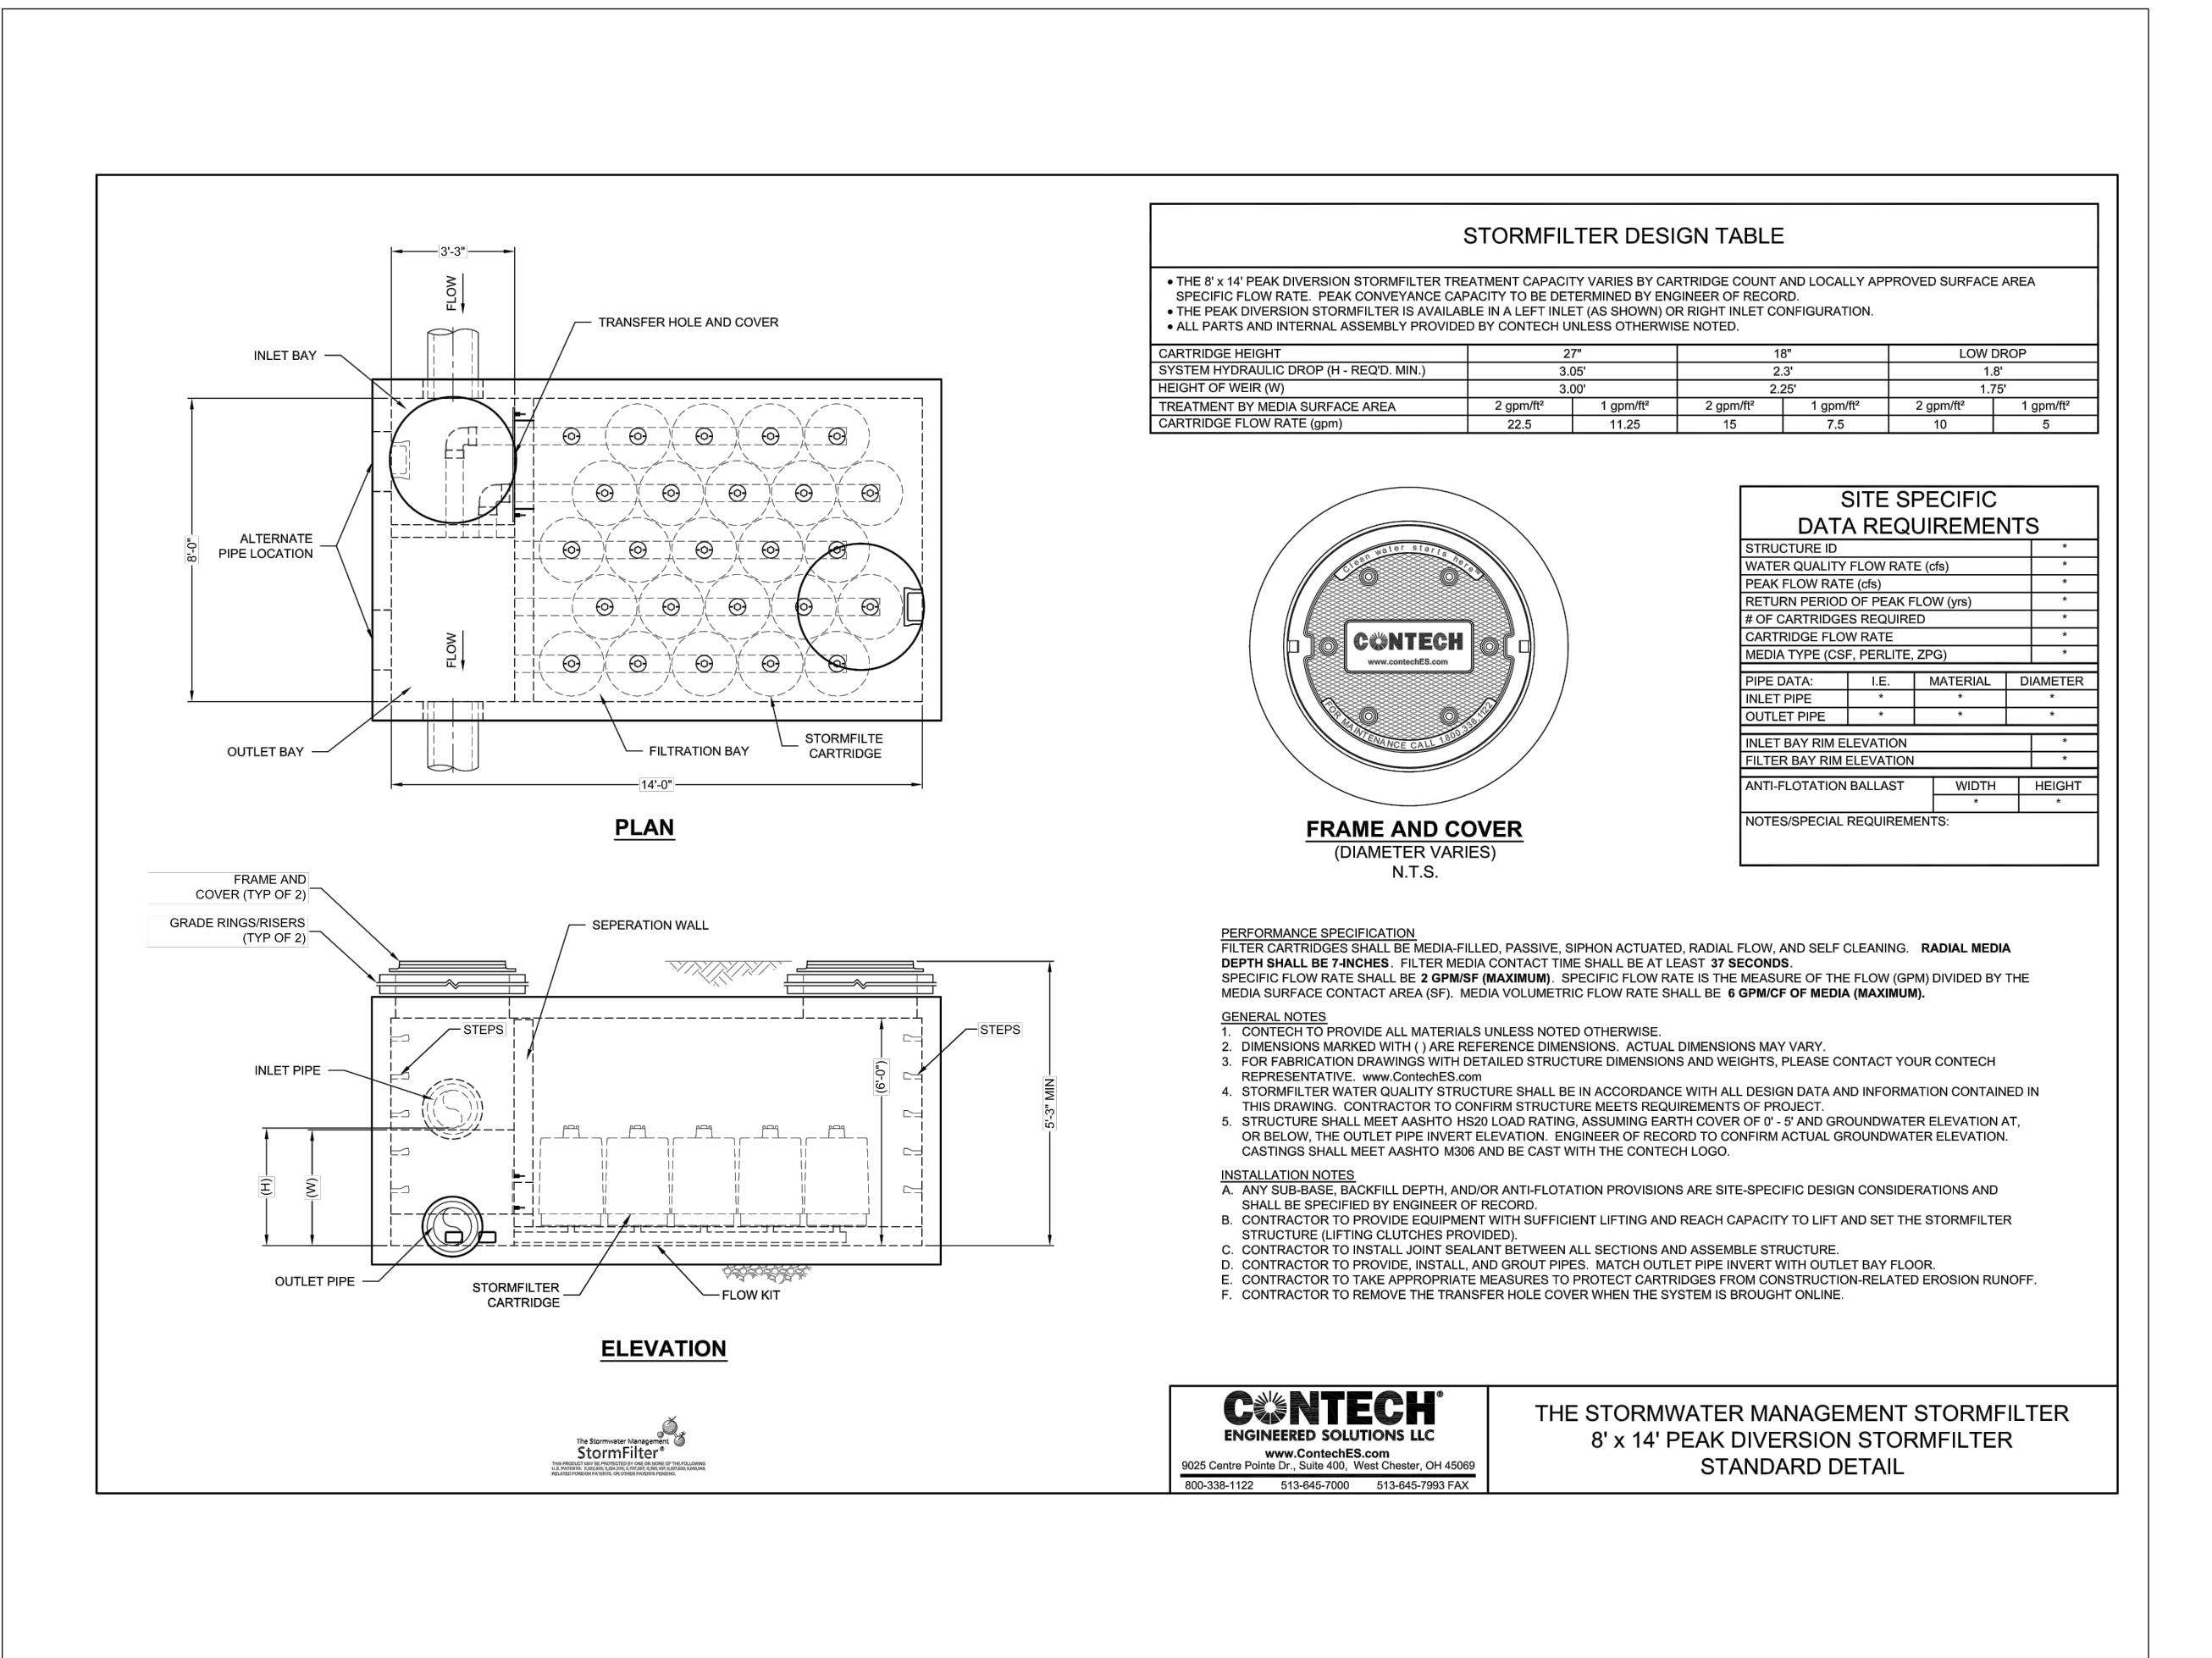

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## CALCULATION FOR DMA 2



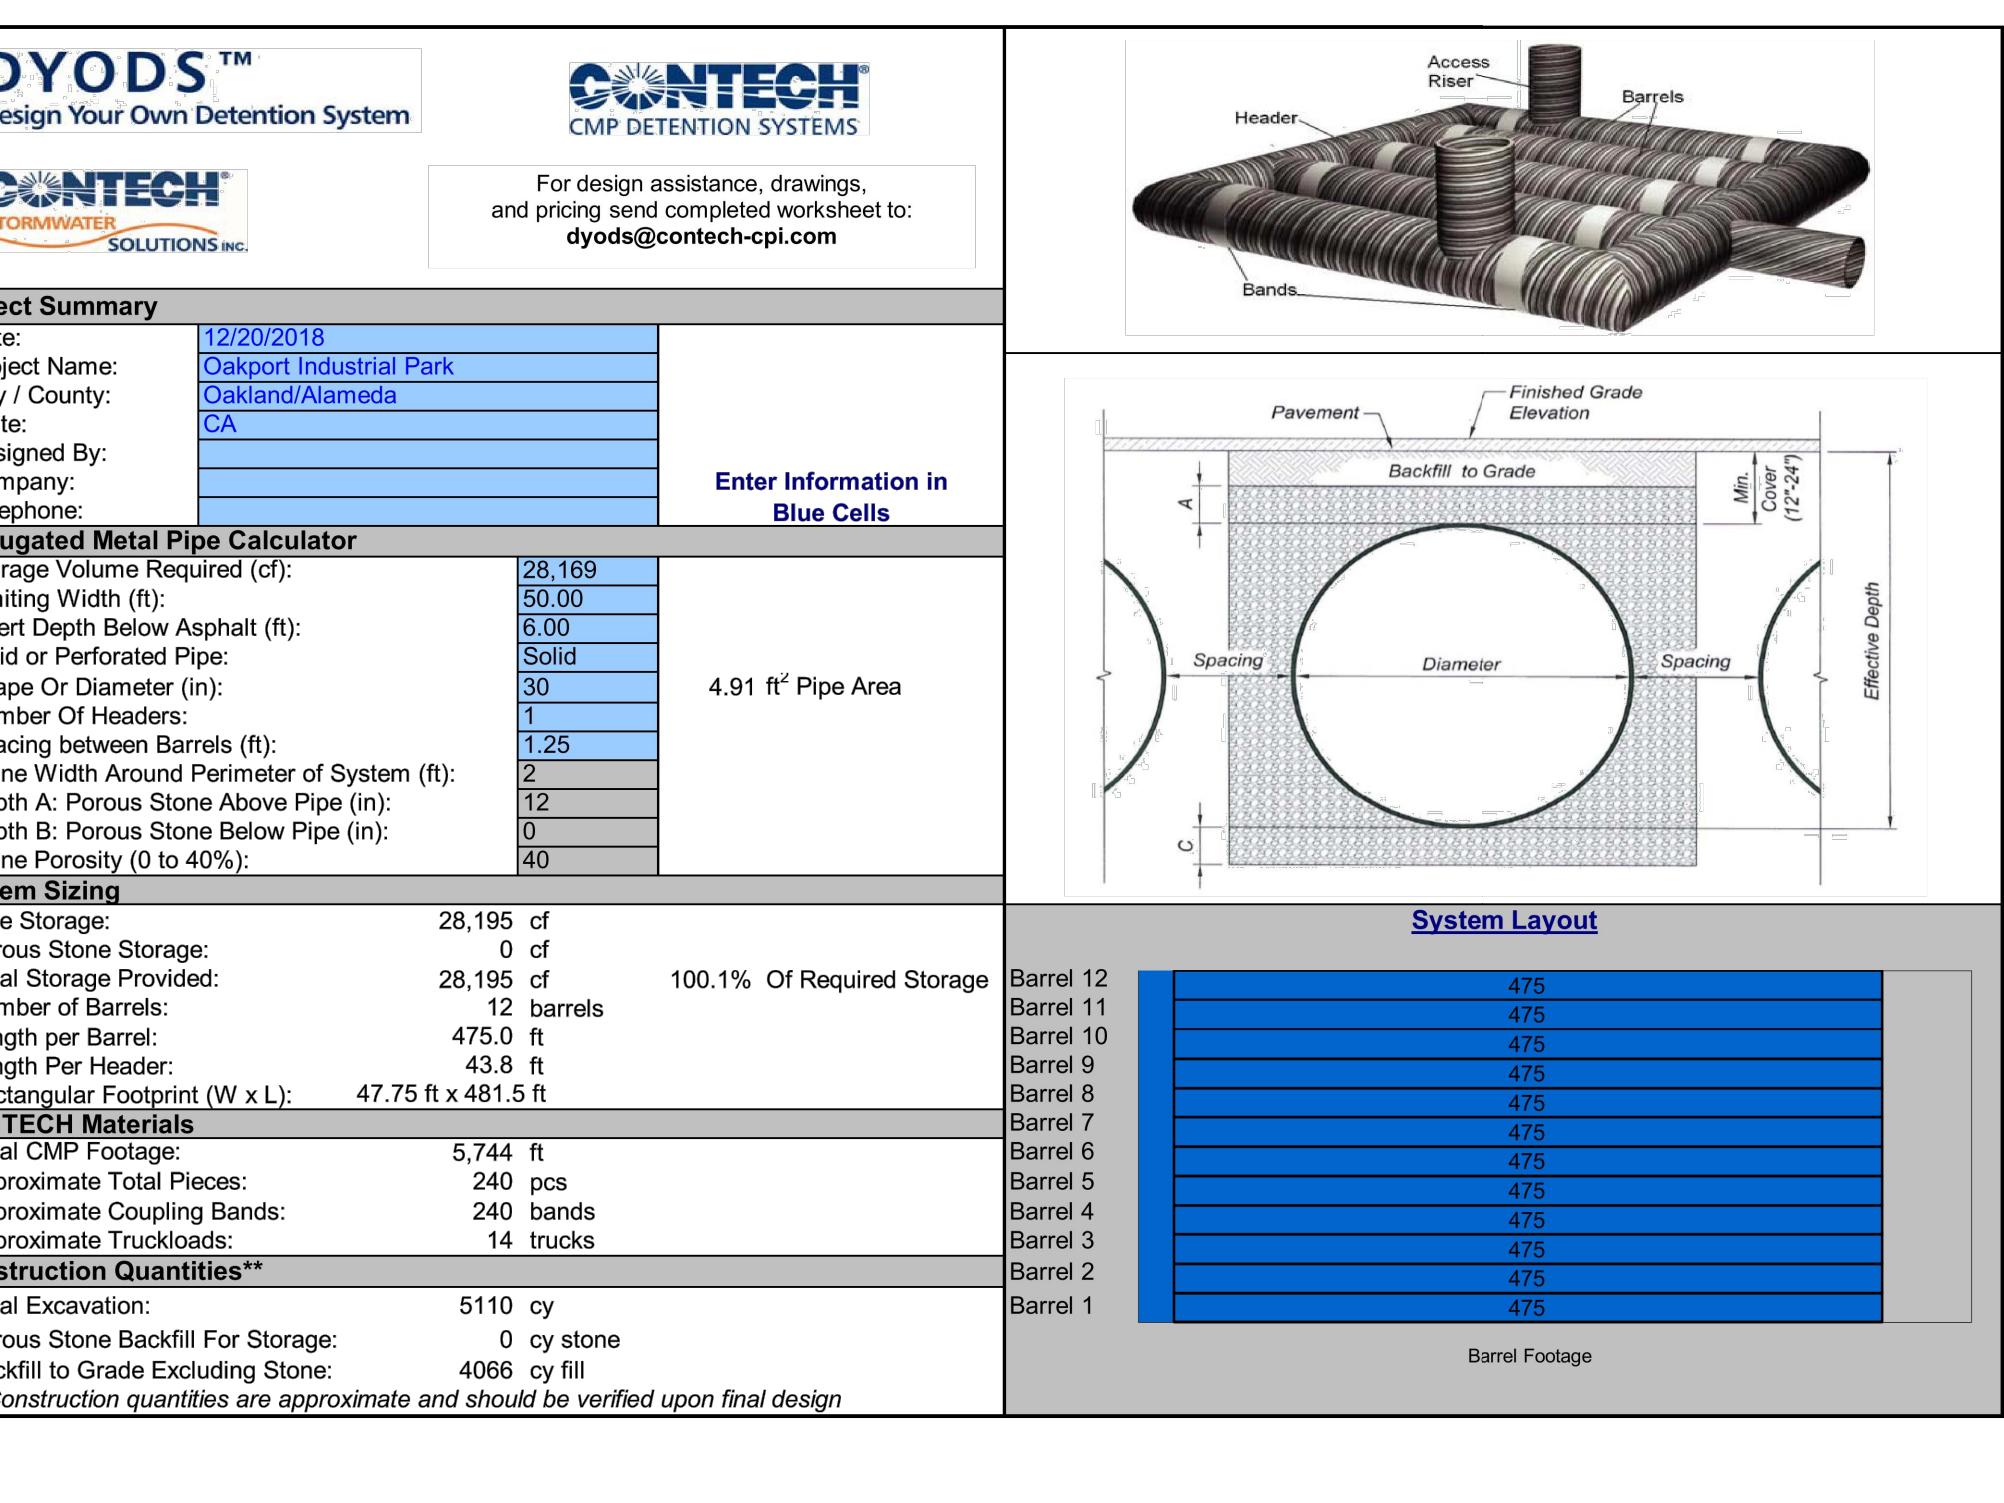

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OAKLAND, CALIFORNIA


EBMUD PRELIMINARY POST CONSTRUCTION	
NO.	DATE
REMARKS	

JOB NO.: SNR17-0069  
PA / PM: GP  
DRAWN BY: SY  
DATE: JAN 15, 2019

Sheet C7.0  
of 11



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OAKPORT STREET  
OAKLAND, CALIFORNIA

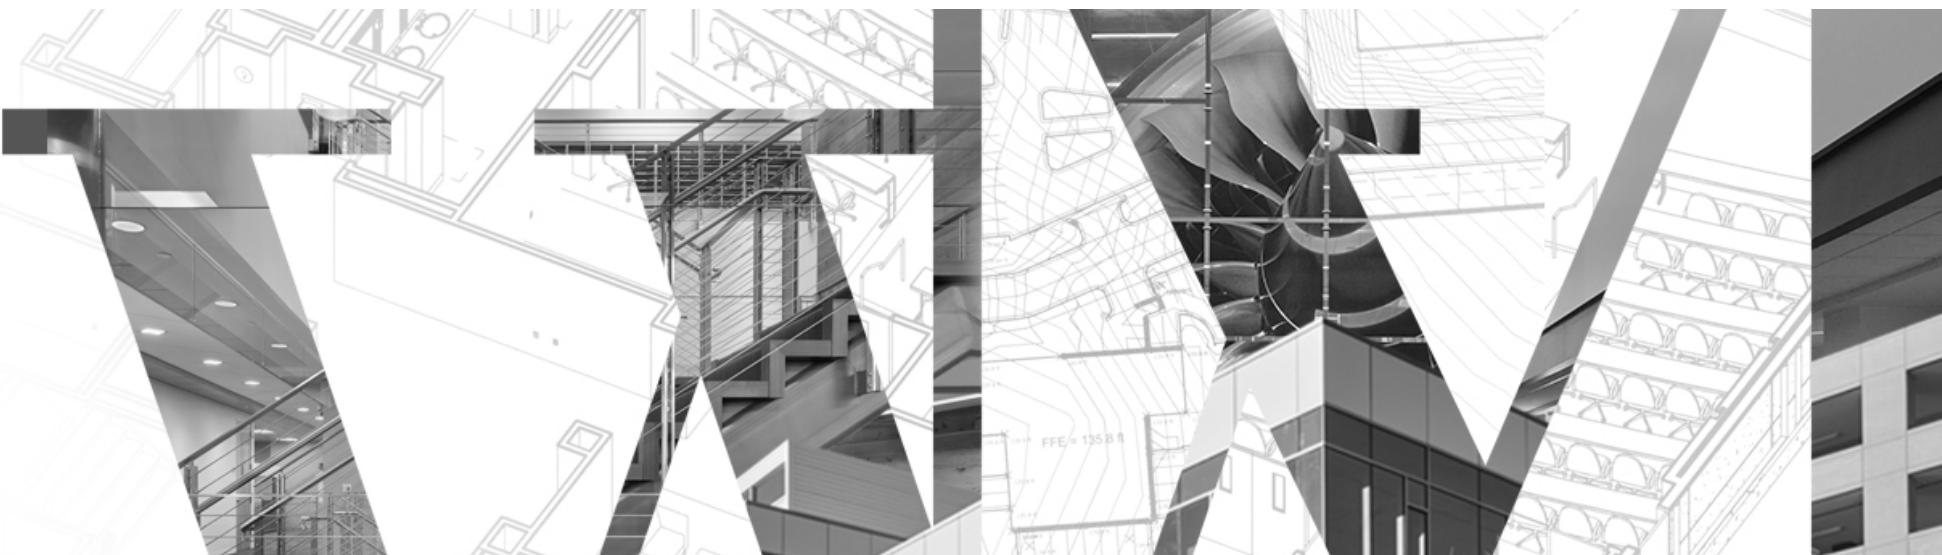SCHEMATIC DESIGN  
SNR17-0069-00  
04.03.2019


**WARE MALCOMB**  
ARCHITECTURE | PLANNING | INTERIORS  
BRANDING | CIVIL ENGINEERING







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## EXTERIOR SIGNAGE PLANNING SUBMITTAL

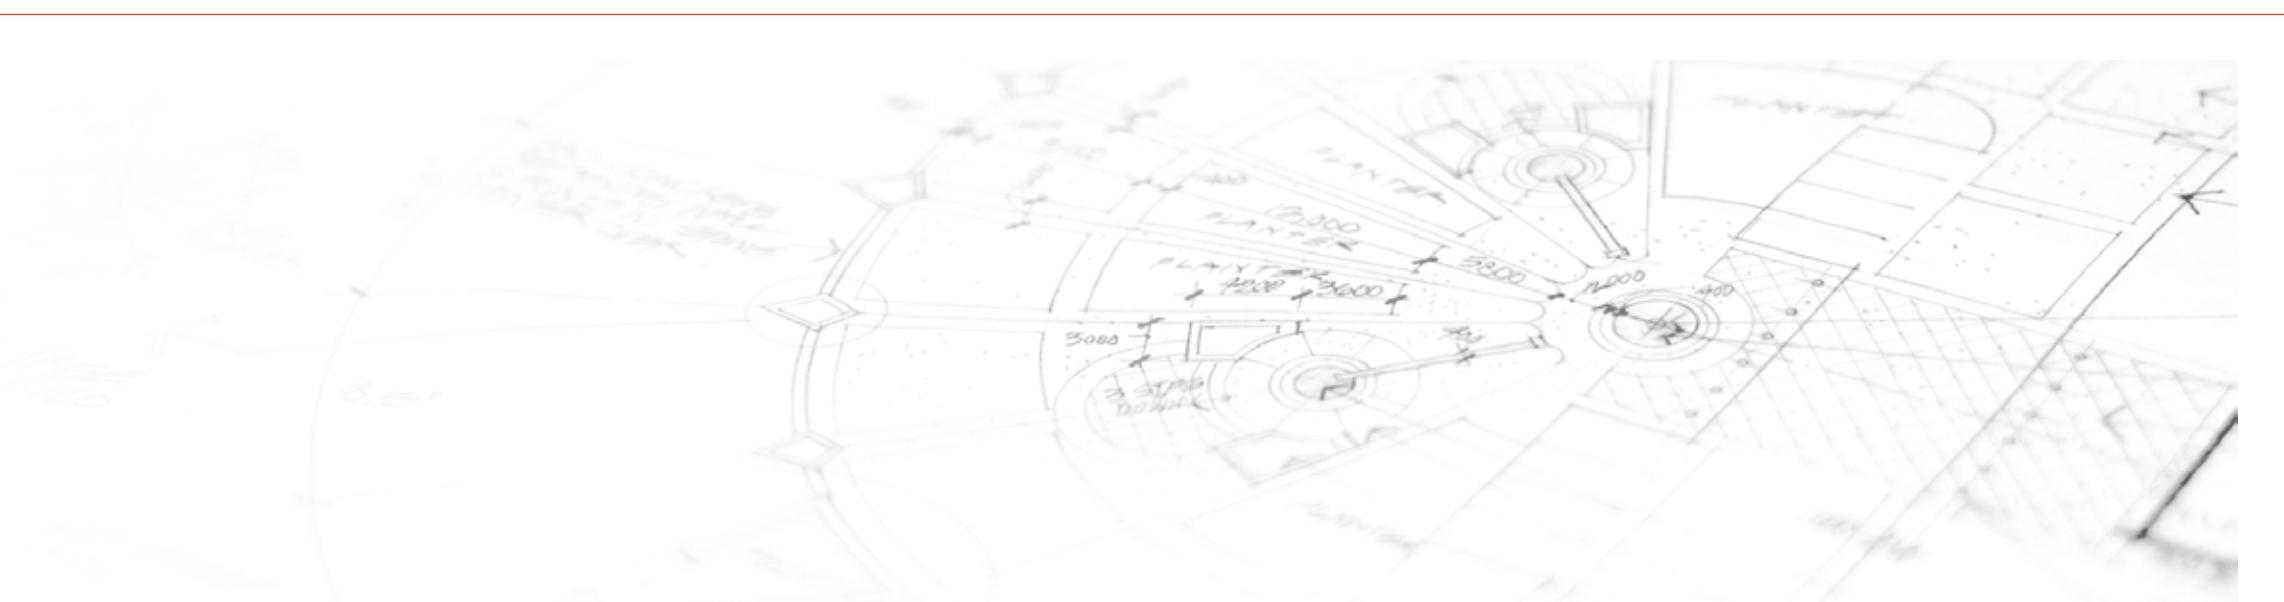OAKPORT ST  
OAKLAND, CA

SNR17-0069-00  
04.03.2019

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BRAND CONFIGURATION - SUPPLYBANK.ORG



This conceptual design is based upon a preliminary review of entitlement requirements and on unverified and possibly incomplete site and/or building information, and is intended merely to assist in exploring how the project might be developed. Signage shown is for illustrative purposes only and does not necessarily reflect municipal code compliance.



BRAND CONFIGURATION - EBMUD

BRAND IDENTITY  
SUPPLYBANK.ORG - SIGNAGE DESIGN  
OAKLAND, CA - SNR17-0069-00

WARE MALCOMB

04.03.2019

A B C D E F G H I J K L M N O P Q R S T U V W X Y Z 0 1 2 3 4 5 6 7 8 9 &  
a b c d e f g h i j k l m n o p q r s t u v w x y z 0 1 2 3 4 5 6 7 8 9 &

INTERSTATE - REGULAR

FONTS



This conceptual design is based upon a preliminary review of entitlement requirements and on unverified and possibly incomplete site and/or building information, and is intended merely to assist in exploring how the project might be developed. Signage shown is for illustrative purposes only and does not necessarily reflect municipal code compliance.

PROJECT FONT

SUPPLYBANK.ORG - SIGNAGE DESIGN  
OAKLAND, CA - SNR17-0069-00

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PAGE  
3

## PAINT




P1  
MATTHEWS  
TO MATCH  
PMS 7688c



P2  
MATTHEWS  
TO MATCH  
PMS 534C



P3  
MATTHEWS  
TO MATCH  
PMS COOL GRAY 7C

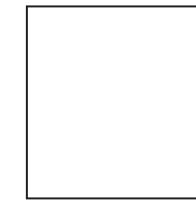

P4  
MATTHEWS  
SATIN WHITE



P5  
MATTHEWS  
TO MATCH SW 6802  
"HYPER BLUE"



P6  
MATTHEWS  
TO MATCH SW 7067  
"CITYSCAPE"



P7  
MATTHEWS  
TO MATCH SW 7676  
"PEPPERCORN"

## VINYL



V1  
TRANSLUCENT  
VINYL TO MATCH  
PMS 7688C



V2  
TRANSLUCENT  
VINYL TO MATCH  
PMS 534C



V3  
TRANSLUCENT  
VINYL TO MATCH  
PMS COOL GRAY 7C

SAMPLES TO BE PROVIDED TO WARE MALCOMB FOR REVIEW AND APPROVAL PRIOR TO APPLICATION

## Chapter 17.104 - GENERAL LIMITATIONS ON SIGNS

17.104.020 - General limitations on Signs—RU-4 and RU-5 Zones, and all Commercial and Industrial Zones.

The following limitations shall apply to the specified Signs in the RU-4 and RU-5 Zones and all Commercial and Industrial Zones, and except as otherwise provided herein, and are in addition to the limitations, if any, prescribed for Signs in the applicable individual zone regulations and development control maps:

A. Design Review. No Business, Civic, or Residential Sign shall be constructed or established, or altered in exterior appearance, unless plans for the proposal have been approved pursuant to the design review procedure in Chapter 17.136.

### B. Permitted Aggregate Sign Area.

1. In the RU-4 and RU-5 Zones and all Commercial Zones, the maximum aggregate area of display surface of all Business, Civic, and Residential Signs on any one lot shall be one (1) square foot for each one (1) foot of lot frontage in the case of an interior lot, or one-half (0.5) square feet for each one (1) foot of lot frontage in the case of a corner lot. The aggregate shall include only one (1) face of a double-faced sign. The total amount of aggregate sign area shall not exceed two hundred (200) square feet on any one property. Exceptions to the total amount of aggregate sign area normally allowed on any one property may be approved pursuant to the regulations in Subsection B.3. below and to the Small project design review procedure in Chapter 17.136. 2. In all Industrial Zones, the maximum aggregate area of display surface of all Business, Civic and Residential Signs on any one lot shall be one (1) square foot for each one (1) foot of lot frontage in the case of an interior lot, or one-half (0.5) square feet for each one (1) foot of lot frontage in the case of a corner lot. The aggregate shall include only one (1) face of a double-faced sign. The total amount of aggregate sign area shall not exceed three hundred (300) square feet on any one property. Exceptions to the total amount of aggregate sign area normally allowed on any one property may be approved pursuant to the regulations in Subsection B.3. below. 3. Exception to Aggregate Sign Area Limits. The following exceptions to the aggregate sign area limits may be approved: a. In cases in which the maximum aggregate sign area for a property is already being utilized by a portion of the existing tenant spaces in a multi-tenant building or complex, twenty (20) square feet of sign area for each tenant space in the multi-tenant building or complex without existing signage on site is allowed if approved pursuant to the Small project design review procedure in Chapter 17.136; b. Signs conforming to a Master Sign Program approved pursuant to Section 17.104.070.

C. Maximum Height. 1. Attached Signs. The maximum height of any sign that is attached to a building may not exceed the height of the building wall that it is attached to. 2. Freestanding Signs. The maximum height of any freestanding sign in the CC, M-20, M-30, M-40, CIX, IG, IO, D-CE, D-CO-2, D-CO-3, D-CO-4, D-CO-5, and D-CO-6 Zones is twenty (20) feet. The maximum height in the RU-4 and RU-5 Zones and all other Commercial and Industrial Zones is ten (10) feet.

D. Limitations on Signs within Required Minimum Yards. 1. No business, realty, or development sign shall be located within a required minimum yard.

E. Special Limitations Near Boundaries of Residential Zones, Except the RU-4 and RU-5 Zones. The following special limitations shall apply to the indicated Signs within the specified distances from any boundary of a Residential Zone, except the RU-4 and RU-5 Zones. For the purposes of this Subsection, a Sign shall be deemed to face a zone boundary if the angle between the face of its display surface and said boundary is less than ninety (90) degrees; and a sign shall be considered visible from a zone boundary if it may be seen from any point located along such boundary within the following indicated distances from the sign and at a height equal to or less than that of the sign. 1. Within twenty-five (25) feet from any boundary of a Residential Zone, except the RU-4 and RU-5 Zones, no business sign shall face said boundary if it is visible therefrom.

F. Development Signs. In the RU-4 and RU-5 Zones and all Commercial and Industrial Zones, the maximum aggregate area of display surface of all Development Signs on any one lot shall be either seventy-five (75) square feet or one (1) square foot for each two (2) feet of street line abutting the lot, whichever is greater. However, a greater area of display surface may be permitted upon the granting of a conditional use permit pursuant to the conditional use permit procedure in Chapter 17.134.

G. Realty Signs. In the RU-4 and RU-5 Zones and all Commercial and Industrial Zones, the maximum aggregate area of display surface of all Realty Signs on any one lot shall be one (1) square foot for each two (2) feet of street line abutting the lot; provided that such area shall not exceed twenty-five (25) square feet along any consecutive fifty (50) feet of street line; and farther provided that a sign with a display surface of twelve (12) square feet or less shall be permitted for each lot, or for each building or other rentable unit thereon.

H. Signs Within One thousand (1,000) Feet of Rapid Transit Routes. Signs within one thousand (1,000) feet of the centerline of rapid transit routes shall be subject to the applicable limitations set forth in Sections 17.104.040 and 17.114.150.

I. Permitted Projection Over Sidewalk. An awning, canopy, marquee, or single sign that is attached perpendicularly to the face of a building may project up to two-thirds (66.7%) of the distance from the lot line to the curb, but can not extend more than seven (7) feet from the face of building or closer than two (2) feet to the curb. Any awning, canopy, marquee, or single sign that is attached perpendicularly to the face of a building shall provide eight (8) feet minimum clearance above a sidewalk for framed or rigid portions, and seven (7) feet minimum clearance for any unframed valance.

J. Temporary Business Signs. 1. Size Allowed. Temporary signs are allowed in addition to permanent signs. The size of the temporary signs may not exceed the allowed square footage for permanent signs. 2. Allowed Time Limits. a. Grand Opening Signs. Temporary signs for the purpose of grand openings of a new business can be in place for a maximum of thirty (30) days. The installation date of the sign shall be placed on the sign to verify compliance with this regulation. b. Special Event Signs. Temporary signs for the purpose of special events may be placed on site a maximum of four (4) times per calendar year and a maximum of five (5) consecutive days per event. 3. Placement of Signs. a. Signs are allowed on private property only. Signs shall not be placed in public rights-of-way or at off-site locations. b. Signs must be affixed to a permanent structure. 4. Temporary Signs shall not be illuminated. 5. Durable Materials Required. Signs shall be constructed of durable, rigid material suitable to the location and purpose. Only interior window Signs may be made of nonrigid (e.g. paper) material. 6. Removal of Signs. Temporary Signs and their components shall be promptly removed at the expiration of the time limits set forth above.

K. Window Signs. Window signs shall not take up more than twenty-five percent (25%) of any one window. Window signs shall count against the total allowable aggregate sign area for the property as measured in Subsection 17.104.020.B. Interior signs which are located eighteen (18) inches or more from behind the window face shall be exempt from these regulations.

L. Clear Sight Restrictions. A triangular area measuring fifteen (15) feet from the intersection along each street line shall be kept free of all freestanding signs. A triangular area measuring ten (10) feet from the intersection of a driveway and a street line shall be kept free of all freestanding signs.


(Ord. No. 13357, § 3(Exh. A), 2-16-2016; Ord. No. 13302, § 5(Exh. C), 4-21-2015; Ord. No. 13251, § 5(Exh. A), 7-29-2014; Ord. No. 13172, § 3(Exh. A), 7-2-2013; Ord. No. 13168, § 5(Exh. A-2), 6-18-2013; Ord. No. 13112, § 4(Exh. A), 4-30-2012; Ord. No. 13090, § 4(Exh. A), 10-4-2011; Ord. No. 13064, § 2(Exh. A), 3-15-2011; Ord. No. 12999, § 4(Exh. A), 3-16-2010; Ord. 12872 § 4 (part), 2008; Ord. 12776 § 3, Exh. A (part), 2006; Ord. 12606 Att. A (part), 2004; prior planning code § 7041)


Editor's note— Ord. No. 13090, § 4(Exh. A), adopted October 4, 2011, changed the title of Section 17.104.020 from "General limitations on signs—Commercial and industrial zones" to "General limitations on signs—Commercial and industrial zones and the RU-4 and RU-5 zones." The historical notation has been preserved for reference purposes.

## LEGEND


TYPE	NAME	QTY
1	PRIMARY BUILDING ID SIGN	2
2	TENANT ID SIGN	1
3	MONUMENT SIGN	1

## KEY

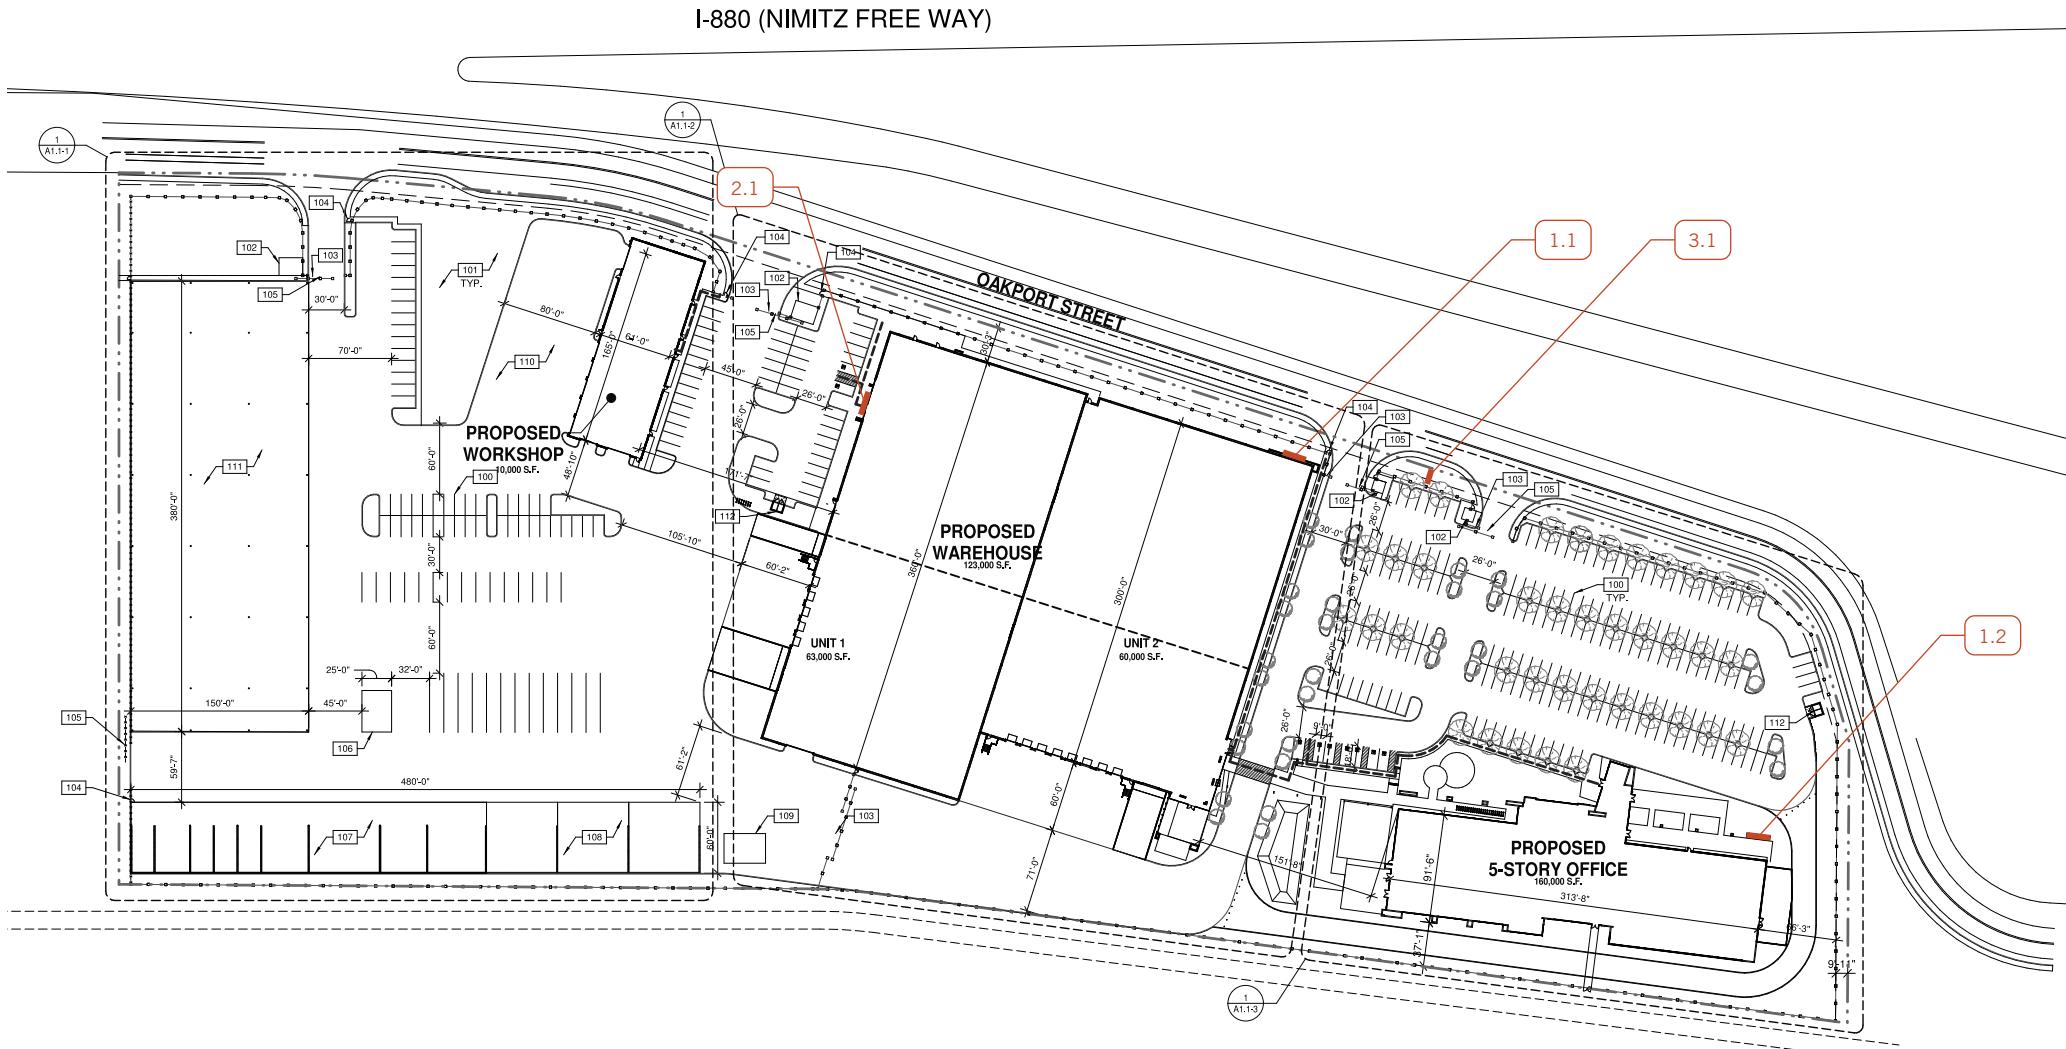

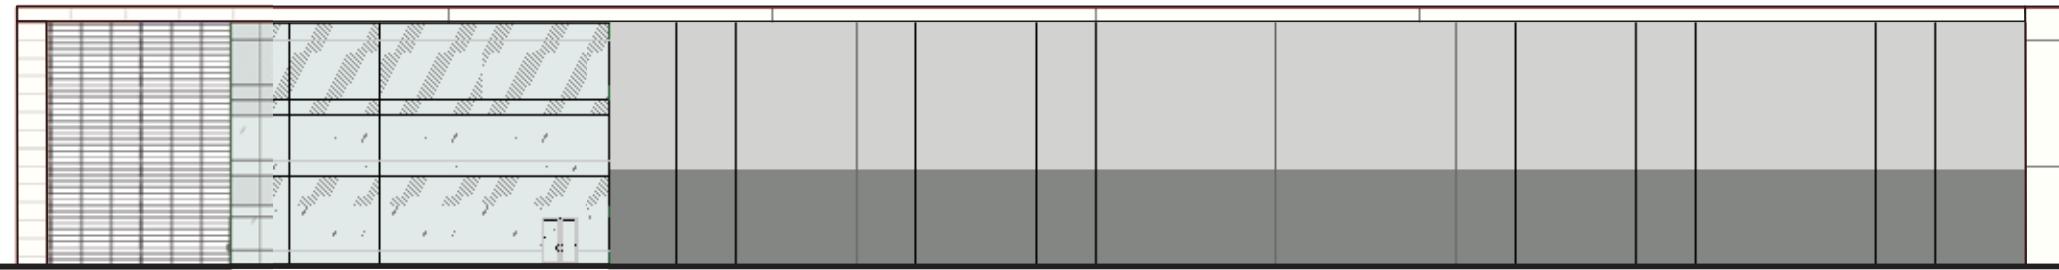


**WEST EXTERIOR ELEVATION - BUILDING 2**  
SCALE: 1/32"=1'-0"

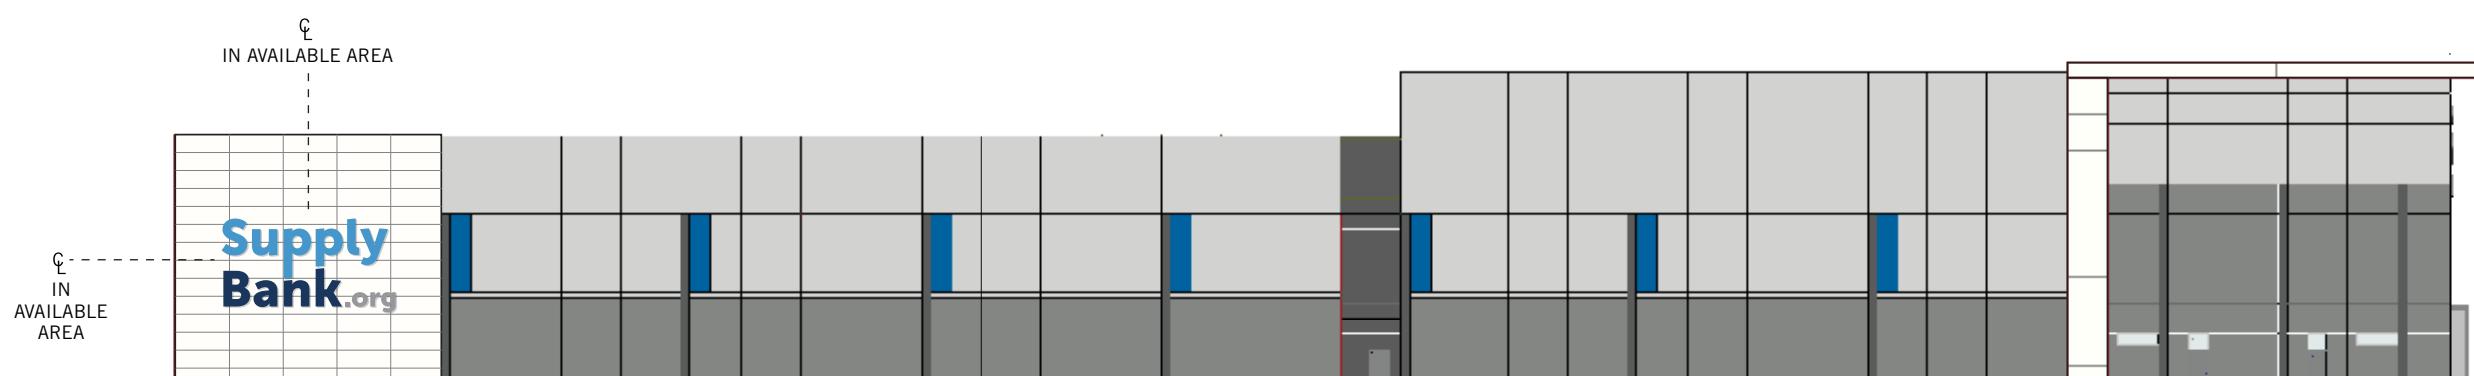

SIGN LOCATION 1.1  
SQUARE FOOTAGE: 457

**NORTH EXTERIOR ELEVATION - BUILDING 2**  
SCALE: 1/32"=1'-0"

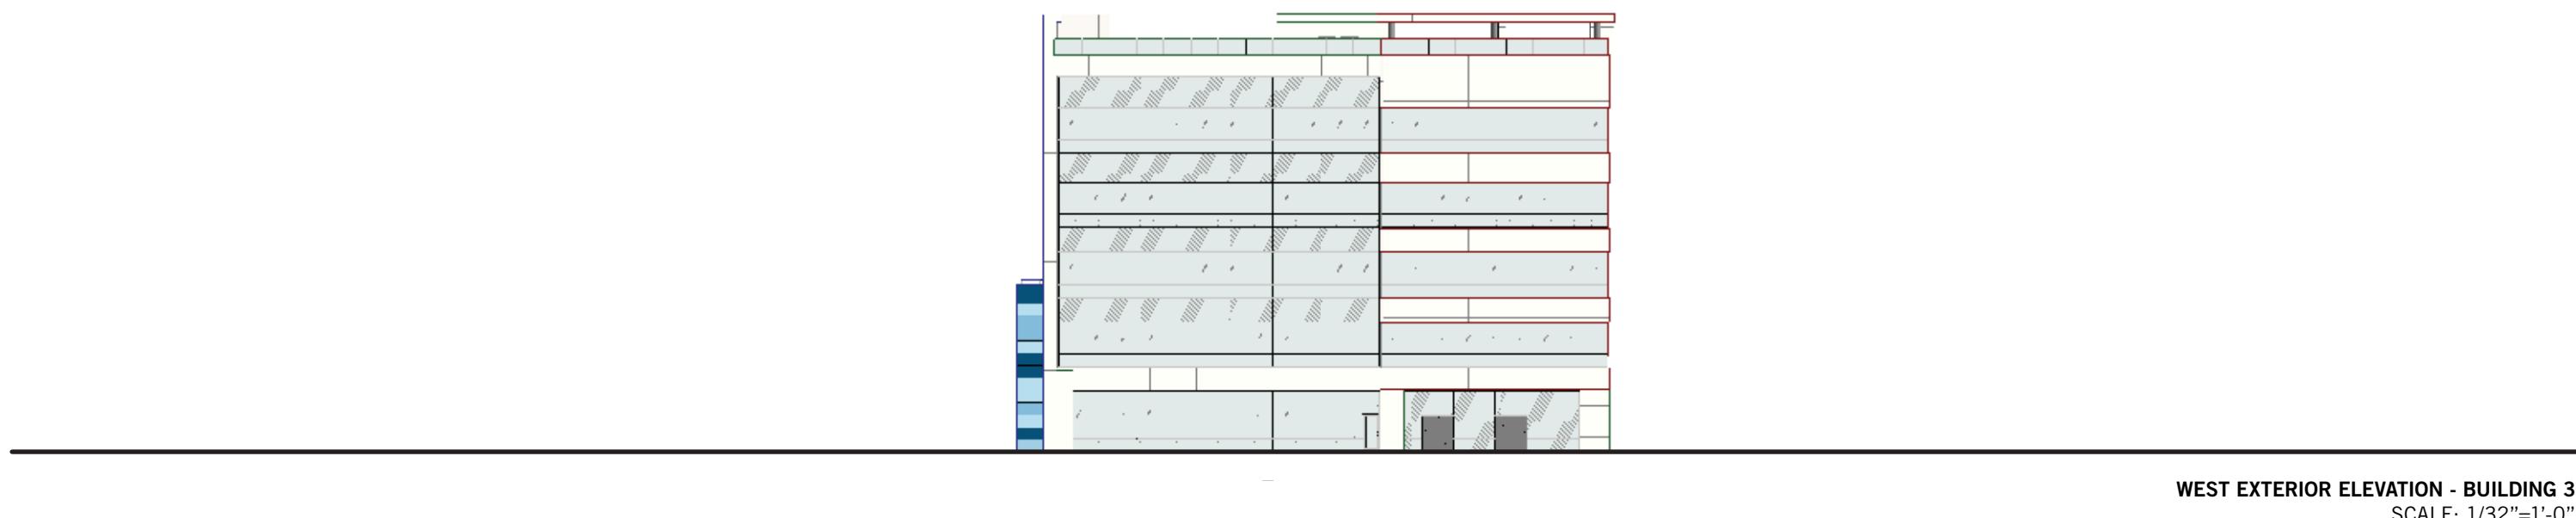



## COLORS

- P1 MATTHEWS TO MATCH PMS 7688C
- P2 MATTHEWS TO MATCH PMS 534C
- P3 MATTHEWS TO MATCH PMS COOL GRAY 7C
- V1 TRANSLUCENT TO MATCH PMS 7688C
- V2 TRANSLUCENT TO MATCH PMS 534C
- V3 TRANSLUCENT TO MATCH PMS COOL GRAY 7C

## KEY NOTES


**1** FABRICATED ALUMINUM, INTERNALLY LED ILLUMINATED FACE-LIT WITH 6500K SLOAN LED'S, CHANNEL LOGO WITH 1/4" PROUD PUSH-THRU SIGN WHITE ACRYLIC FACE WITH APPLIED TRANSLUCENT VINYL.

**2** STUDS & 3/4" SPACERS, PAINTED TO MATCH BUILDING FACE.

## ADDITIONAL NOTES

- SATIN CLEAR COAT TO BE APPLIED TO ALL PAINTED PORTIONS

- 120V POWER AND 20 AMP DEDICATED CIRCUIT TO BE PROVIDED AT SIGN LOCATION

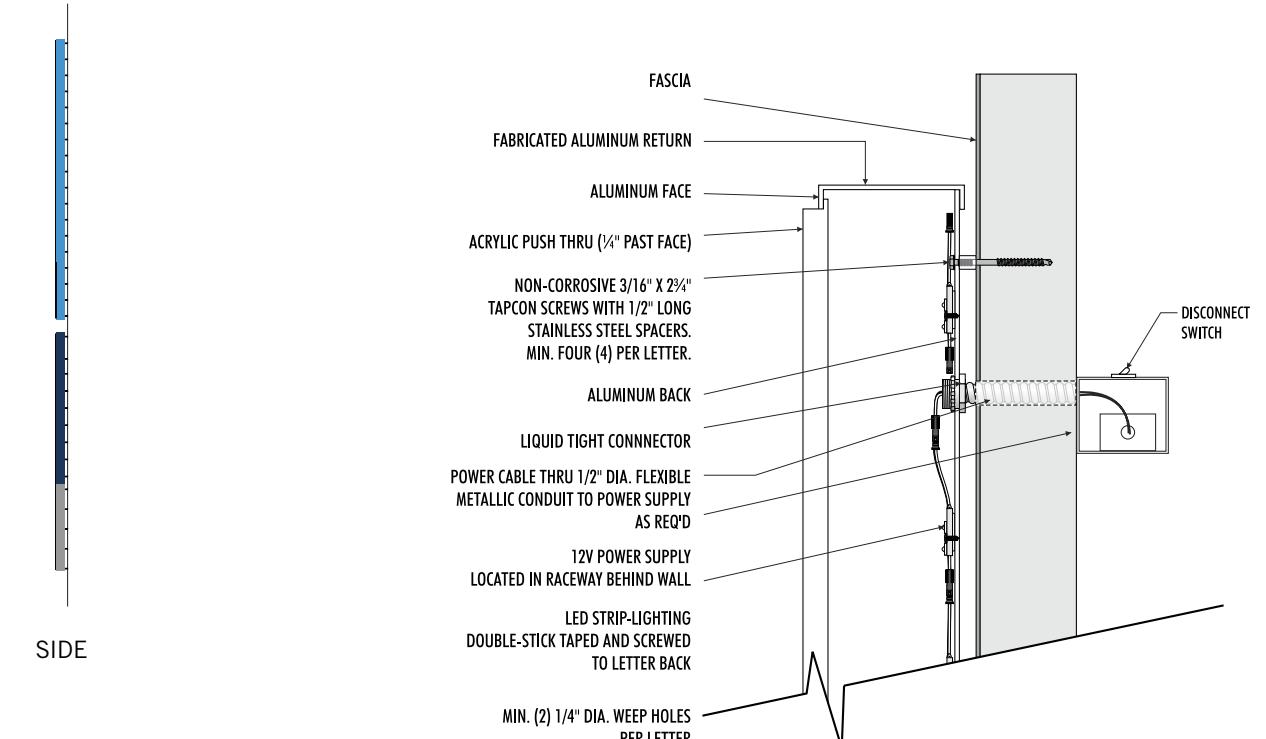

NOTE: WATERPROOFING AT ALL WALL PENETRATIONS TO BE SEALED WITH 3M 730 HYBRID CLEAR SEALANT

DETAIL VIEWS  
SCALE: 3/16" = 1'-0"

ILLUMINATED CHANNEL LOGO WITH PUSH-THRU FACE  
NOT TO SCALE

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## COLORS


- P1** MATTHEWS TO MATCH PMS 7688C
- P2** MATTHEWS TO MATCH PMS 534C
- P3** MATTHEWS TO MATCH PMS COOL GRAY 7C
- V1** TRANSLUCENT TO MATCH PMS 7688C
- V2** TRANSLUCENT TO MATCH PMS 534C
- V3** TRANSLUCENT TO MATCH PMS COOL GRAY 7C

## KEY NOTES

- 1** FABRICATED ALUMINUM, INTERNALLY LED ILLUMINATED FACE-LIT WITH 6500K SLOAN LED'S, CHANNEL LOGO WITH 1/4" PROUD PUSH-THRU SIGN WHITE ACRYLIC FACE WITH APPLIED TRANSLUCENT VINYL.
- 2** STUDS & 3/4" SPACERS, PAINTED TO MATCH BUILDING FACE.

## ADDITIONAL NOTES



- SATIN CLEAR COAT TO BE APPLIED TO ALL PAINTED PORTIONS
- 120V POWER AND 20 AMP DEDICATED CIRCUIT TO BE PROVIDED AT SIGN LOCATION

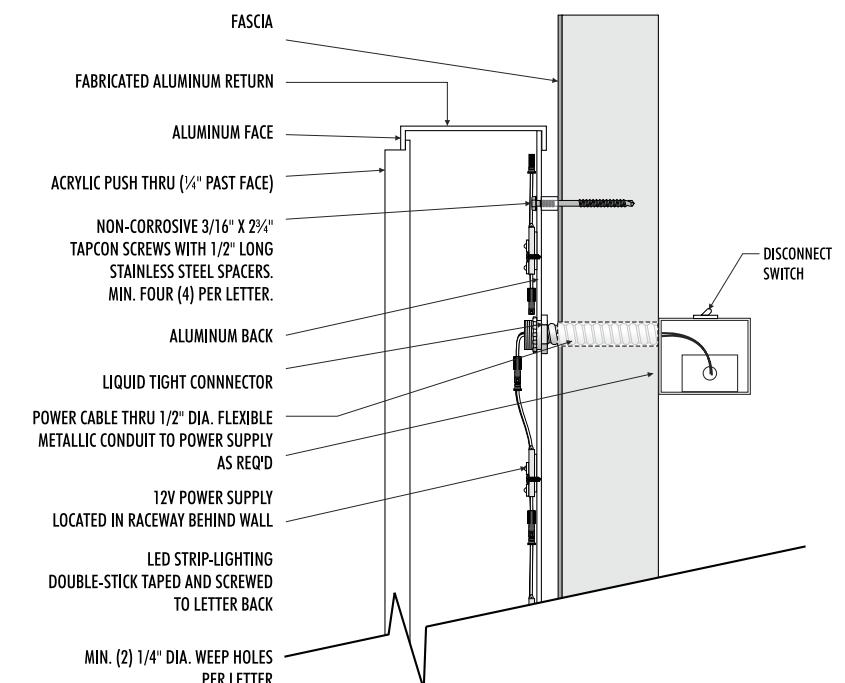

NOTE: WATERPROOFING AT ALL WALL PENETRATIONS TO BE SEALED WITH 3M 730 HYBRID CLEAR SEALANT

DETAIL VIEWS  
SCALE: 3/8" = 1'-0"

ILLUMINATED CHANNEL LOGO WITH PUSH-THRU FACE  
NOT TO SCALE

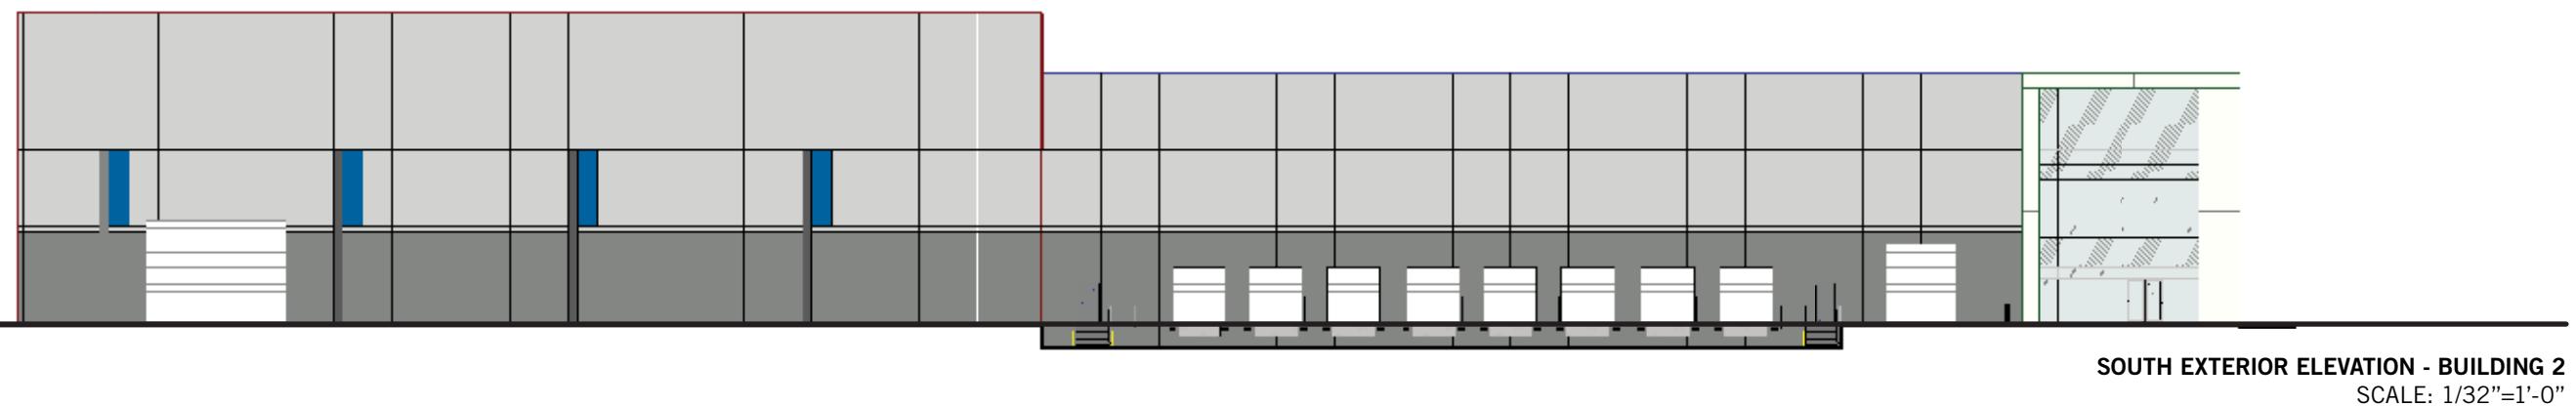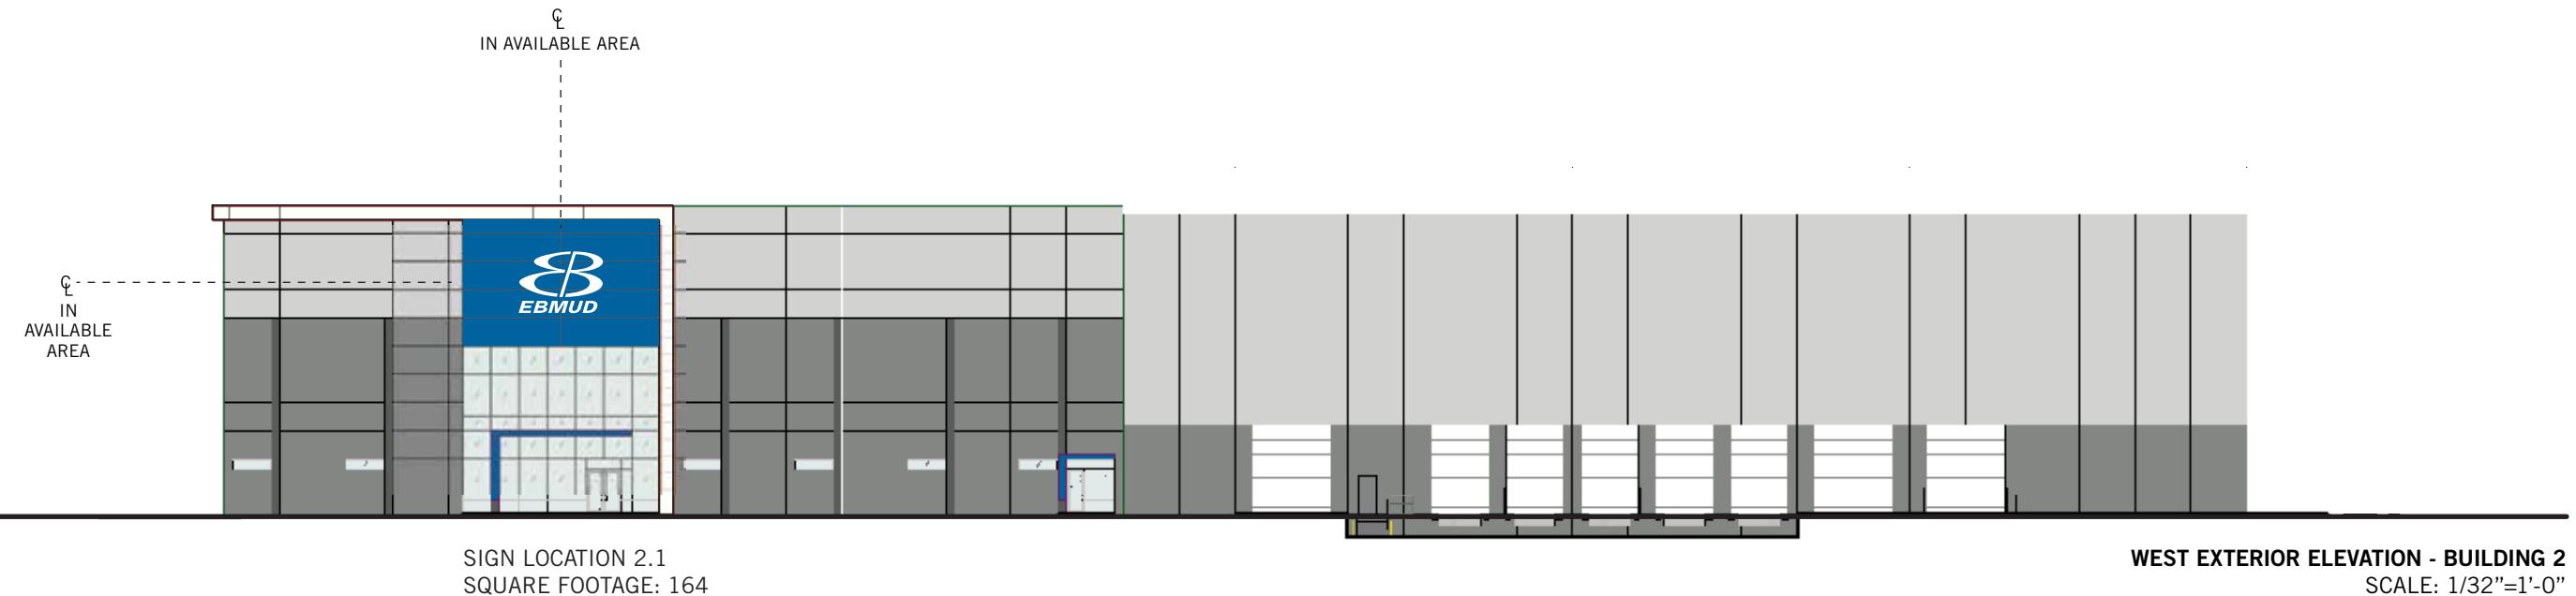

**COLORS**

P4 MATTHEWS SATIN WHITE

**KEY NOTES**

- 1** FABRICATED ALUMINUM, INTERNALLY LED ILLUMINATED FACE-LIT WITH 6500K SLOAN LED'S, CHANNEL LOGO WITH 1/4" PROUD PUSH-THRU SIGN WHITE ACRYLIC FACE WITH APPLIED TRANSLUCENT VINYL.
- 2** STUDS & 3/4" SPACERS, PAINTED TO MATCH BUILDING FACE.

**ADDITIONAL NOTES**

- SATIN CLEAR COAT TO BE APPLIED TO ALL PAINTED PORTIONS
- 120V POWER AND 20 AMP DEDICATED CIRCUIT TO BE PROVIDED AT SIGN LOCATION

NOTE: WATERPROOFING AT ALL WALL PENETRATIONS TO BE SEALED WITH 3M 730 HYBRID CLEAR SEALANT

**DETAIL VIEWS**  
SCALE: 3/16" = 1'-0"

**ILLUMINATED CHANNEL LOGO WITH PUSH-THRU FACE**  
NOT TO SCALE

**Supply  
Bank.org**


This conceptual design is based upon a preliminary review of entitlement requirements and on unverified and possibly incomplete site and/or building information, and is intended merely to assist in exploring how the project might be developed. Signage shown is for illustrative purposes only and does not necessarily reflect municipal code compliance.

SIGN TYPE 2 - TENANT ID SIGN

SUPPLYBANK.ORG - SIGNAGE DESIGN  
OAKLAND, CA - SNR17-0069-00

**WARE MALCOMB**

04.03.2019

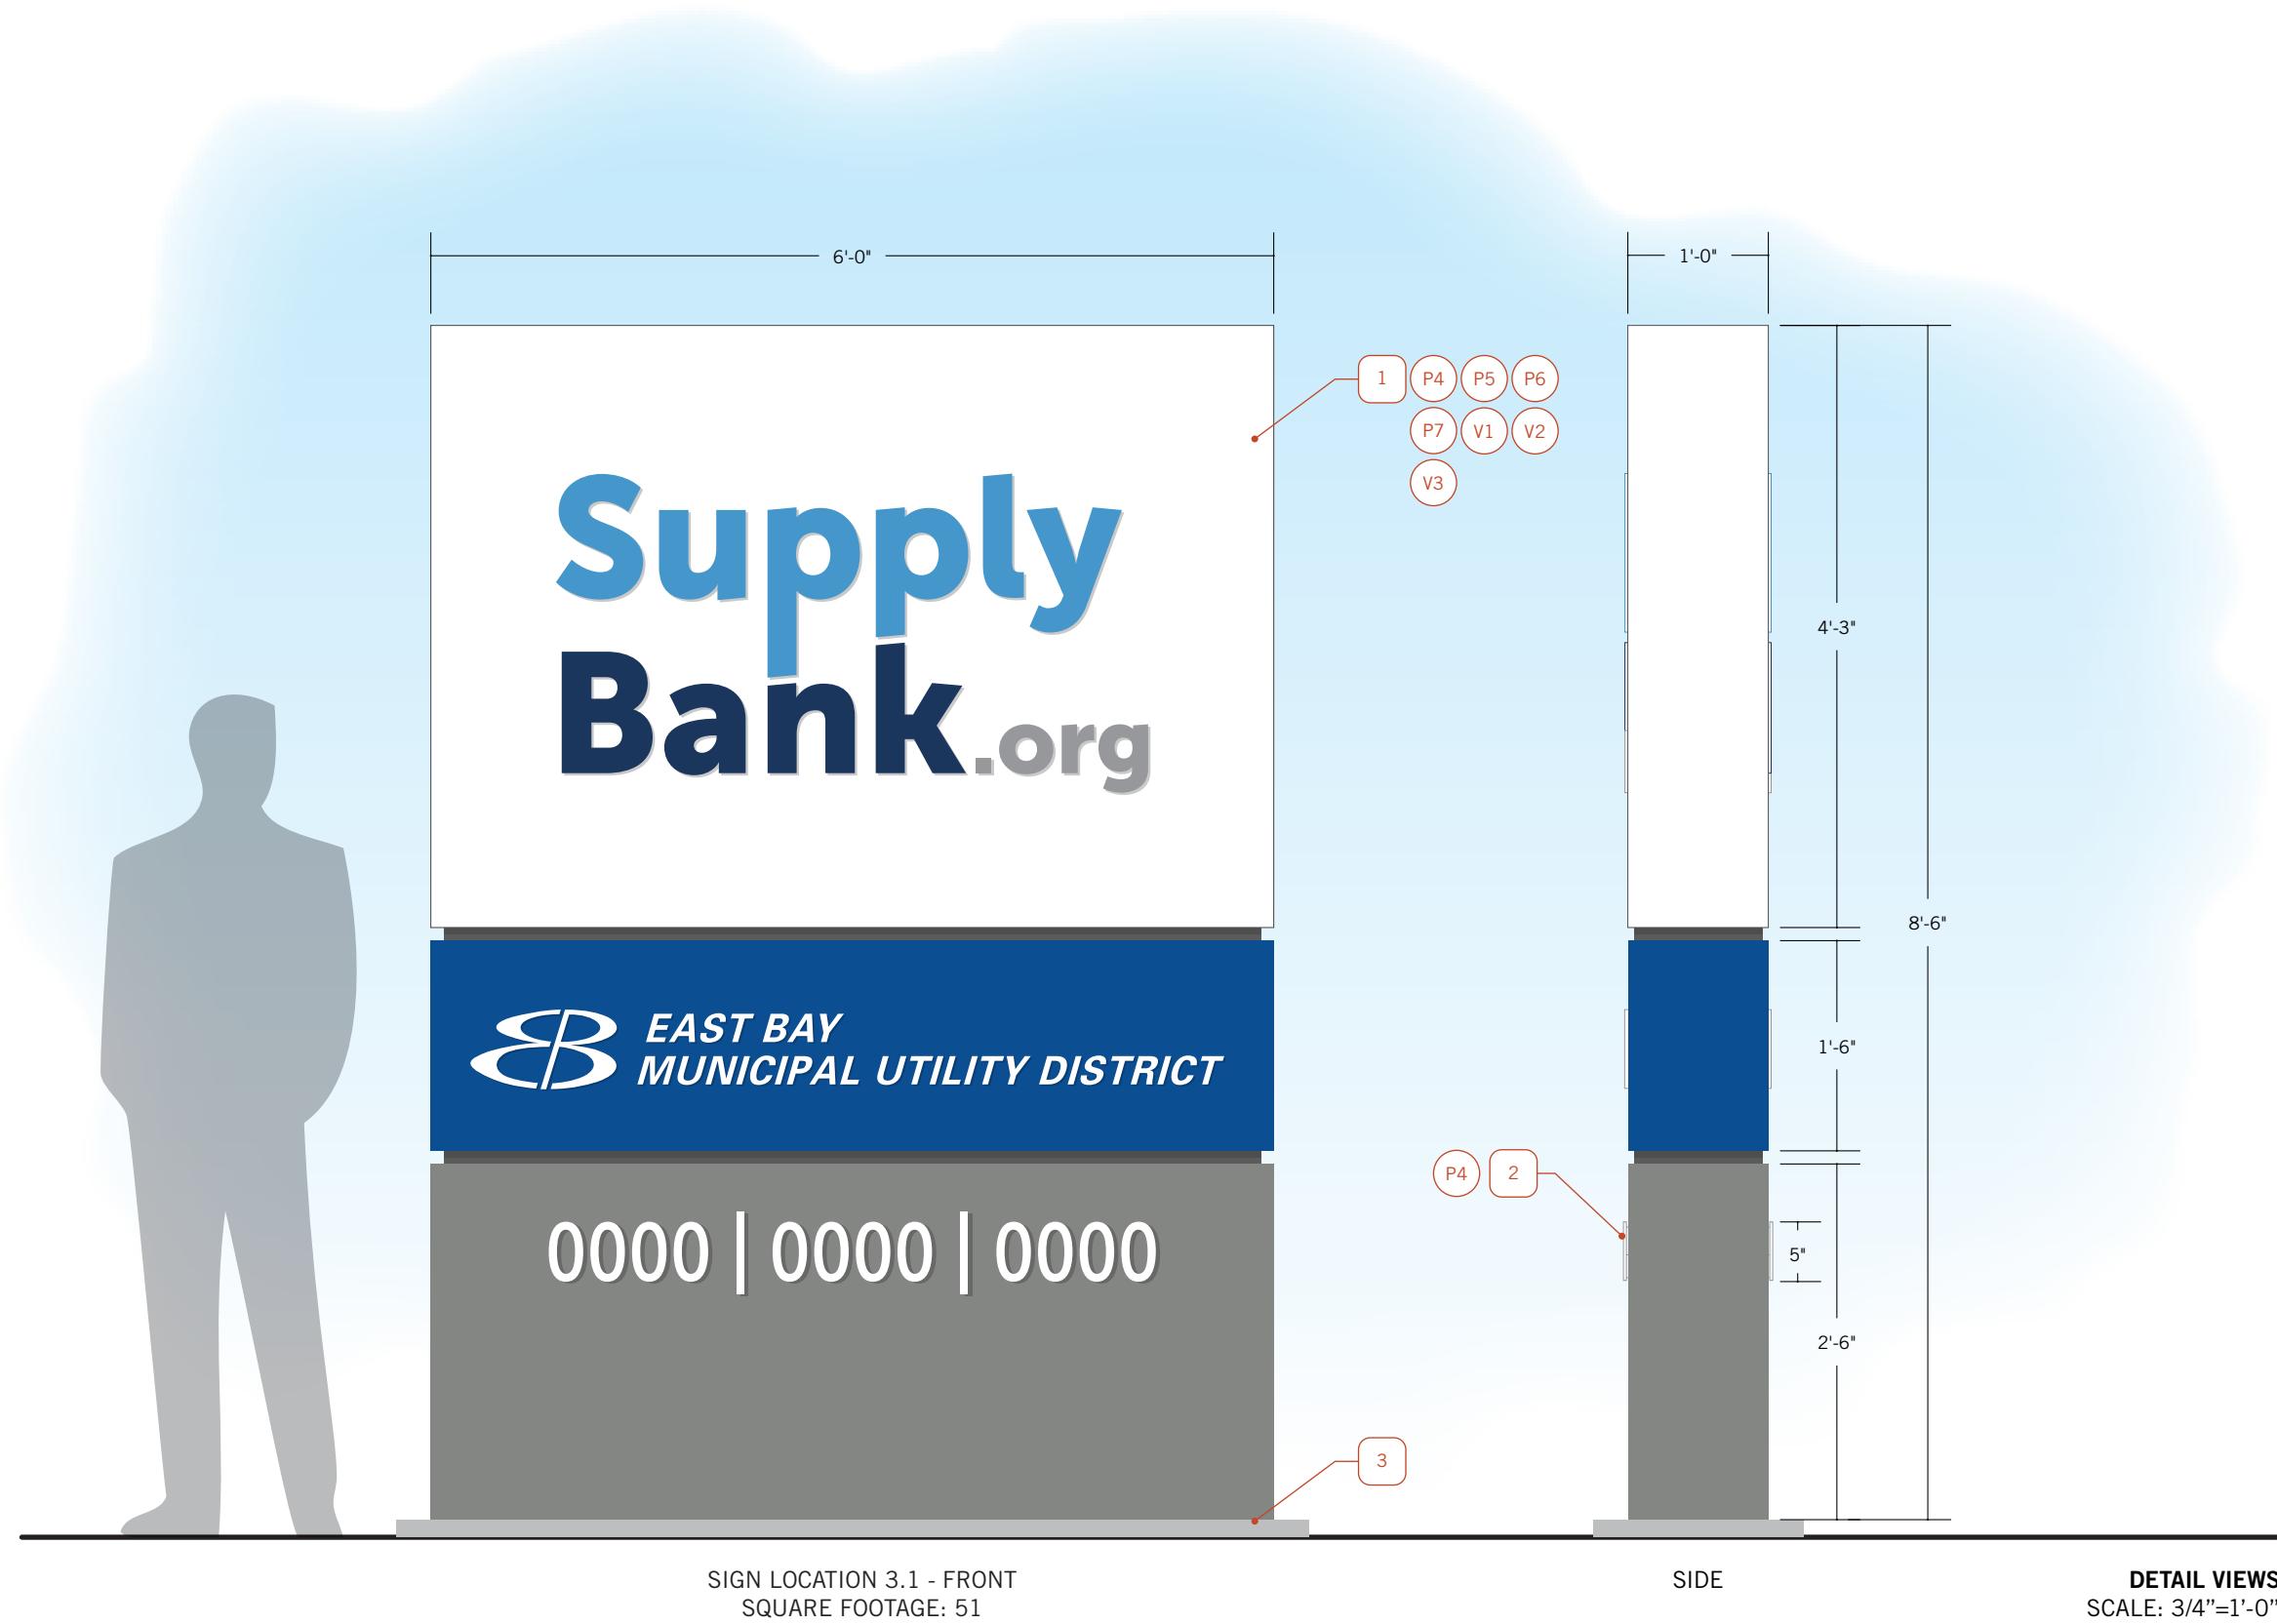

## KEY NOTES

**1** DOUBLE-SIDED, FABRICATED, SATIN PAINTED, 1/8" ALUMINUM CABINET WITH INTERNAL 6500K SLOAN LED ILLUMINATION, AND 1/4" PROUD PUSH-THRU SIGN WHITE ACRYLIC LOGO & LETTERING WITH APPLIED TRANSLUCENT VINYL.

**2** SATIN PAINTED, 1/4" THICK FLAT CUT OUT NUMERALS, PIN MOUNTED 1/8" OFF FACE OF CABINET WITH STUDS & SPACERS. STUDS & SPACERS PAINTED TO MATCH CABINET FACE.

**3** SMOOTH TROWELLED, NATURAL GRAY, CONCRETE MOWSTRIP 1 1/2" ABOVE GRADE, WITH SUB-GRADE FOOTING, PER SIGN FABRICATOR'S ENGINEERING SPECIFICATIONS.

## COLORS

- P4** MATTHEWS SATIN WHITE
- P5** MATTHEWS "HYPER BLUE"
- P6** MATTHEWS "CITYSCAPE"
- P7** MATTHEWS "PEPPERCORN"
- V1** TRANSLUCENT TO MATCH PMS 7688C
- V2** TRANSLUCENT TO MATCH PMS 534C
- V3** TRANSLUCENT TO MATCH PMS COOL GRAY 7C

